

BRENDA VILLA AQUATIC CENTER HVAC UPGRADES

5600 HARBOR STREET, COMMERCE, CA 90040

SHEET INDEX **VICINITY MAP** GENERAL SEISMIC NOTE PROJECT SUMMARY ACCORDANCE WITH SMACNA GUIDELINES PER ADDENDUM NO.1. ISSUED SEPTEMBER 2000. - PROJECT LOCATION -1.00 TITLE SHEET G-1.00 | SITE MAP C.C.R. TITLE 24, 2016 CBC SECTION 1615A.1.13 AND ASCE 7-05 SECTIONS 13.3, 13.4 & 13.6. MECHANICAL TITLE 24-NRCC FORMS ark School M−1.30 | MECHANICAL TITLE 24−NRCC FORMS NEW ANCHORAGE AND SEISMIC RESTRAINT FOR THE NEW RTU, WHICH HAS THE SAME DIMENSIONS MECHANICAL PARTIAL FIRST FLOOR PLAN AS EXISTING, BUT LESS WEIGHT. NEW SUPPORT AND ANCHORAGE OF NEW EXHAUST FANS, VAV, APPLICABLE CODES MECHANICAL PARTIAL SECOND FLOOR PLAN MECHANICAL ROOF PLAN ARCHITECTURAL DETAILS FOR PENETRATION OF EXISTING ROOF AND WALLS FOR NEW DUCTS, PIPES, AND MECHANICAL ENLARGED PLANS & SECTIONS 2016 BUILDING STANDARDS ADMINISTRATIVE CODE, PART 1, TITLE 24 C.C.R. M-4.00 MECHANICAL CONTROLS 2016 CALIFORNIA BUILDING CODE (CBC), PART 2, TITLE 24 C.C.R. M-4.01 MECHANICAL CONTROLS (2009 INTERNATIONAL BUILDING CODE VOLUMES 1-3 AND CALIFORNIA AMENDMENTS) M-5.00 MECHANICAL DETAILS 2016 CALIFORNIA ELECTRICAL CODE (CEC), PART 3, TITLE 24 C.C.R. (2008 NATIONAL ELECTRICAL CODE AND CALIFORNIA AMENDMENTS) Rosewood 2016 CALIFORNIA MECHANICAL CODE (CMC) PART 4, TITLE 24 C.C.R. Park (2009 UNIFORM MECHANICAL CODE AND CALIFORNIA AMENDMENTS) ELECTRICAL NOTES, SYMBOL LIST & ABBREVIATIONS 2016 CALIFORNIA PLUMBING CODE (CPC), PART 5, TITLE 24 C.C.R. (2009 UNIFORM PLUMBING CODE AND CALIFORNIA AMENDMENTS) ELECTRICAL PARTIAL SECOND FLOOR PLAN 2016 CALIFORNIA ENERGY CODE, PART 6, TITLE 24 C.C.R. E-2.02 ELECTRICAL ROOF PLAN 2006 CALIFORNIA ELEVATOR CODE, PART 7, TITLE 24 C.C.R. 2016 CALIFORNIA FIRE CODE PART 9, TITLE 24 C.C.R. ELECTRICAL SINGLE LINE AND PANEL SCHEDULE (2098 INTERNATIONAL FIRE CODE AND CALIFORNIA AMENDMENTS) 2016 CALIFORNIA REFERENCED STANDARDS, PART 12, TITLE 24 C.C.R. TITLE 19 C.C.R., PUBLIC SAFETY, STATE FIRE MARSHAL REGULATIONS Commerce Public Library - Rosewood (Main) PARTIAL LIST OF SECOND FLOOR PLAN APPLICABLE STANDARDS S-2.04 SECTION NFPA 13 AUTOMATIC SPRINKLER SYSTEMS NFPA 14 STANDPIPE SYSTEMS 2016 EDITION S-2.06 DETAILS 2016 EDITION NFPA 17 DRY CHEMICAL EXTINGUISHING SYSTEMS 2016 EDITION NFPA 17A WET CHEMICAL SYSTEMS NFPA 20 STATIONARY PUMPS 2016 EDITION 2016 EDITION NFPA 24 PRIVATE FIRE MAINS 2016 EDITION NFPA 72 NATIONAL FIRE ALARM CODE (CALIFORNIA AMENDED) (NOTE SEE UL STANDARD 1971 FOR "VISUAL DEVICES") NFPA 253 CRITICAL RADIANT FLUX OF FLOOR COVERING SYSTEMS **GENERAL NOTES** 2016 EDITION NFPA 2001CLEAN AGENT FIRE EXTINGUISHING SYSTEMS REFERENCE CODE SECTION FOR NFPA STANDARDS-2016 CBC (SFM) CHAPTER 35

SIMILAR REQUIREMENTS, AS STATED IN THESE GENERAL NOTES AND DISCIPLINE NOTES, MAY ALSO APPEAR IN THE GENERAL CONDITIONS AND SPECIFICATIONS. SUCH SIMILAR AND CORRESPONDING NOTES IN THE GENERAL CONDITIONS AND SPECIFICATIONS TAKE PRECEDENCE OVER THESE GENERAL NOTES AND DISCIPLINE NOTES. WHEN

1. <u>SCOPE:</u> THE CONTRACTOR SHALL FURNISH ALL MATERIALS, LABOR, EQUIPMENT, TRANSPORTATION, SCAFFOLDING, AND SERVICES NECESSARY FOR COMPLETION OF THE WORK.

THESE GENERAL NOTES AND DISCIPLINE NOTES ARE MORE STRINGENT, THEN THEY SHALL PREVAIL.

- CODES AND REGULATIONS: ALL MATERIALS AND WORK SHALL CONFORM TO THE MOST RECENT ADOPTED EDITIONS OF ALL APPLICABLE CODES AND REGULATIONS. ALL MATERIALS AND WORK SHALL MEET THE APPROVAL OF THE LOCAL JURISDICTION. WHERE THE DRAWINGS AND SPECIFICATIONS INDICATE MORE RESTRICTIVE REQUIREMENTS, THE DRAWINGS AND SPECIFICATIONS SHALL GOVERN, BUT NOTHING IN THE DRAWINGS AND SPECIFICATIONS SHALL BE INTERPRETED AS AUTHORITY TO VIOLATE ANY CODE OR REGULATION.
 PERMITS, LICENSEES, AND FEES: THE CONTRACTOR SHALL PAY FOR ALL PERMITS, LICENSES, AND FEES.
- PERMITS, LICENSEES, AND FEES: THE CONTRACTOR SHALL PAY FOR ALL PERMITS, LICENSES, AND FEES.

 4. SYMBOLS AND ABBREVIATIONS: IF THE CONTRACTOR IS UNSURE OF ANY SYMBOLS OR ABBREVIATIONS ON THE DRAWINGS, THE CONTRACTOR SHALL NOTIFY THE ENGINEER PRIOR TO PROCEEDING WITH THE WORK.
- 5. <u>NATURE OF THE DRAWINGS:</u> FOR THE PURPOSE OF CLARITY AND LEGIBILITY, THE DRAWINGS ARE ESSENTIALLY DIAGRAMMATIC. ALTHOUGH SIZES AND LOCATION OF EQUIPMENT ARE DRAWN TO SCALE WHEREVER POSSIBLE, THE CONTRACTOR SHALL MAKE USE OF ALL DATA IN ALL OF THE CONTRACT DOCUMENTS, AND VERIFY THIS INFORMATION BEFORE ORDERING, FABRICATING, OR INSTALLING OF ANY MATERIALS.
- PRECEDENCE: WRITTEN DIMENSIONS TAKE PRECEDENCE OVER SCALED DIMENSIONS. LARGE SCALE DETAILS TAKE PRECEDENCE OVER SMALLER SCALE DETAILS. SPECIFICATIONS TAKE PRECEDENCE OVER DRAWINGS.
 FIELD VERIFICATION: ALL EXISTING STRUCTURES, EQUIPMENT, DUCTWORK, PIPING, AND CONDUITS ARE NOT SHOWN IN THESE DRAWINGS. BEFORE BIDDING AND BEFORE BEGINNING ANY WORK, THE CONTRACTOR SHALL THOROUGHLY EXAMINE AND VERIFY ALL EXISTING CONDITIONS, DIMENSIONS, POINTS OF CONNECTION, SIZES, LOCATIONS, INTERFERENCES, ETC. ALL NECESSARY ADJUSTMENTS REQUIRED TO FACILITATE THE NEW INSTALLATION SHALL BE MADE BY THE CONTRACTOR AT NO ADDITIONAL COST TO THE OWNER.
- 8. <u>DISCREPANCIES:</u> THE CONTRACTOR SHALL BRING TO THE ATTENTION OF THE ENGINEER, IN WRITING, ANY DISCREPANCIES BETWEEN EXISTING CONDITIONS AND THE CONTRACT DOCUMENTS, AND ANY CONFLICTS WITHIN THE CONTRACT DOCUMENTS. THIS SHALL BE DONE PRIOR TO THE START OF CONSTRUCTION IN EACH AREA SO ANY NECESSARY CLARIFICATIONS CAN BE ISSUED.
- 9. <u>SUBMITTALS:</u> THE CONTRACTOR SHALL MAKE SUBMITTALS ON EQUIPMENT AND OTHER ITEMS REQUIRING SUBMITTALS, AND SHALL RECEIVE APPROVALS ON THE SUBMITTALS, PRIOR TO PURCHASE OR INSTALLATION.
- 10. COORDINATION: PRIOR TO FABRICATION AND INSTALLATION, THE CONTRACTOR SHALL BE RESPONSIBLE FOR COORDINATING HIS OR HER WORK WITH ALL OTHER TRADES AND THE GENERAL CONTRACTOR. THIS INCLUDES COORDINATING THE LOCATION AND SIZE OF ALL OPENINGS, LOCATIONS OF EQUIPMENT PADS AND CHANGES OF ELEVATIONS OF DUCTWORK, PIPING AND OTHER EQUIPMENT. IT INCLUDES COORDINATING WITH THE ELECTRICAL CONTRACTOR FOR ELECTRICAL REQUIREMENTS OF ALL MECHANICAL EQUIPMENT. THE CONTRACTOR SHALL COORDINATE THE LOCATION OF ALL CEILING DIFFUSERS, REGISTERS AND GRILLES WITH THE EXISTING EQUIPMENT, FIXTURES AND LIGHTING.

- 11. WORK SCHEDULING AND INTERRUPTIONS: THE CONTRACTOR SHALL OBTAIN WRITTEN APPROVAL FROM THE OWNER BEFORE BEGINNING WORK IN ANY EXISTING AREA, OR BEFORE WORKING ON ANY EXISTING EQUIPMENT. THE CONTRACTOR SHALL INDICATE TO THE OWNER, THE PARTICULAR AREA IN WHICH WORK WILL BE DONE AND THE PARTICULAR EQUIPMENT TO BE WORKED ON ALONG WITH THE DURATION OF TIME ANY SYSTEM WILL BE OUT OF SERVICE. SUCH WORK WILL BE SCHEDULED IN SUCH A MANNER SO AS NOT TO DISRUPT PRESENT OPERATIONS, IF POSSIBLE. FOR INTERRUPTION OF PRESENT OPERATIONS, THE CONTRACTOR SHALL OBTAIN A LETTER OF APPROVAL FROM THE OWNER, CITING AREAS, DATES, HOURS OF THE DAY, AND DURATION INTERRUPTION IS TO TAKE PLACE.
- 12. <u>CONSTRUCTION BARRIERS AND PASSAGES:</u> THE CONTRACTOR SHALL PROVIDE ADEQUATE BARRICADES AND PROTECTIVE DEVICES SEPARATING CONSTRUCTION AREAS. TEMPORARY PASSAGES SHALL BE PROVIDED AS REQUIRED.
- 13. <u>DEMOLITION:</u> THE CONTRACTOR SHALL DEMOLISH AND REMOVE EXISTING CONSTRUCTION AS NECESSARY TO INSTALL NEW CONSTRUCTION AS SHOWN.
 14. SALVAGE: THE CONTRACTOR HAS SALVAGE RIGHTS TO ALL DEMOLISHED COMPONENTS AND EQUIPMENT.
- SALVAGE RIGHTS SHALL BE REFLECTED IN THE BID PROPOSAL TO THE OWNER BY WAY OF BID COST REDUCTION. THE OWNER DOES NOT WANT ANY DEMOLISHED COMPONENTS OR EQUIPMENT BACK.

 15. WASTE REMOVAL: REMOVE AND DISPOSE OF, ON A REGULAR BASIS, ALL RUBBISH AND WASTE MATERIALS CENERATED BY THE CONTRACTOR AND ALL SUBCONTRACTORS AND TRADERS BURBISH
- MATERIALS GENERATED BY THE CONTRACTOR AND ALL SUBCONTRACTORS AND TRADERS. RUBBISH AND WASTE MATERIALS SHALL NOT ACCUMULATE IN THE BUILDING(S) OR ON THE SITE. DISPOSE OF RUBBISH AND WASTE MATERIALS IN ACCORDANCE WITH ALL APPLICABLE ORDINANCES AND REGULATIONS.

 16. PROTECTION, REPAIR, AND RESTORATION OF EXISTING: THE CONTRACTOR SHALL PROTECT AND
- AS A RESULT OF DEMOLITION AND/OR NEW WORK. CONTRACTOR SHALL NOT DEMOLISH OR ALTER ANY WORK WHICH IS NOT PART OF THIS CONTRACT WITHOUT WRITTEN PERMISSION OF THE OWNER.

 17. PROTECTION AND REPAIR OF NEW WORK: THE CONTRACTOR SHALL TAKE ALL PRECAUTIONS NECESSARY TO PROTECT THE MATERIALS BEFORE, DURING AND AFTER INSTALLATION. IN THE EVENT

REPAIR ADJACENT EXISTING SURFACES, AREAS, PIPING, AND EQUIPMENT WHICH MAY BE DAMAGED

OF DAMAGE, THE CONTRACTOR SHALL IMMEDIATELY REPAIR ALL DAMAGED AND DEFECTIVE WORK TO

- THE APPROVAL OF THE ENGINEER AND AT NO ADDITIONAL COST TO THE OWNER.

 18. MATERIALS: ALL MATERIAL, EQUIPMENT, FIXTURES, ETC. SHALL BE NEW, UNLESS OTHERWISE NOTED, AND OF THE BEST GRADE OF THE RESPECTIVE KIND, FREE FROM ALL DEFECTS. ANY MATERIAL, ARTICLE OR PIECE OF EQUIPMENT OTHER THAN THAT INDICATED SHALL NOT BE USED UNLESS APPROVED IN WRITING BY THE ENGINEER, AND ANY CHANGES IN MECHANICAL, ELECTRICAL AND/OR
- CONTRACTOR, AND AT NO ADDITIONAL COST TO THE OWNER.

 19. <u>SEISMIC ANCHORGE:</u> THE SEISMIC ANCHORAGE OF MECHANICAL AND ELECTRICAL EQUIPMENT SHALL CONFORM TO C.C.R. TITLE 24, 2016 CBC SECTION 1614A.1.13 AND ASCE 7-05. SECTION 13.2, 13.4, 13.6 AND CHAPTER 6. ANCHORAGE DETAILS FOR ROOF/FLOOR MOUNTED EQUIPMENT

SHALL BE SHOWN ON PLANS.

OTHER SYSTEMS REQUIRED DUE TO SUCH SUBSTITUTION SHALL BE THE RESPONSIBILITY OF THE

- 20. MATERIALS UNIFORMITY: MATERIALS FOR SIMILAR USE SHALL BE OF THE SAME TYPE AND MANUFACTURER, UNLESS OTHERWISE SPECIFIED.

 21. SEALING OF OPENINGS: ALL FLOOR, WALL, AND CEILING OPENINGS REQUIRED FOR PIPES, DUCTS, CONDUITS, AND SIMILAR ITEMS SHALL BE SEALED; UNLESS OTHERWISE PROTECTED WITH A TWO—HOUR FIRE RESISTIVE ENCLOSURE (ONE—HOUR FOR ONE—HOUR BUILDINGS).
- 22. <u>STRUCTURAL MEMBERS:</u> UNLESS SPECIFICALLY SHOWN ON THESE PLANS NO STRUCTURAL MEMBER SHALL BE CUT, NEITHER DRILLED OR NOTCHED WITHOUT PRIOR WRITTEN AUTHORIZATION FROM THE STRUCTURAL ENGINEER.
- 23. <u>WIRING: RESPONSIBILITY DISTINCTION:</u> THE GENERAL CONTRACTOR SHALL SUPERVISE THE FOLLOWING WIRING RESPONSIBILITY DISTINCTION. CONTROL LOW VOLTAGE WIRING, CONDUIT & CONNECTION SHALL BE BY MECHANICAL CONTRACTOR. LINE VOLTAGE WIRING, CONDUIT, DISCONNECT SWITCHES, AND CONNECTION SHALL BE BY ELECTRICAL CONTRACTOR.
- 24. <u>MANUFACTURER'S INSTALLATION RECOMMENDATIONS:</u> ALL EQUIPMENT SHALL BE INSTALLED IN STRICT ACCORDANCE WITH THE EQUIPMENT MANUFACTURER'S RECOMMENDATIONS. PROVIDE ALL FITTINGS, OFFSETS, TRANSITIONS, DAMPERS, VALVES AND OTHER DEVICES REQUIRED FOR A COMPLETE WORKABLE INSTALLATION.
- 25. <u>TESTING AND OPERATION:</u> THE CONTRACTOR SHALL TEST, ADJUST, AND PLACE IN PROPER OPERATING CONDITION ALL SYSTEMS INSTALLED UNDER THE WORK OF THIS CONTRACT.
- 26. OPERATION AND MAINTENANCE MANUALS: THE CONTRACTOR SHALL SUBMIT FOUR SETS OF OPERATING AND MAINTENANCE MANUALS TO THE OWNER UPON COMPLETION OF THE PROJECT.
- 27. <u>AS-BUILT DRAWINGS:</u> THE CONTRACTOR SHALL MAINTAIN ACCURATE AS—BUILT DRAWINGS DURING CONSTRUCTION AND SHALL SUBMIT THEM FOR APPROVAL UPON COMPLETION OF INSTALLATION.
- 28. <u>WARRANTY:</u> IN ADDITION TO EQUIPMENT WARRANTIES, THE CONTRACTOR SHALL FURNISH A WRITTEN WARRANTY AGAINST DEFECTS IN MATERIALS AND WORKMANSHIP FOR ONE YEAR AFTER OWNER'S ACCEPTANCE OF THE PROJECT. THE WARRANTY SHALL INCLUDE LABOR AND MATERIALS FOR REPAIR OF DAMAGE TO, OR REPLACEMENT OF, ANY PART OF DEFECTIVE OR DAMAGED EQUIPMENT OR ITEM.
- 29. DEMOLITION, CONSTRUCTION OR ALTERATIONS SHALL BE IN COMPLIANCE OF 2007

CFC, ARTICLE 87.

- 30. PROVIDING SUPPORTS: PROVIDE AND INSTALL ALL NECESSARY BACKING, BLOCKING, FRAMING, HANGERS OR OTHER SUPPORT REQUIRED FOR THE INSTALLATION OF FIXTURES, EQUIPMENT, CABINETRY, FURNISHINGS, AND ALL OTHER ITEMS REQUIRED THE SAME. COORDINATE THE SIZE, LOCATION, AND INSTALLATION OF BACKING, BLOCKING, FRAMING, HANGERS, AND OTHER SUPPORT AMONG THE RESPECTIVE SUBCONTRACTORS AND TRADES.
- 31. <u>FIRE DEPARTMENT VEHICLE ACCESS:</u> FIRE DEPARTMENT VEHICLE ACCESS SHALL BE PROVIDED AND MAINTAINED SERVICEABLE TO ALL BUILDINGS ON THE SITE AND THROUGHOUT THE ENTIRE SITE DURING THE ENTIRE TIME OF CONSTRUCTION.

32. CHANGES TO THE APPROVED DRAWINGS AND SPECIFICATIONS SHALL BE MADE BY ADDENDA OR CHANGE ORDERS APPROVED BY THE OWNER.

33. ANY SUBSTITUTION BY THE CONTRACTOR OVER THE BASIS OF DESIGN INDICATES
THAT THE CONTRACTOR IS RESPONSIBLE FOR THE COST OF REDESIGN AND CONFIGURATION OF
EQUIPMENT, DUCTS, PIPES, CONDUITS, WIRING AND INSTALLATION. SUBMIT SUBSTITUTION REQUEST
FORM PRIOR TO RIDDING FOR APPROVAL

34. THESE CONTRACT DOCUMENTS ARE NOT COMPLETE WITHOUT DIVISION 00 AND DIVISION 01 SPECIFICATIONS. THE CONTRACTOR SHALL REQUEST EDITED DIVISION 00 AND DIVISION 01 SPECIFICATION SECTIONS FROM OWNER'S REPRESENTATIVE, PRIOR TO BIDDING, IF THEY ARE NOT CHERENTLY PROVIDED.

35. DISCREPANCIES: CONTRACTOR SHALL BE TASKED TO NOTIFY AND SEEK CLARIFICATIONS FROM THE OWNER'S REPRESENTATIVE OF DISCREPANCIES WITHIN BID DOCUMENTS, PRIOR TO SUBMITTING BIDS.



BRENDA VILLA
AQUATIC CENTER
HVAC UPGRADES

5600 HARBOR STREET COMMERCE, CA 90040



811 WILSHIRE BLVD., SUITE 10 LOS ANGELES, CA 90017 TEL: (213) 873-4700 FAX: (213) 873-4790 www.owengroup.com

STAMPS/SEALS



ADDDOVAL

EVISION DESCRIPTION DATE
100% CDs 10/02/1

TITLE SHEET


HOA PROJECT NO.: 0817.2117.01 PROJECT ARCH: R.H.


CHECKED: R.H.

SHEET NUMBER

T-1.00

SHEET: OF

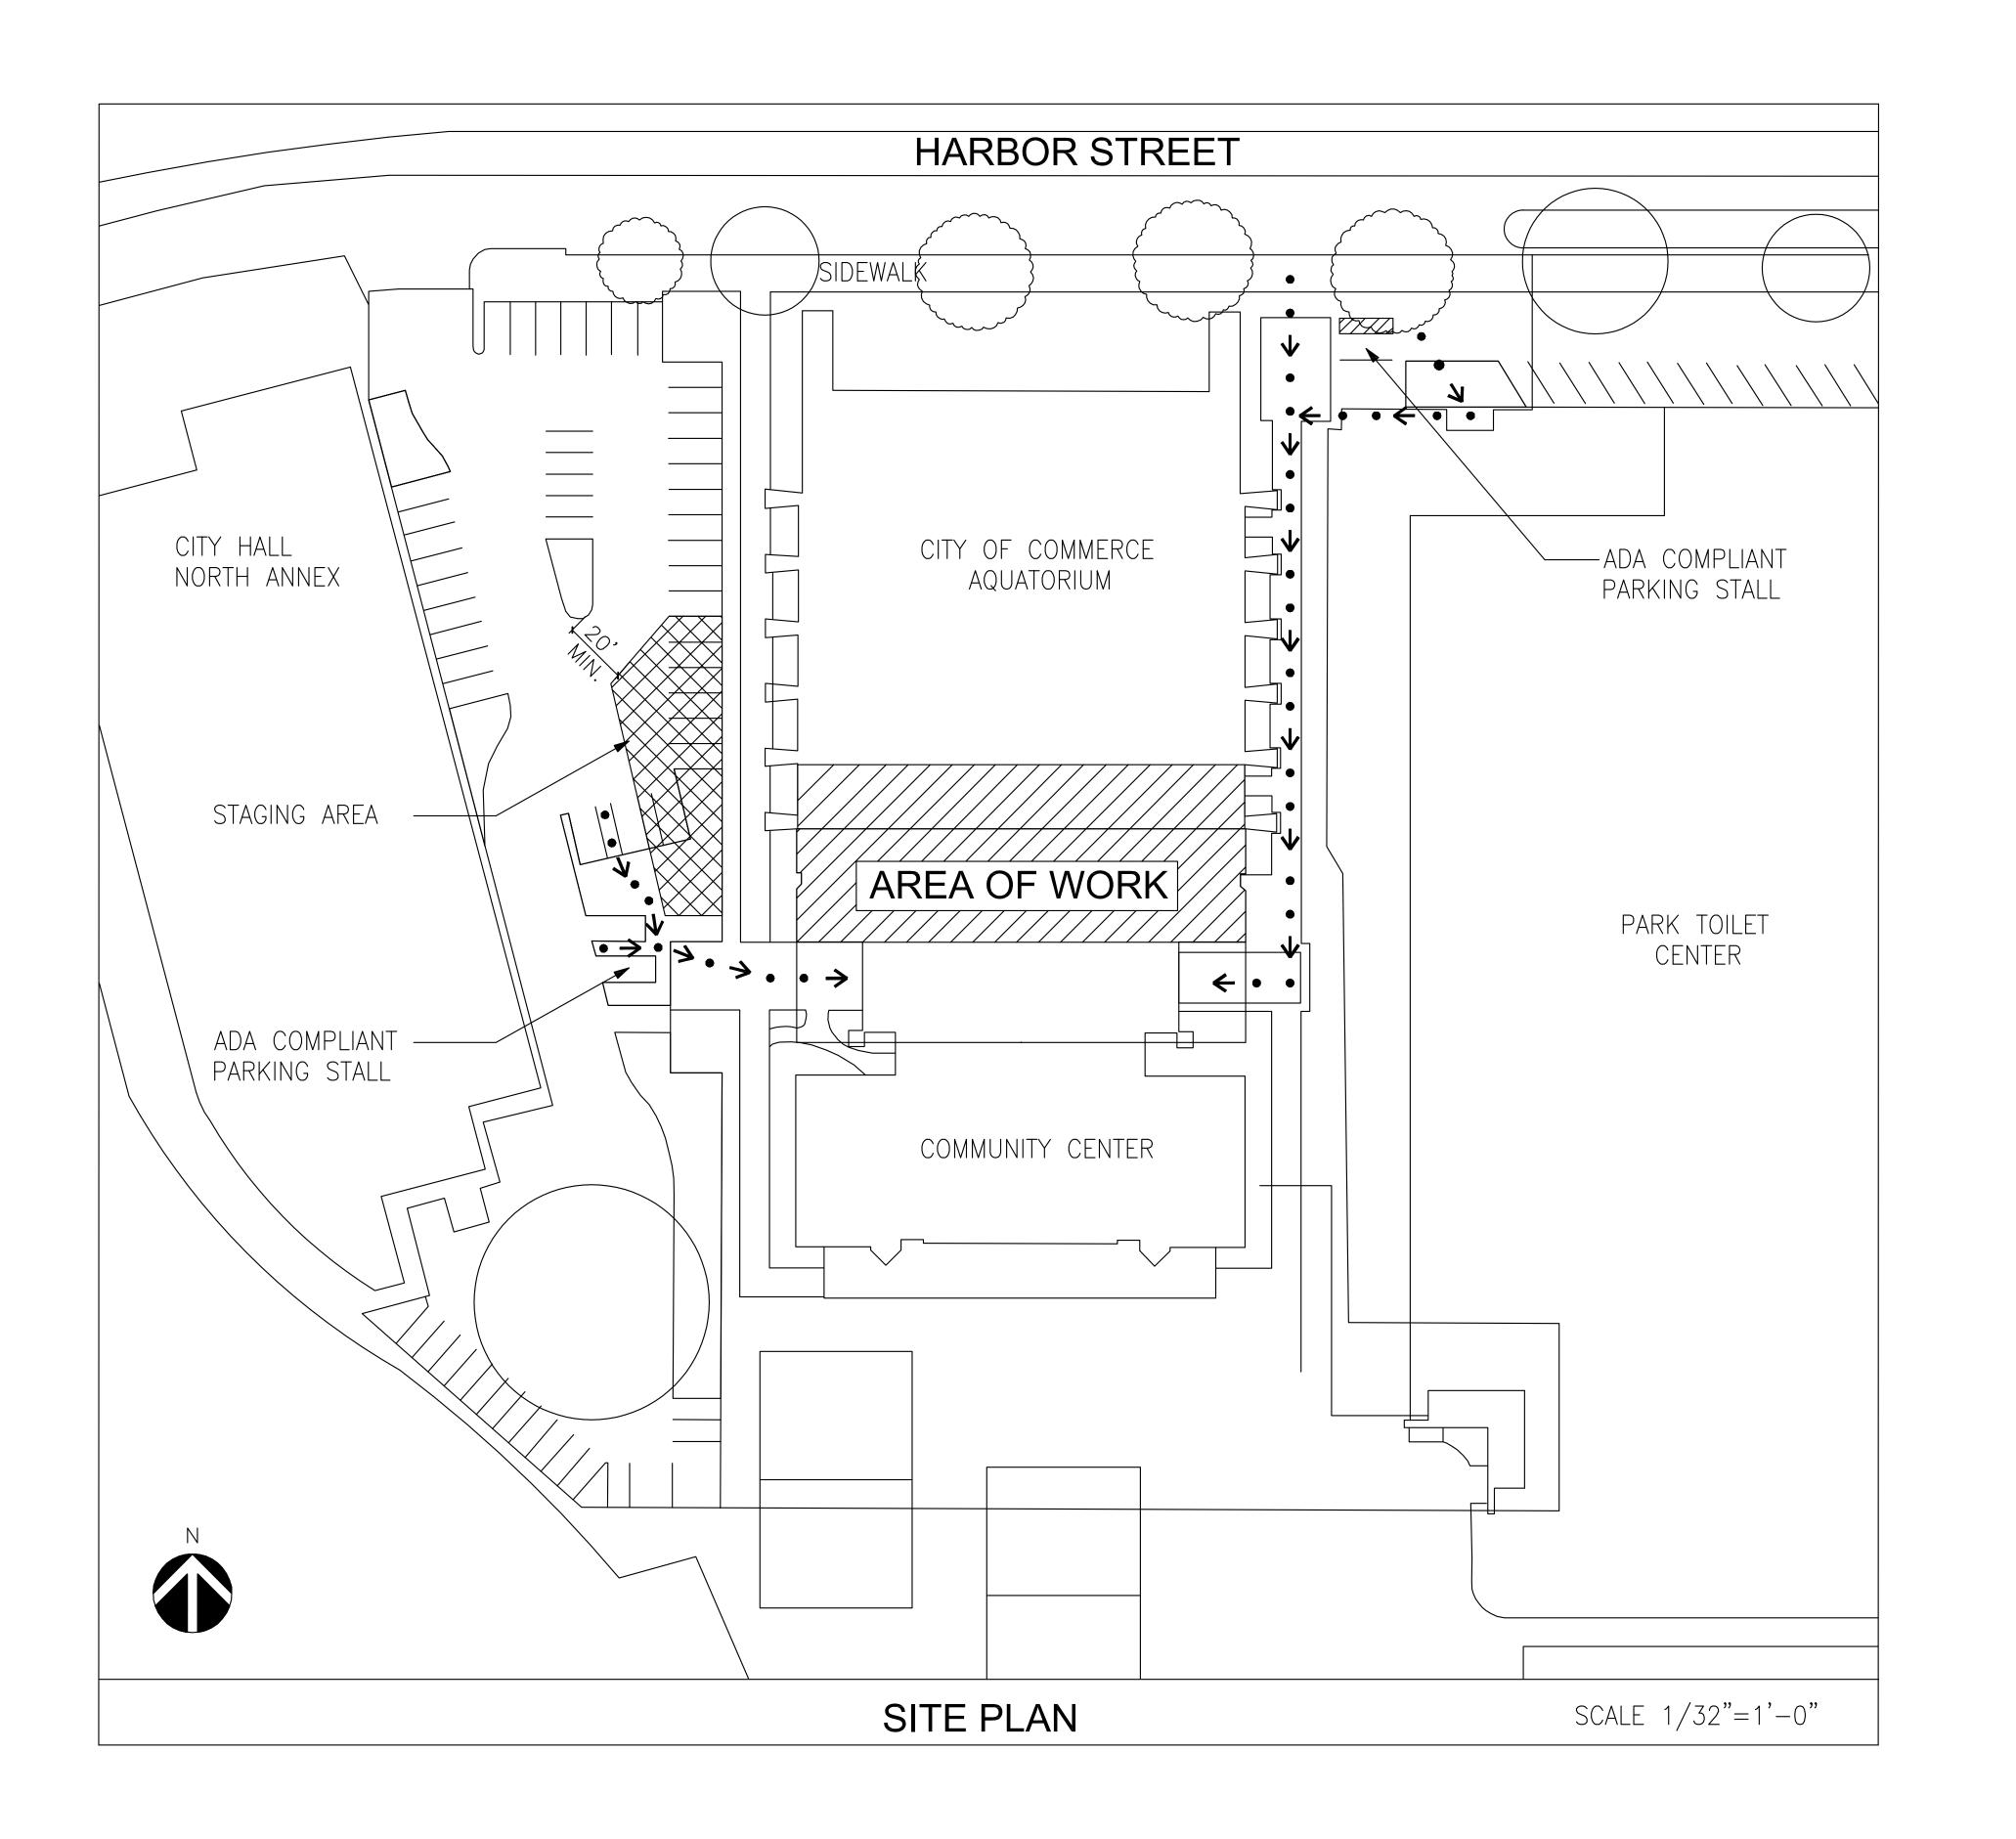

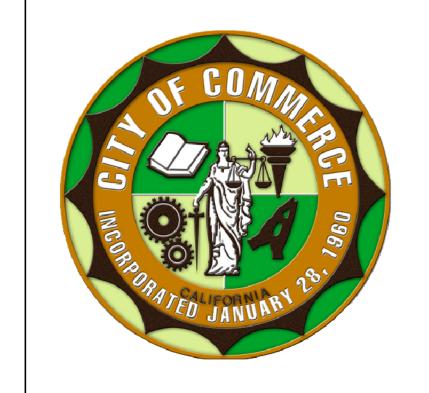

PROJECT TITLE AND LOCATION BRENDA VILLA AQUATIC CENTER HVAC UPGRADES

5600 HARBOR STREET COMMERCE, CA 90040



811 WILSHIRE BLVD. , SUITE 1050 LOS ANGELES, CA 90017 TEL: (213) 873-4700 FAX: (213) 873-4790 www.owengroup.com

STAMPS/SEALS




REVISION	DESCRIPTION	DAT
	100% CDs	DAT 10/02
SHEET TITLE:		


SITE MAP

HOA PROJECT NO.: 0817.2117.01 PROJECT ARCH: R.H.

DRAWN: CHECKED:

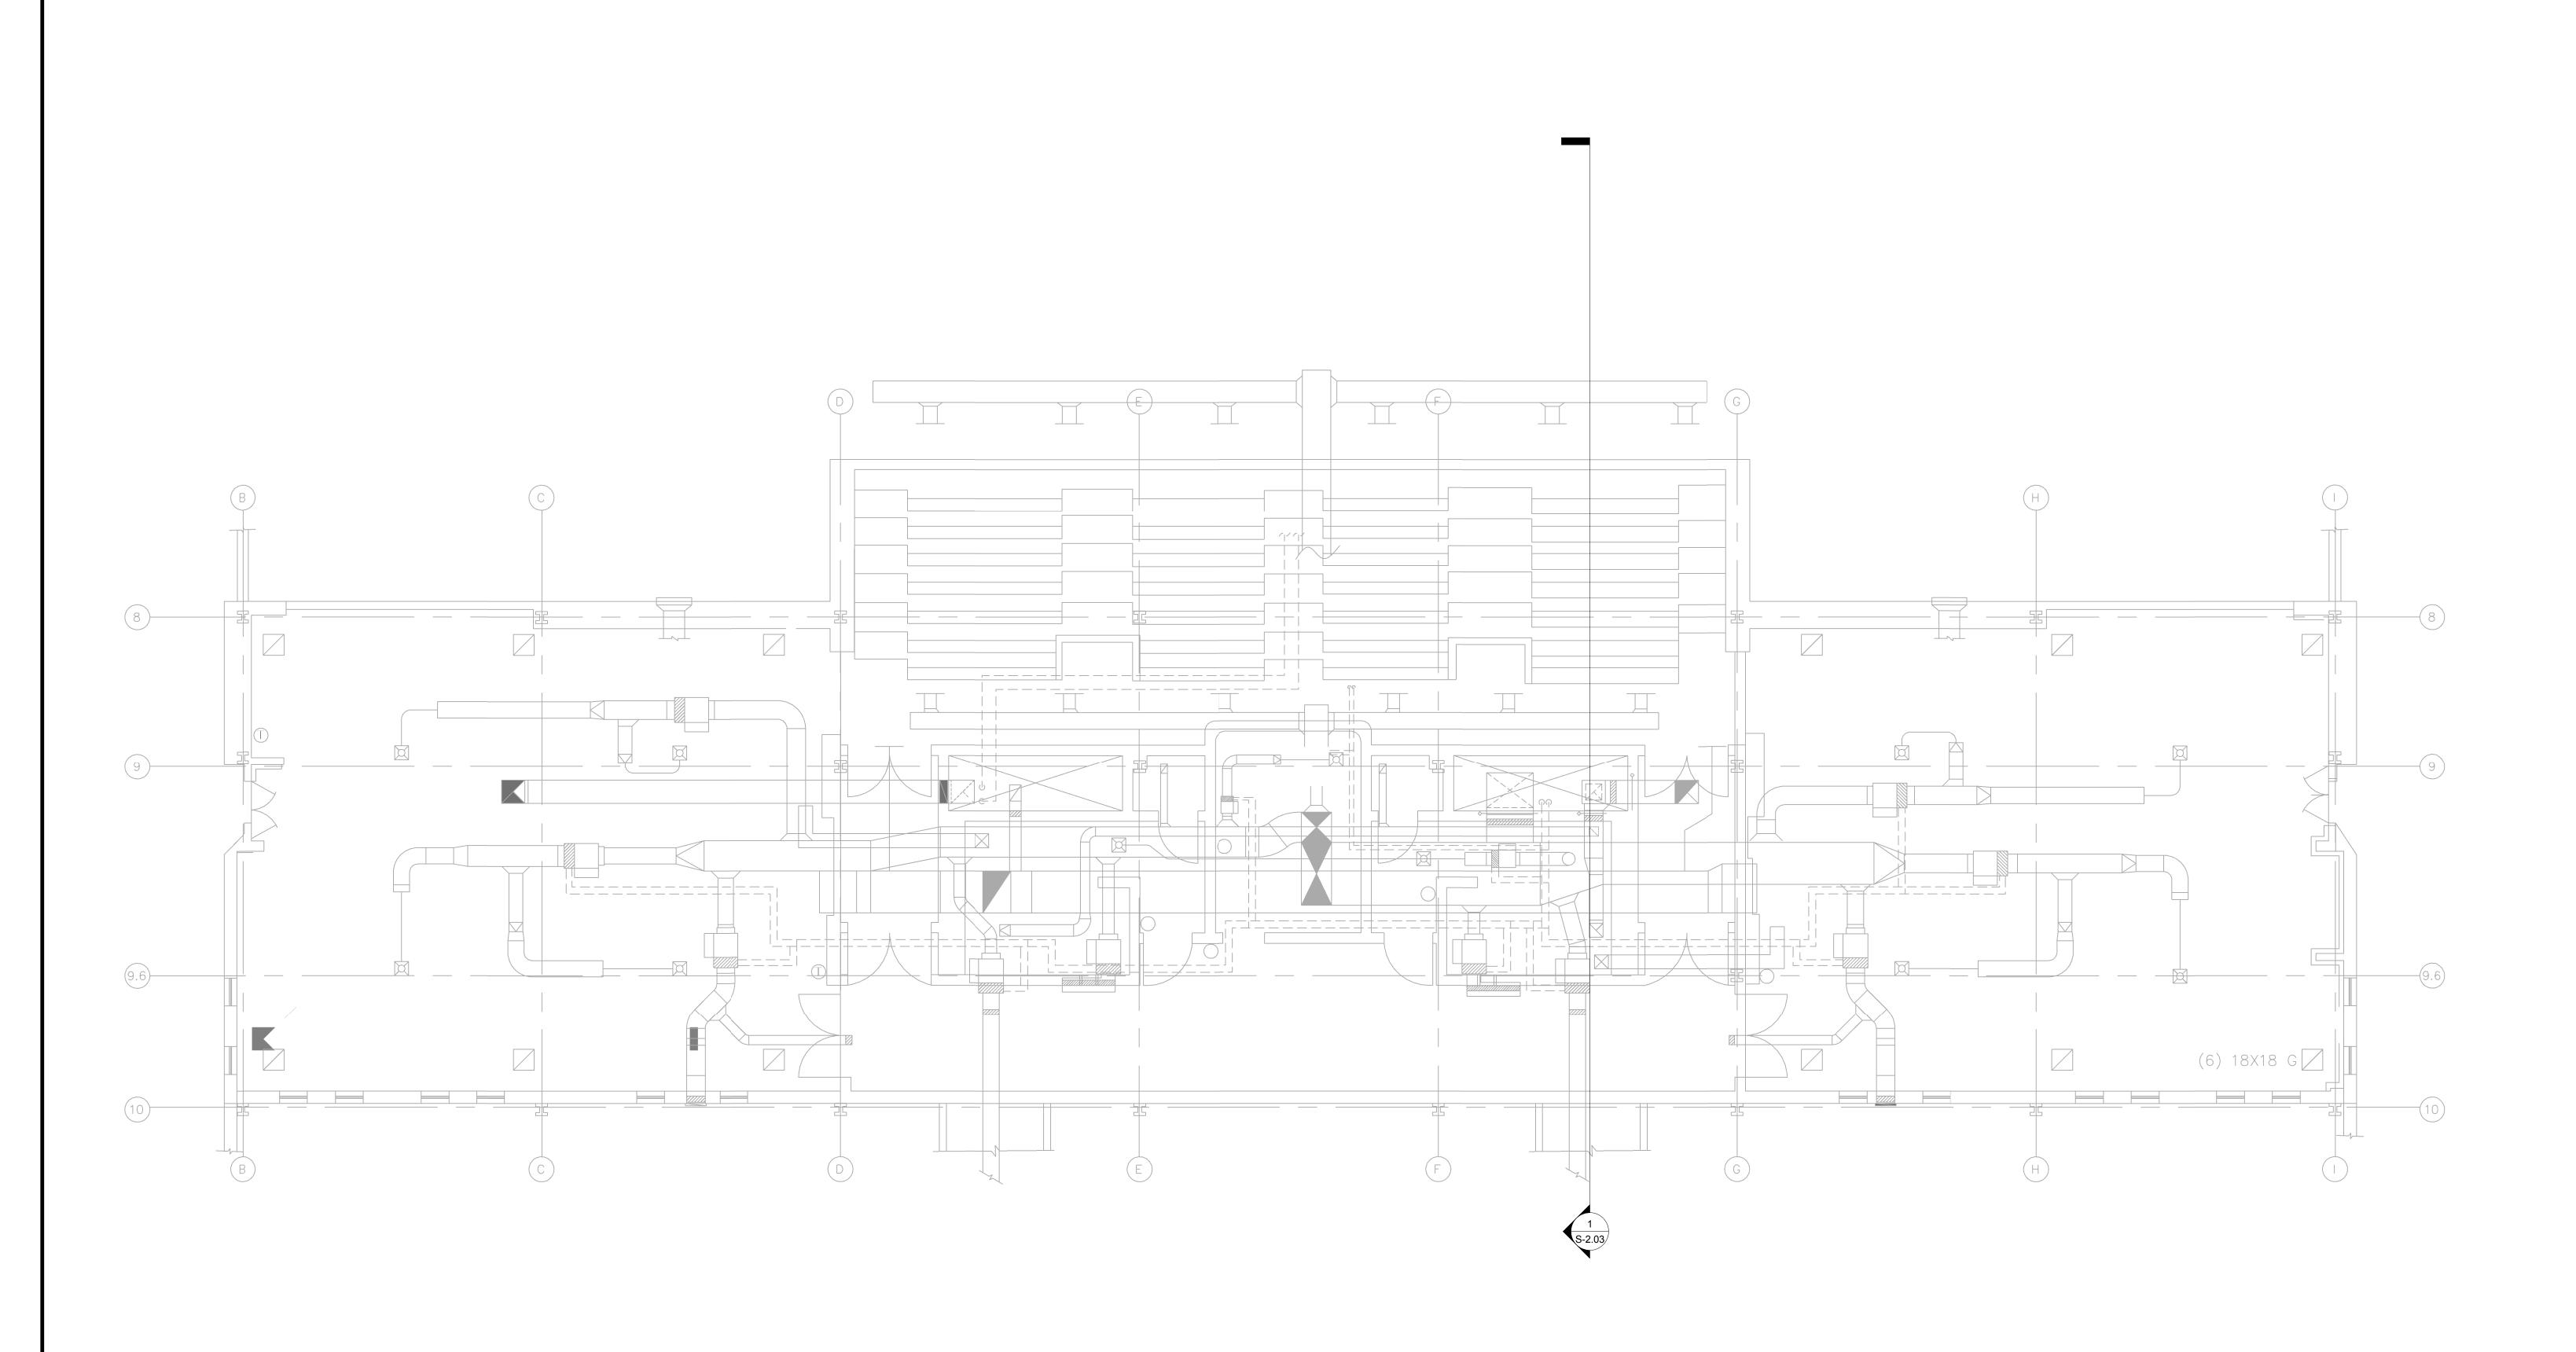



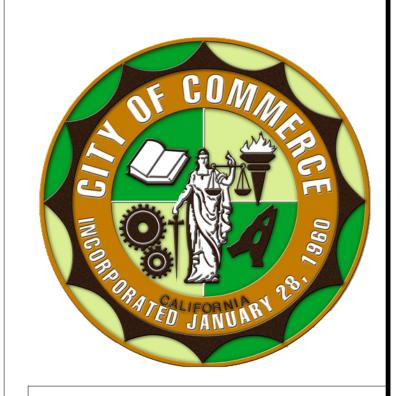

BRENDA VILLA
AQUATIC CENTER
HVAC UPGRADES

5600 HARBOR STREET COMMERCE, CA 90040



STAMPS/SEALS




APPRO

REVISION	DESCRIPTION	DATE
	100% CDS	10/02/


SECOND FLOOR PLAN

HOA PROJECT NO.: 0817.2117.01 PROJECT ARCH: R.H.

S-1.01

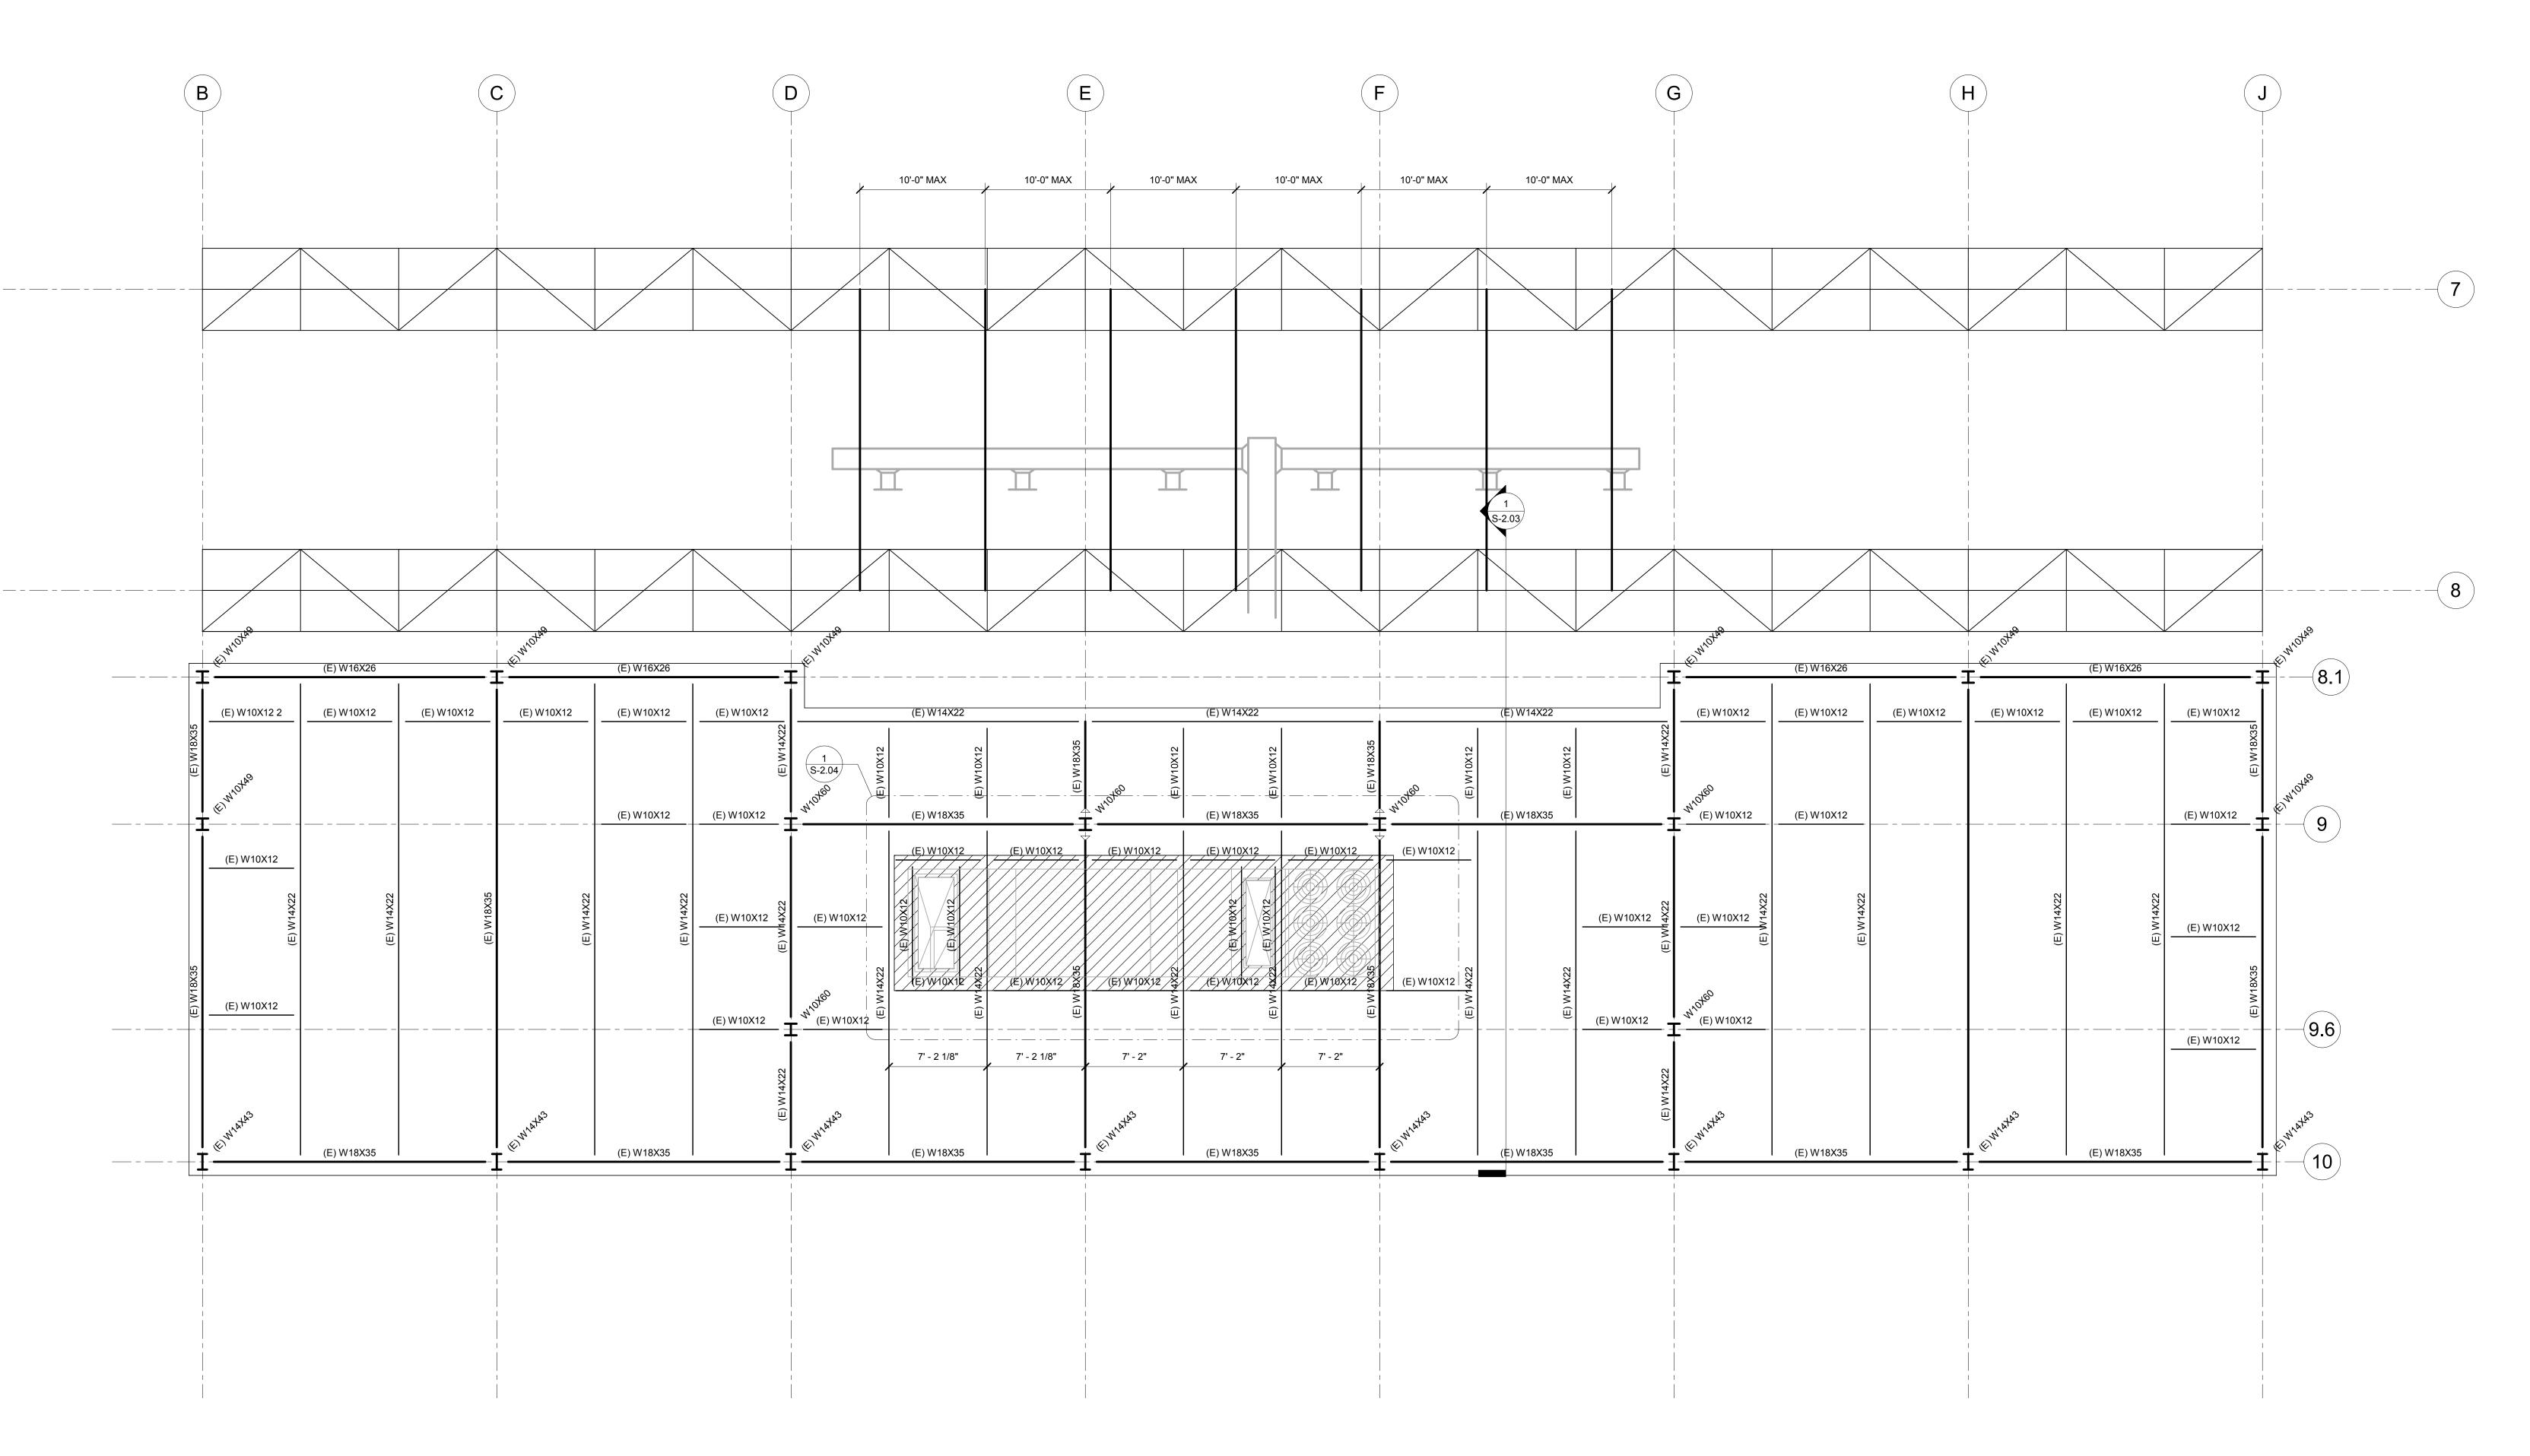

ROOF
Scale: 3/16" = 1'-0" Ref:

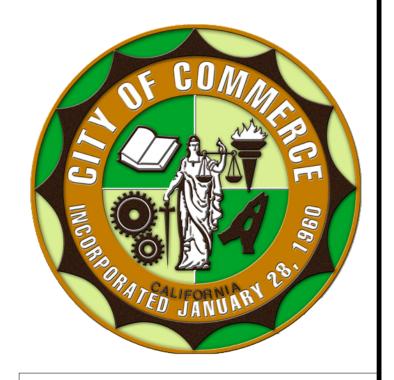

BRENDA VILLA
AQUATIC CENTER
HVAC UPGRADES

5600 HARBOR STREET COMMERCE, CA 90040



STAMPS/SEALS



APPR(

REVISION	DESCRIPTION	DATE
	100% CDS	10/02/


ROOF PLAN

HOA PROJECT NO.: 0817.2117.01 PROJECT ARCH: R.H.


DRAWN: CHECKED: R.P.

S-1.02

SHEET: OI

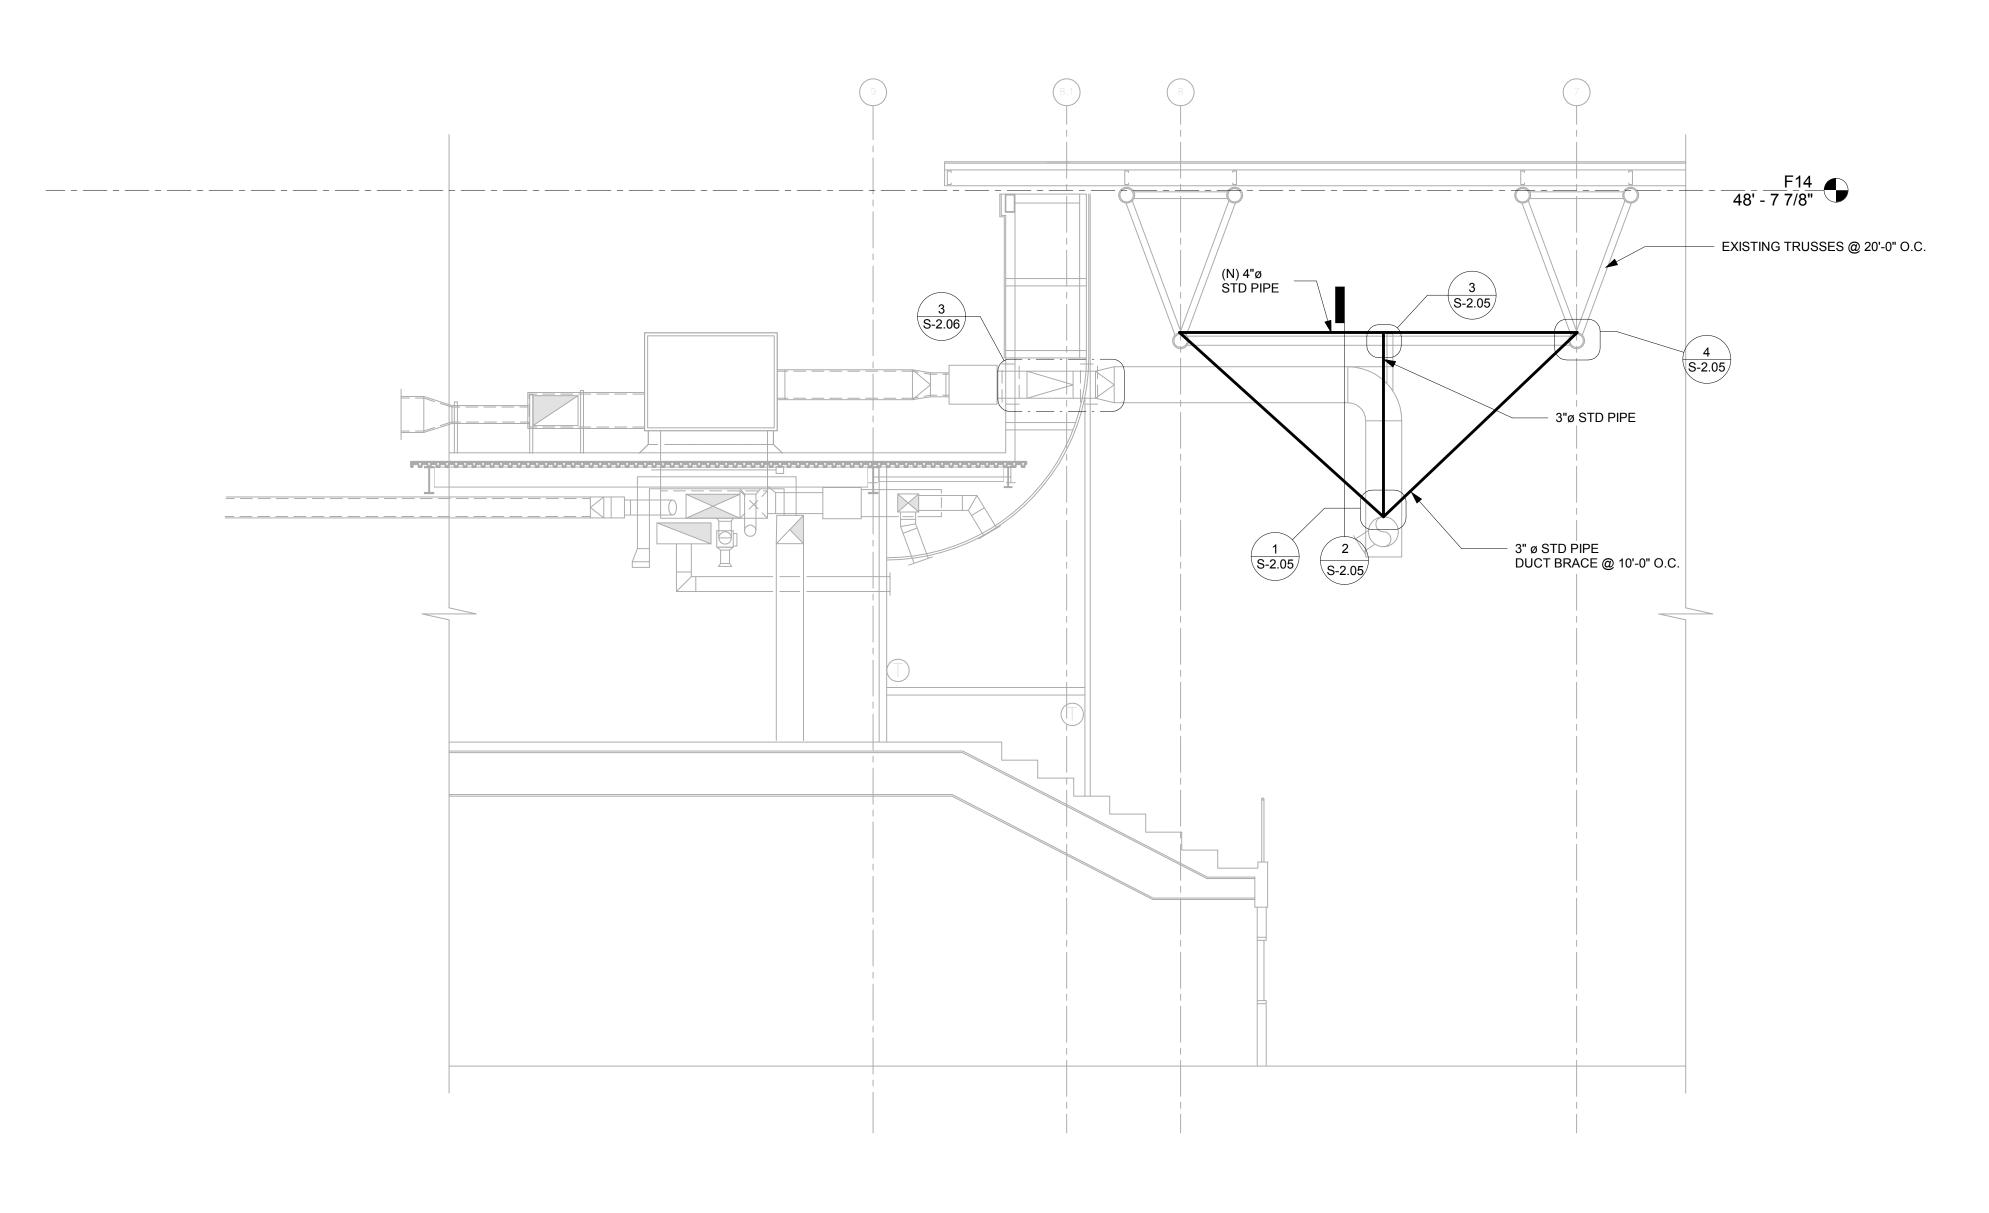

Section 2
Scale: 3/16" = 1'-0" Ref: S-1.01

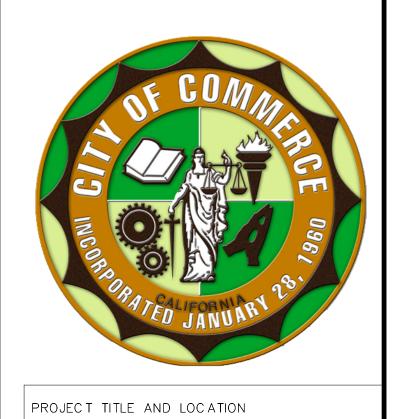

BRENDA VILLA AQUATIC CENTER HVAC UPGRADES

5600 HARBOR STREET COMMERCE, CA 90040



811 WILSHIRE BLVD., SUITE 1050 LOS ANGELES, CA 90017 TEL: (213) 873-4700 FAX: (213) 873-4790 www.owengroup.com

STAMPS/SEALS



APPRO

EVISION	DESCRIPTION	DATE
	100% CDS	10/02/18
HEET TITLE:		


SECTION


HOA PROJECT NO.: 0817.2117.01 PROJECT ARCH: R.H.


DRAWN: CHECKED: R.P.


S-2.03


SHEET:

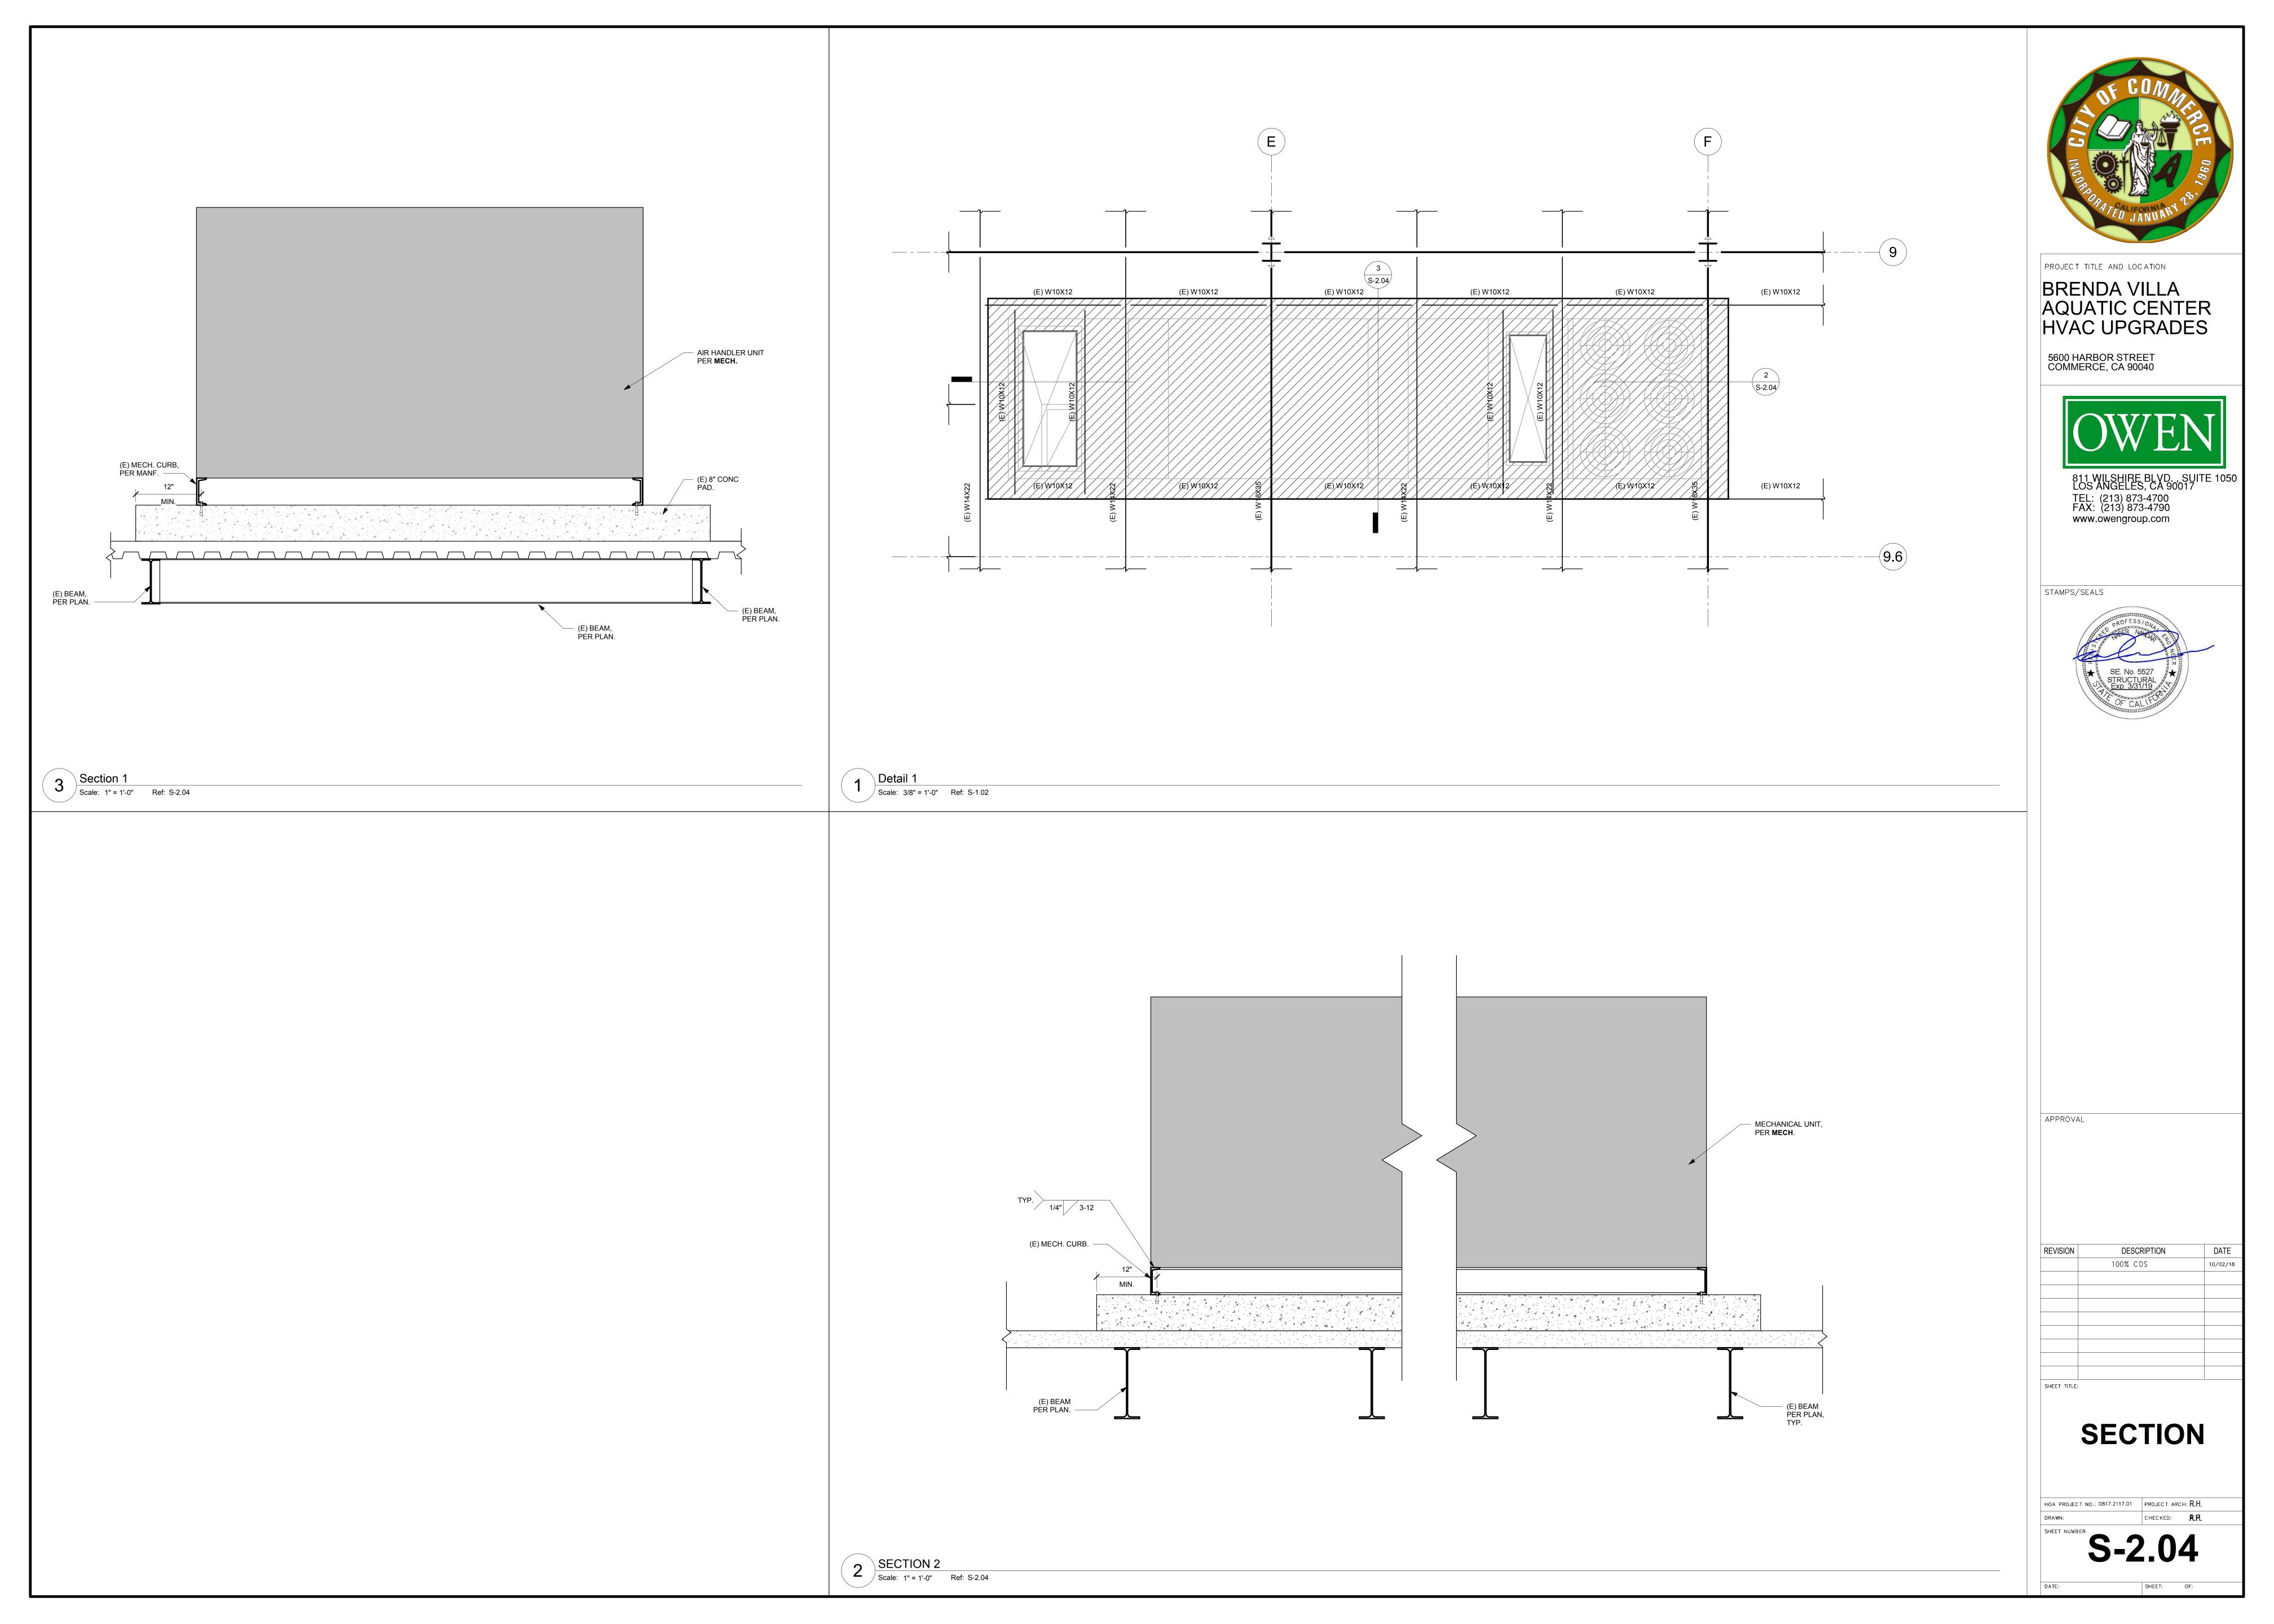

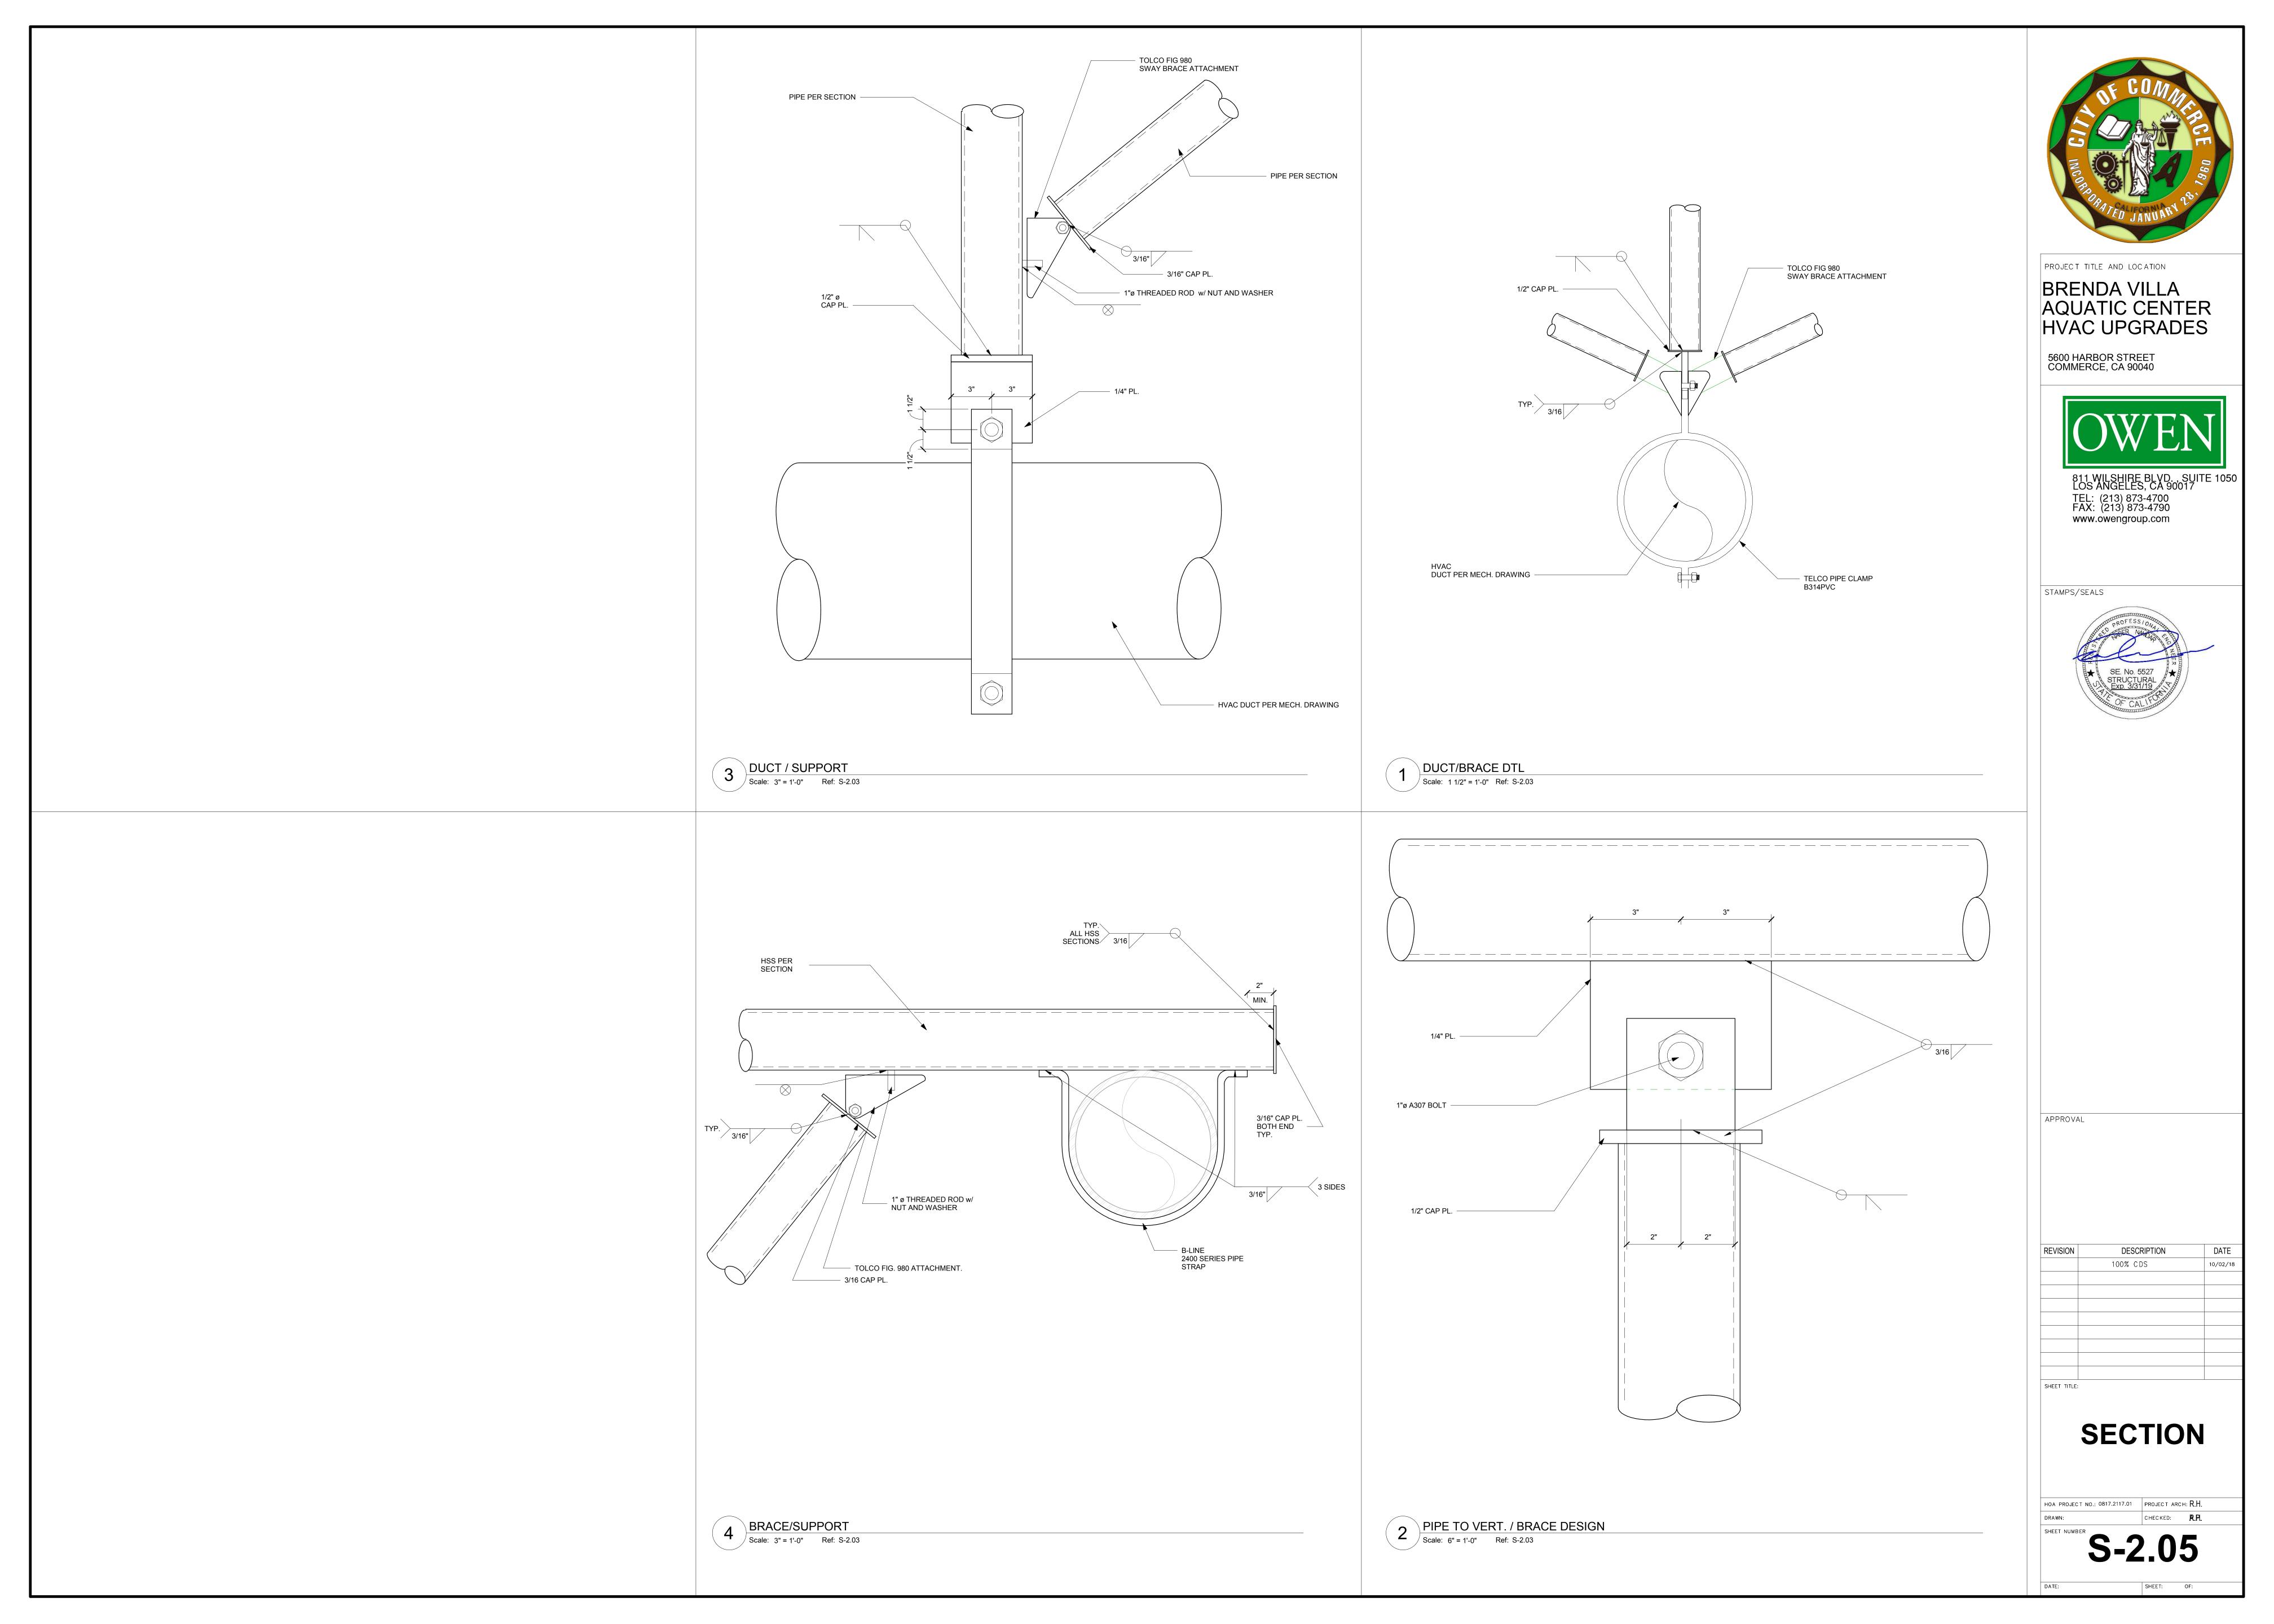


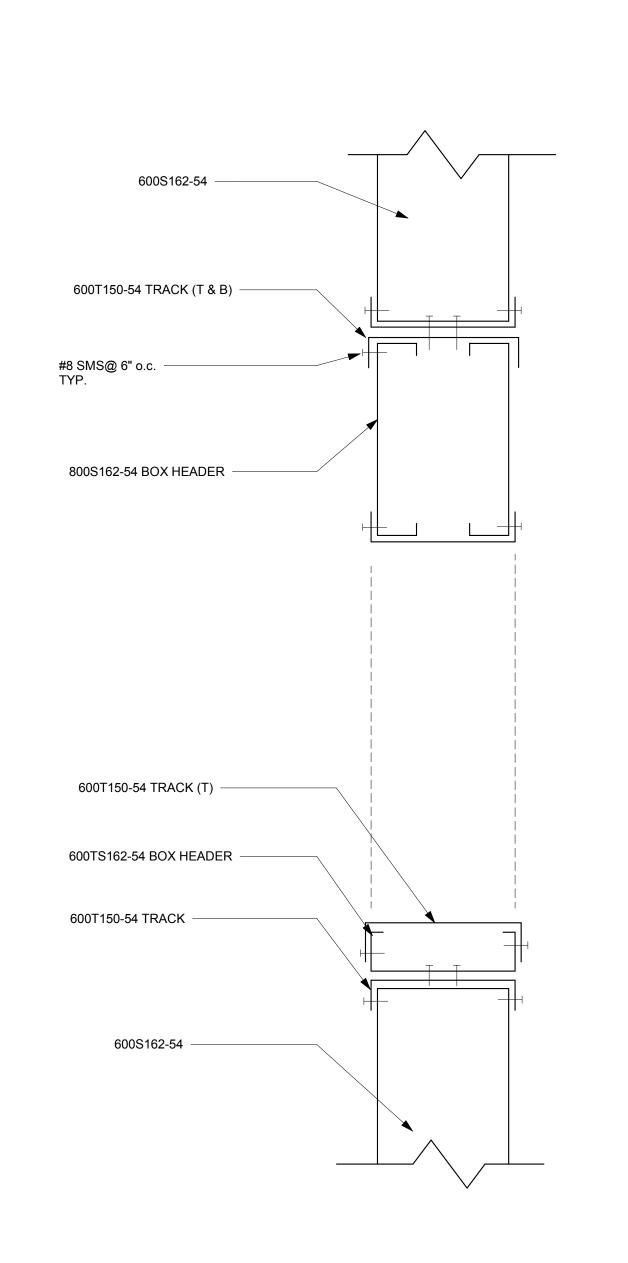


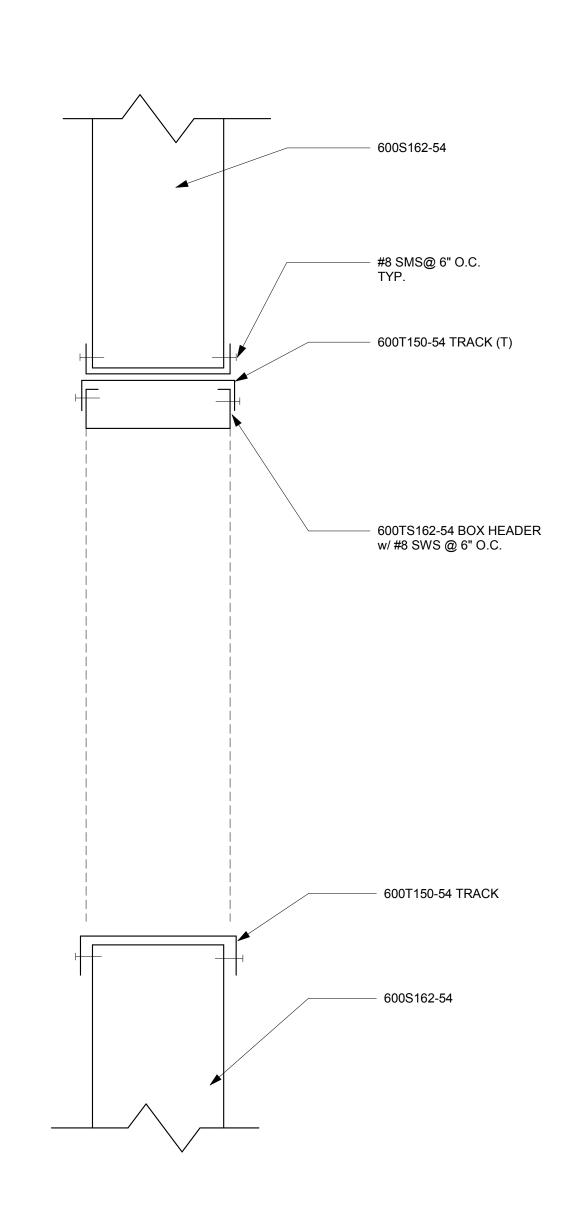

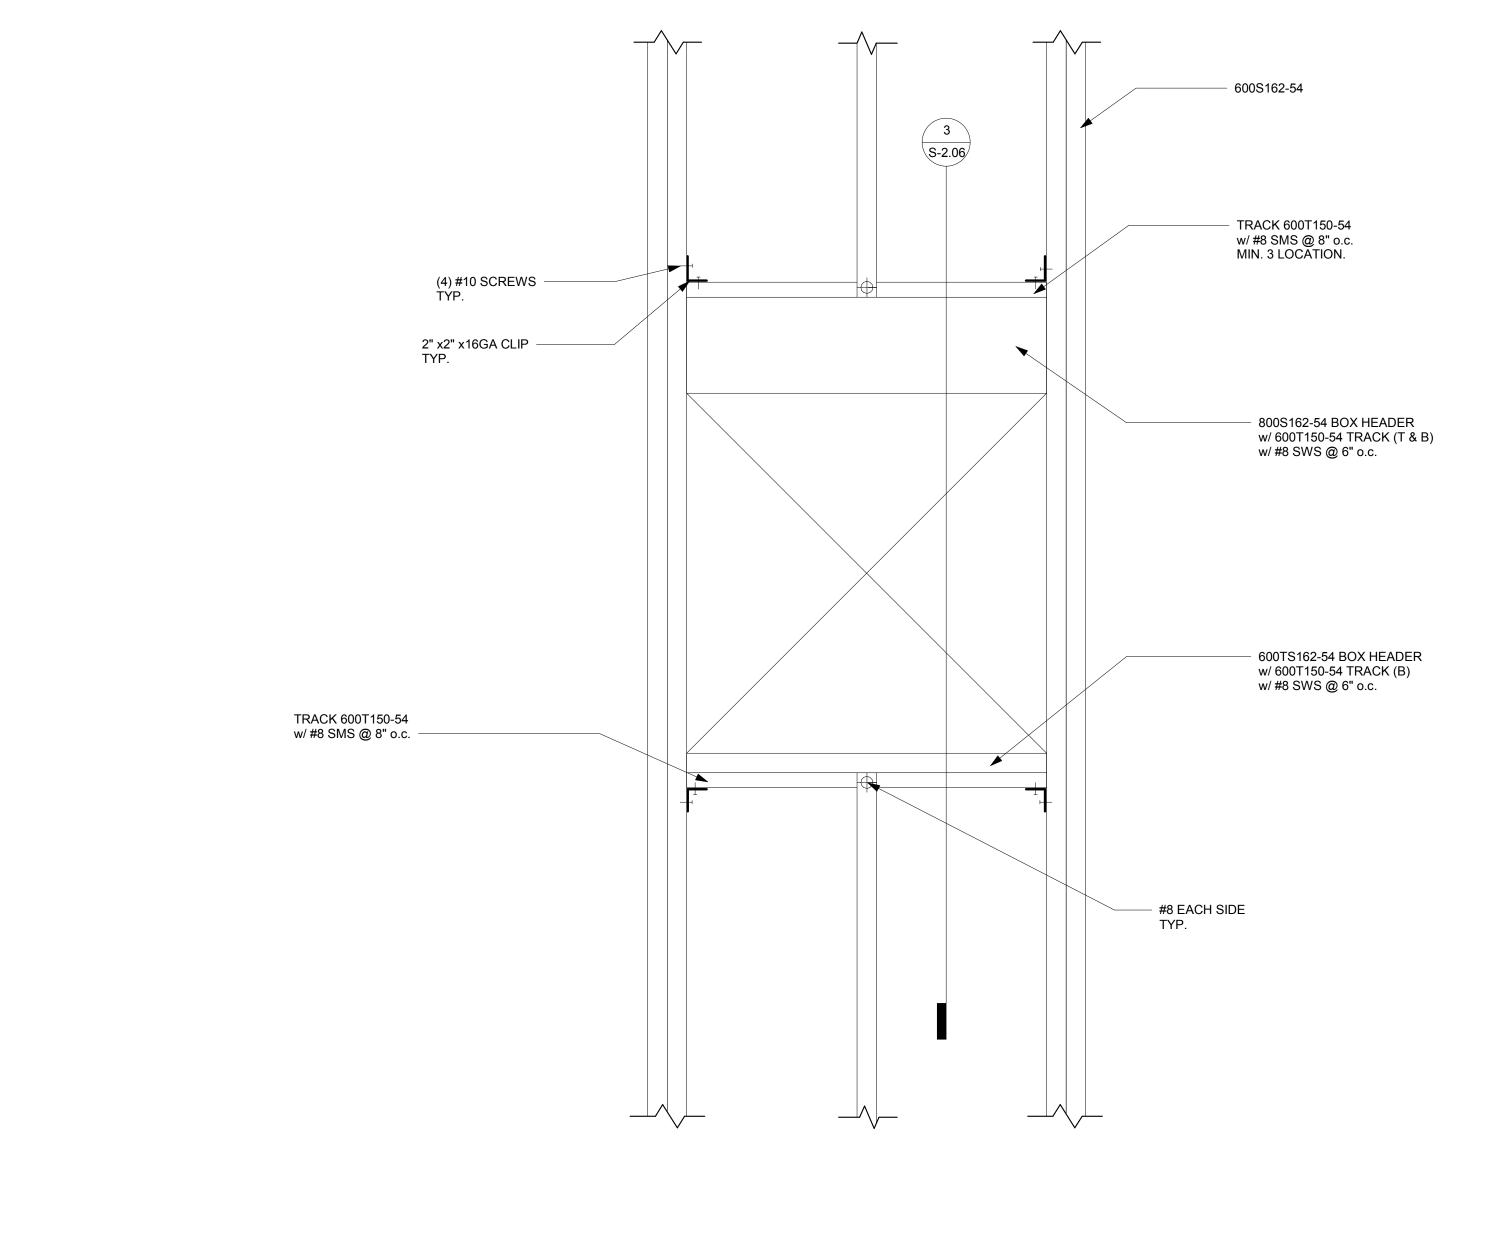

1 EXTERIOR WALL

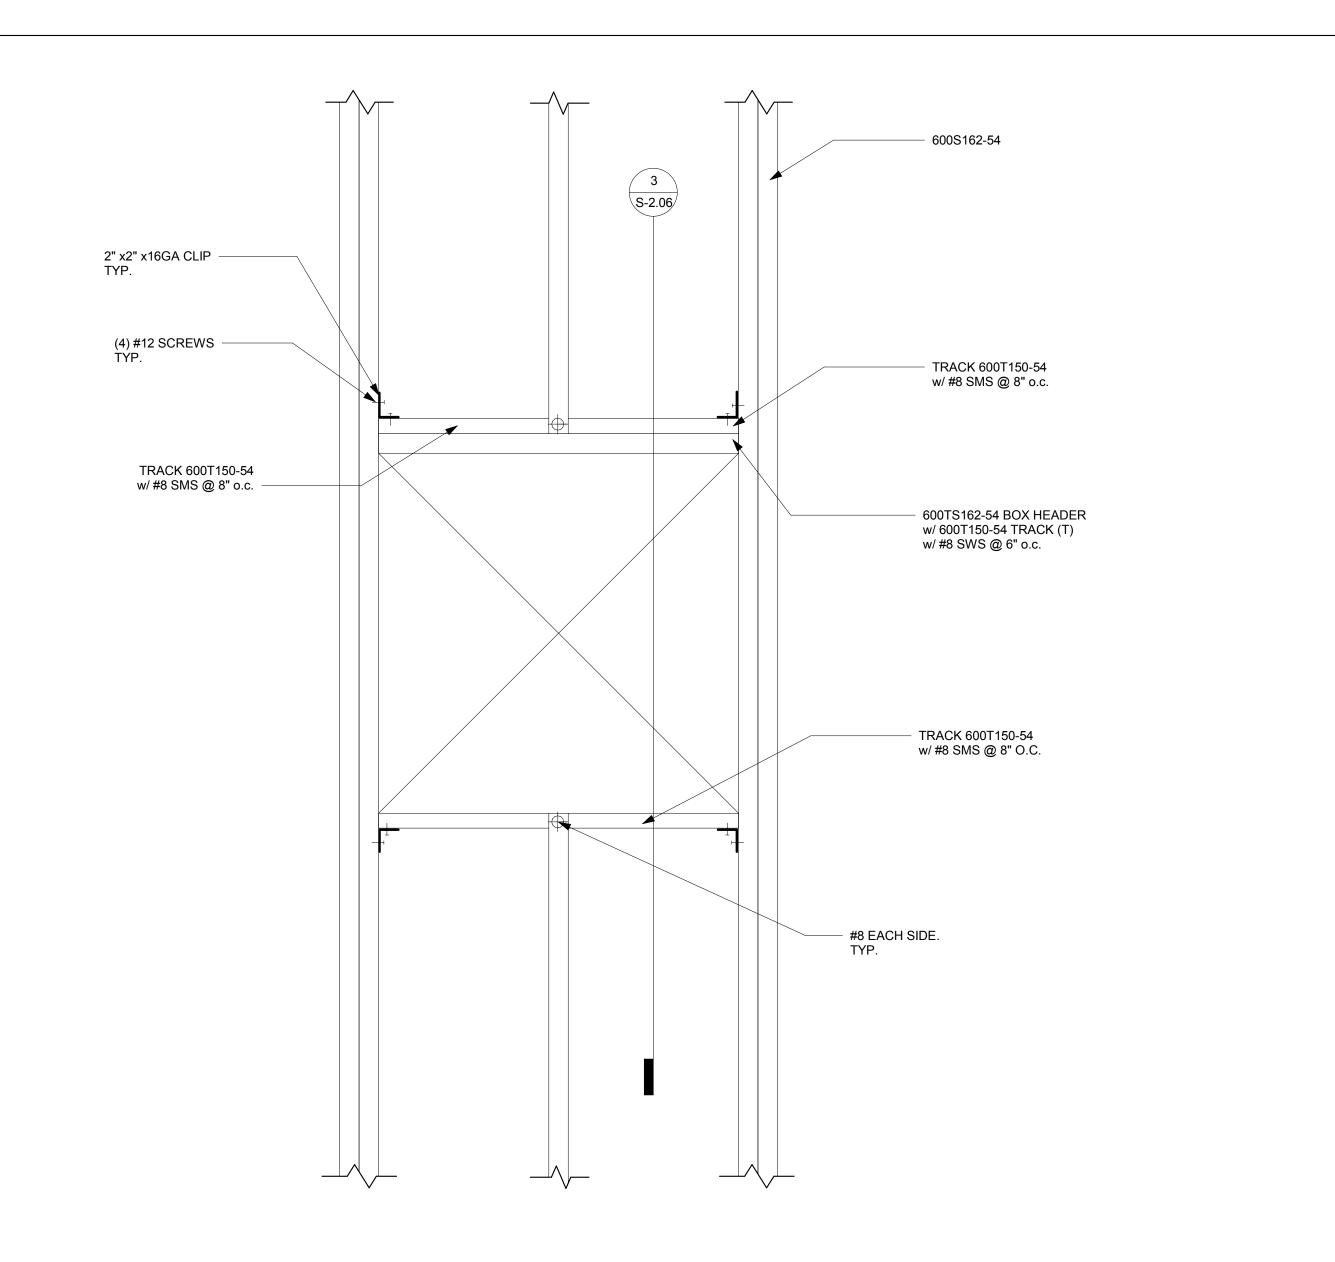

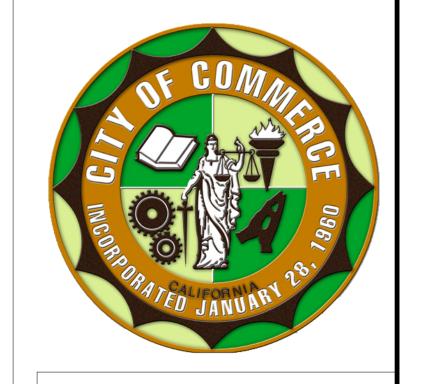

BRENDA VILLA
AQUATIC CENTER
HVAC UPGRADES

5600 HARBOR STREET COMMERCE, CA 90040



811 WILSHIRE BLVD., SUITE 1050 LOS ANGELES, CA 90017 TEL: (213) 873-4700 FAX: (213) 873-4790 www.owengroup.com

STAMPS/SEALS



APPROVAL

REVISION DESCRIPTION DATE
100% CDS 10/02/18

DETAILS

HOA PROJECT NO.: 0817.2117.01 PROJECT ARCH: R.H.

DRAWN: CHECKED: R.H.

SHEET NUMBER S-2.06

2 INTERIOR WALL
Scale: 1 1/2" = 1'-0" Ref: