GENERAL CONSTRUCTION NOTES:


- 1. ALL WORK SHALL CONFORM TO THE AASHTO "A POLICY ON GEOMETRIC DESIGN
 OF HIGHWAYS AND STREETS" AND "STANDARD PLANS AND SPECIFICATIONS FOR
 PUBLIC WORKS CONSTRUCTION", LATEST EDITION.
- 2. APPLICATION FOR INSPECTION TO THE CITY OF COMMERCE DEPARTMENT OF PUBLIC WORKS SHALL BE MADE BY THE CONTRACTOR BEFORE THE SERVICES THEREOF WILL BE REQUIRED.REQUESTS FOR INSPECTION SHALL BE MADE 48 HOURS IN ADVANCE OF REQUIRED INSPECTION.
- 3. WORK IN PUBLIC STREETS, ONCE BEGUN, SHALL BE COMPLETED WITHOUT DELAY SO AS TO PROVIDE MINIMUM INCONVENIENCE TO ADJACENT PROPERTY OWNERS AND TO THE TRAVELING PUBLIC.
- 4. THE CONTRACTOR SHALL TAKE ALL NECESSARY AND PROPER PRECAUTIONS TO PROTECT ADJACENT PROPERTIES FROM ANY AND ALL DAMAGE THAT MAY OCCUR FROM STORM WATER RUNOFF AND/OR DEPOSITION OF DEBRIS RESULTING FROM ANY AND ALL WORK IN CONNECTION WITH CONSTRUCTION ACTIVITIES.
- 5. THE CONTRACTOR SHALL BE RESPONSIBLE FOR THE CLEARING OF THE PROPOSED WORK AREA, AND RELOCATION COSTS OF ALL EXISTING UTILITIES.

 PERMITTEE MUST INFORM CITY OF CONSTRUCTION SCHEDULE AT LEAST 48

 HOURS PRIOR TO BEGINNING
- 6. IT SHALL BE THE RESPONSIBILITY OF THE CONTRACTOR TO APPLY TO THE CITY ENGINEER'S OFFICE, PERMIT SECTION, PRIOR TO CONSTRUCTION FOR AN
- 7. NO TRENCHES MAY BE LEFT OPEN OVERNIGHT UNLESS APPROVED BY THE CITY ENGINEER.
- 8. IF ANY UTILITIES OR FACILITIES CONFLICT WITH PROPOSED IMPROVEMENTS, ALL WORK SHALL STOP, AND THE CITY ENGINEER SHALL BE NOTIFIED IMMEDIATELY.
- 9. ALL TRAFFIC CONTROL DEVICES, SIGNS, MARKINGS OR STRIPING SHALL BE IN PLACE PRIOR TO PAVING. STREET STRIPING SHALL BE COMPLETED PRIOR TO STREET OPENING.
- 10. THE CONTRACTOR SHALL NOTIFY UNDERGROUND SERVICE ALERT (U.S.A.) AS REQUIRED PRIOR TO THE START OF WORK. UPON EXPOSING ANY UTILITY'S UNDERGROUND FACILITY
- 11. IT SHALL BE THE RESPONSIBILITY OF THE CONTRACTOR TO LOCATE ALL SUBSTRUCTURES WITHIN THE ALIGNMENT OF THE PROPOSED IMPROVEMENTS, AND IN THE EVENT OF SUBSTRUCTURE DAMAGE, HE SHALL BEAR THE TOTAL COST OF REPAIR OR REPLACEMENT.
- 12. THE CONTRACTOR SHALL NOT CONDUCT ANY OPERATIONS OR PERFORM ANY WORK PERTAINING TO THE PROJECT BETWEEN 5:00 P.M. AND 7:00 A.M. ON ANY DAY NOR ON SATURDAY, SUNDAY, HOLIDAY AT ANY TIME EXCEPT AS APPROVED BY THE ENGINEER.
- 13. TREES, FOLIAGE, SIGNS, AND OTHER IMPROVEMENTS SHALL BE PROTECTED IN PLACE AND ANY DAMAGE TO EXISTING IMPROVEMENTS SHALL BE REPLACED IN
- 14. THE CONTRACTOR IS ADVISED THAT ALL EXCAVATED MATERIALS SHALL BECOME HIS PROPERTY AND SHALL BE REMOVED FROM THE JOB—SITE UNLESS INSTRUCTED BY THE CITY ENGINEER TO DO OTHERWISE.
- 15. THE CONTRACTOR SHALL BE RESPONSIBLE DURING ALL PHASES OF THE WORK TO PROVIDE FOR PUBLIC SAFETY AND CONVENIENCE. THE CONTRACTOR SHALL ESTABLISH ADEQUATE ACCESS TO DRIVEWAYS AT THE END OF EACH WORKING
- 16. THE CONTRACTOR SHALL ADJUST ALL UTILITIES COVERS TO FINISHED GRADE.
- 17. THE CONTRACTOR SHALL PROVIDE A TRAFFIC CONTROL PLAN FOR THE COMPLETION OF THE PROPOSED IMPROVEMENTS PER THE "WORK AREA TRAFFIC CONTROL HANDBOOK" (W.A.T.C.H.) TO THE SATISFACTION OF THE CITY ENGINEER. THE CONTRACTOR WILL NOT BE ALLOWED TO CLOSE STREETS WITHIN THE PROJECT AREA TO TRAFFIC FROM 8:00 A.M. TO 4:30 P.M., NO TWO ADJACENT STREETS SHALL BE CLOSED AT ANY ONE TIME.
- 18. THE CONTRACTOR SHALL PROVIDE A 72—HOUR NOTIFICATION TO THE AFFECTED PROPERTIES, POLICE DEPARTMENT, AND FIRE DEPARTMENT IN THE EVENT OF A CHANGE IN STREET CLOSURE TO TRAFFIC AND/OR PUBLIC SAFETY VEHICLES, PARKING RESTRICTIONS, AND ON EACH MONDAY MORNING DURING THE CONSTRUCTION PERIOD.
- 19. AS REQUIRED BY THE CITY ENGINEER, THE CONTRACTOR SHALL FURNISH AND OPERATE A SELF-LOADING MOTOR SWEEPER WITH SPRAY NOZZLES AT LEAST TWICE EACH WORKING DAY TO KEEP PAVED AREAS ACCEPTABLY CLEAN WHEREVER CONSTRUCTION, INCLUDING RESTORATION, IS INCOMPLETE.
- 20. ALL PORTLAND CEMENT CONCRETE (P.C.C.) AND ASPHALTIC CONCRETE (A.C.) SHALL BE REMOVED TO A SAWCUT.

NPDES NOTES:


- 1. ERODED SEDIMENTS AND OTHER POLLUTANTS MUST BE RETAINED ON SITE AND MAY NOT BE TRANSPORTED FROM THE SITE VIA SHEET FLOW, SWALES, AREA DRAINS, NATURAL DRAINAGE COURSES, OR WIND.
- 2. STOCKPILES OF EARTH AND OTHER CONSTRUCTION RELATED MATERIALS MUST BE PROTECTED FROM BEING TRANSPORTED FROM THE SITE BY THE FORCES OF WIND OR
- 3. FUELS, OILS, SOLVENTS, AND OTHER TOXIC MATERIALS MUST BE STORED IN ACCORDANCE WITH THEIR LISTING AND ARE NOT TO CONTAMINATE THE SOIL AND SURFACE WATERS. ALL APPROVED STORAGE CONTAINERS ARE TO BE PROTECTED FROM THE WEATHER. SPILLS MUST BE CLEANED UP IMMEDIATELY AND DISPOSED OF IN A PROPER MANNER. SPILLS MAY NOT BE WASHED INTO THE DRAINAGE SYSTEM.
- 4. EXCESS OR WASTE CONCRETE MAY NOT BE WASHED INTO THE PUBLIC WAY OR ANY OTHER DRAINAGE SYSTEM. PROVISIONS SHALL BE MADE TO RETAIN CONCRETE WASTES ON SITE UNTIL THEY CAN BE DISPOSED OF AS SOLID WASTE.
- 5. TRASH AND CONSTRUCTION RELATED SOLID WASTES MUST BE DEPOSITED INTO A COVERED RECEPTACLE TO PREVENT CONTAMINATION OF RAINWATER AND DISPERSAL BY WIND.
- 6. SEDIMENTS AND OTHER MATERIALS MAY NOT BE TRACKED FROM THE SITE BY VEHICLE TRAFFIC. THE CONSTRUCTION ENTRANCE ROADWAYS MUST BE STABILIZED SO AS TO INHIBIT SEDIMENTS FROM BEING DEPOSITED INTO THE PUBLIC WAY. ACCIDENTAL DEPOSITIONS MUST BE SWEPT UP IMMEDIATELY AND MAY NOT BE WASHED DOWN BY RAIN OR OTHER MEANS.
- 7. ANY SLOPES WITH DISTURBED SOILS OR DENUDED OF VEGETATION MUST BE STABILIZED SO AS TO INHIBIT EROSION BY WIND AND WATER.

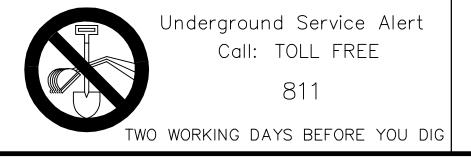

CIPY OF COMMERCE

COMMUNITY DEVELOPMENT DEPARTMENT PUBLIC WORKS DIVISION

ATLANTIC BOULEVARD CORRIDOR IMPROVEMENTS

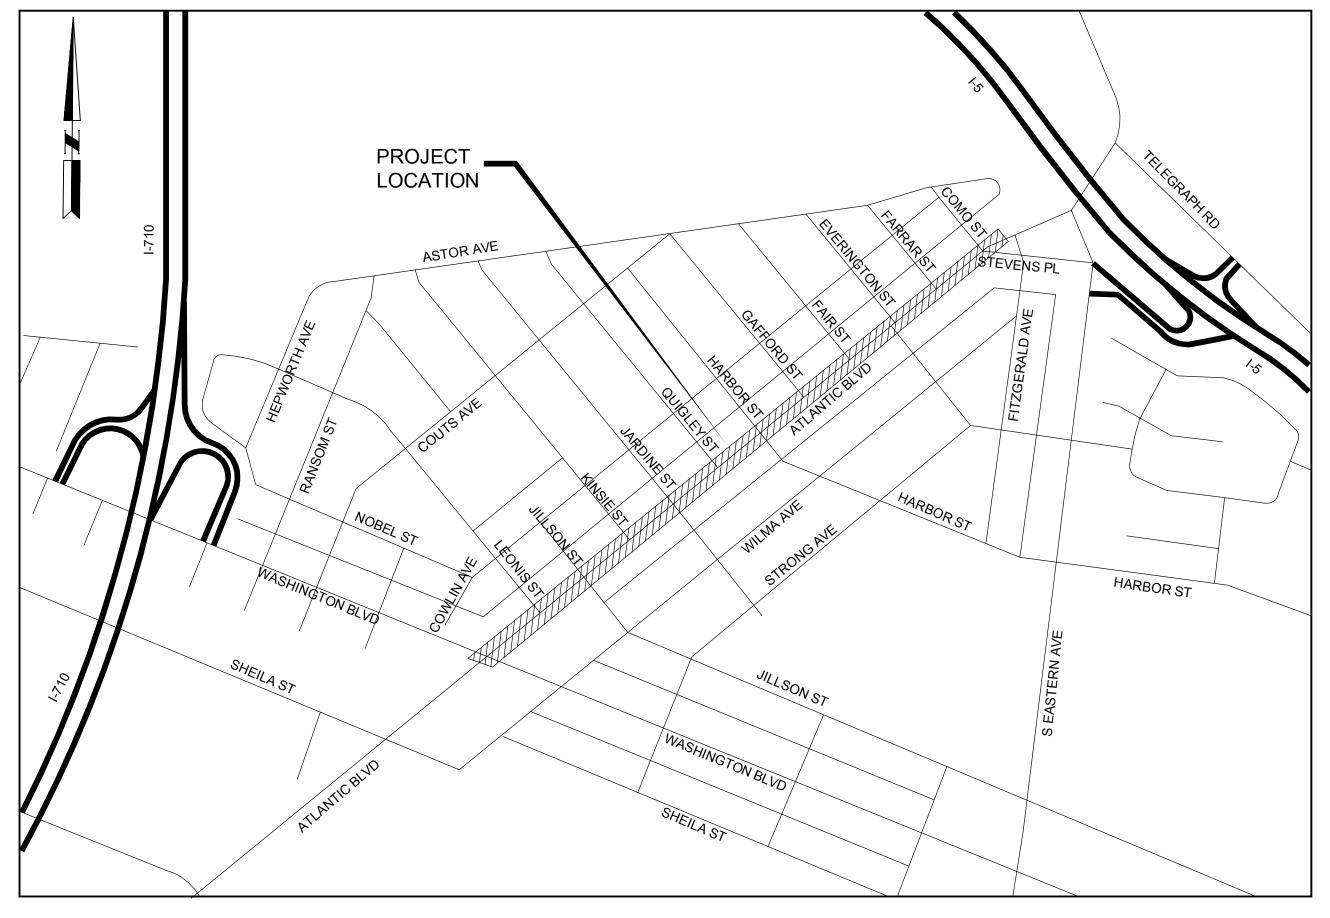

VICINITY MAP

NOT TO SCALE

GENERAL SIGNING, STRIPING AND MARKING NOTES:

- 1. TRAFFIC STRIPING AND PAVEMENT LEGENDS SHALL BE INSTALLED IN ACCORDANCE WITH THE LATEST VERSION OF THE CALIFORNIA MANUAL OF UNIFORM TRAFFIC CONTROL DEVICES (CA MUTCD), AND STANDARD SPECIFICATIONS FOR PUBLIC WORKS CONSTRUCTION, LATEST EDITION, AND ANY ADDENDUM THERETO, AND THESE PLANS AND CONTRACT SPECIAL PROVISIONS.
- 2. ALL STRIPING SHALL BE APPLIED IN 2 COATS OF PAINT REFLECTORIZED AND PAVEMENT LEGENDS AND MARKINGS SHALL BE IN THERMOPLASTIC REFLECTORIZED.
- 3. EXISTING PAVEMENT STRIPING ARE PAINTED AND MARKING ARE IN THERMOPLASTIC TYPICALLY. EXISTING STRIPING AND MARKINGS TO BE REMOVED SHALL BE DONE BY WET SANDBLASTING OR OTHER APPROVED METHOD APPROVED BY THE ENGINEER.
- 4. THE CONTRACTOR SHALL CONTACT THE CITY FOR INSPECTION 48 HOURS PRIOR TO BEGINNING OF CONSTRUCTION.
- 5. CONTRACTOR SHALL VERIFY ALL EXISTING CONDITIONS AND DIMENSIONS BEFORE STARTING WORK. IF CONDITIONS EXIST WHICH ARE CONTRARY TO THOSE SHOWN ON PLANS, THE CITY ENGINEER SHALL BE NOTIFIED BEFORE PROCEEDING WITH WORK.
- 6. IT SHALL BE THE RESPONSIBILITY OF THE CONTRACTOR TO BE FAMILIARIZED WITH THE JOB SITE AND THE LOCATION OF ALL UNDERGROUND FACILITIES SHOWN OR NOT SHOWN.

TRAFFIC CONTROL GENERAL NOTES:

- 1. ALL TRAFFIC CONTROL WORK FOR CONSTRUCTION SHALL CONFORM TO PART 6— TEMPORARY TRAFFIC CONTROL OF THE CA—MUTCD, ADDENDUMS, LATEST EDITIONS, AND ALL O.S.H.A. REQUIREMENTS.
- 2. THE CONTRACTOR SHALL HAVE ALL TRAFFIC CONTROL SIGNS, DELINEATORS, ETC., PROPERLY INSTALLED PRIOR TO COMMENCING CONSTRUCTION.
- 3. THE CONTRACTOR SHALL MAINTAIN ALL TRAFFIC CONTROL SIGNS, DELINEATORS, ETC., TO ENSURE PROPER FLOW AND SAFETY OF TRAFFIC WHILE WORKING IN THE STREET.
- 4. ADDITIONAL TRAFFIC CONTROL DEVICES MAY BE REQUIRED IN THE FIELD. THE CONTRACTOR SHALL BE RESPONSIBLE FOR ANY ADDITIONAL TRAFFIC CONTROL DEVICES REQUIRED BY THE CITY INSPECTOR/REPRESENTATIVES TO ASSURE PUBLIC SAFETY AT ALL TIMES. NO ADDITIONAL COMPENSATION WILL BE ALLOWED.
- 5. THE CONTRACTOR SHALL UTILIZE A FLAGMAN DURING CONSTRUCTION WORK AS DEEMED NECESSARY BY THE AGENCY REPRESENTATIVE.
- 6. ARROW BOARDS SHALL BE USED ON ANY LANE CLOSURE ON ARTERIAL STREETS.
- 7. STRIPING SHALL BE CAT TRACKED AND APPROVED BY THE AGENCY REPRESENTATIVE PRIOR TO FINAL INSTALLATION.
- 8. MAINTAIN AT LEAST ONE TRAFFIC LANE ON BOTH DIRECTIONS AT ALL TIMES.
- 9. ALL TRAFFIC LANES MUST BE OPEN ON WEEKENDS AND HOLIDAYS.
- 10. ANY DEVIATION TO THE TRAFFIC LANE REQUIREMENTS SHALL REQUIRE THE CITY ENGINEER'S APPROVAL. A MINIMUM 24 HOURS ADVANCE NOTICE IS REQUIRED.

SOURCE COUNTY FLOOD CONTROL MAN PROPERTY COUNTY FLOOD COUNTY FLOOD CONTROL MAN PROPERTY COUNTY FLOOD COUNTY

INDEX TO PROJECT DRAWINGS

SHEET NO	<u>Drawing no</u>	<u>DESCRIPTION</u>	
1	T-1	TITLE SHEET	
2	T-2	CONSTRUCTION NOTES, LEGEND AND ABBREVIATIONS	
3	X-1	TYPICAL SECTIONS	
4	X-2	TYPICAL SECTIONS	
5	X-3	TYPICAL SECTIONS	
6	DM-1	DEMOLITION PLAN FROM WASHINGTON BLVD TO STA 21+00	
7	DM-2	DEMOLITION PLAN FROM STA 21+00 TO STA 31+50	
8	DM-3	DEMOLITION PLAN FROM STA 31+50 TO COMO ST	
9	P-1	STREET IMPROVEMENT PLAN FROM WASHINGTON BLVD TO STA 21+00	
10	P-2	STREET IMPROVEMENT PLAN FROM STA 21+00 TO STA 31+50	
11	P-3	STREET IMPROVEMENT PLAN FROM STA 31+50 TO COMO ST	
12	CD-1	CONSTRUCTION DETAILS 1	
13	CD-2	CONSTRUCTION DETAILS 2	
14	CD-3	CONSTRUCTION DETAILS 3	
15	CD-4	CONSTRUCTION DETAILS 4	
16	TR-1	STREET SIGNAL PLAN	
17	SL-1	STREET LIGHTING PLAN (STA 12+00 - 30+07.50)	
18	SL-2	STREET LIGHTING PLAN (30+07.50 - 42+00)	
19	SL-3	STREET LIGHTING PLAN FOUNDATION DETAIL	
20	PD-1	SIGNING AND STRIPING PLAN FROM WASHINGTON BLVD TO STA 21+00	
21	PD-2	SIGNING AND STRIPING PLAN FROM STA 21+00 TO STA 31+50	
22	PD-3	SIGNING AND STRIPING PLAN FROM STA 31+50 TO COMO ST	
23	SC-1	STAGE CONSTRUCTION PHASE 1	
24	SC-2	STAGE CONSTRUCTION PHASE 1	
25	SC-3	STAGE CONSTRUCTION PHASE 1	
26	SC-4	STAGE CONSTRUCTION PHASE 2	
27	SC-5	STAGE CONSTRUCTION PHASE 2	
28	SC-6	STAGE CONSTRUCTION PHASE 2	
29	SC-7	STAGE CONSTRUCTION PHASE 3	
30	SC-8	STAGE CONSTRUCTION PHASE 3	
31	SC-9	STAGE CONSTRUCTION PHASE 3	
32	U-1	COMPOSITE UTILITY PLAN FROM WASHINGTON BLVD TO STA 30+00	
33	U-2	COMPOSITE UTILITY PLAN FROM STA 30+00 TO COMO ST	
34	L-01	LANDSCAPE TITLE SHEET	
35	L-02	PLANTING PLAN - WASHINGTON BLVD. TO JARDINE ST.	
36	L-03	PLANTING PLAN - JARDINE ST. TO FAIR ST. C.L.	
37	L-04	PLANTING PLAN - FAIR ST. C.L. TO END AT COMO ST.	
38	L-05	IRRIGATION PLAN - WASHINGTON BLVD. TO JARDINE ST.	
39	L-06	IRRIGATION PLAN - JARDINE ST. TO FAIR ST. C.L.	
40	L-07	IRRIGATION PLAN - FAIR ST. C.L. TO END AT COMO ST.	
41	L-08	LIGHTING PLAN — WASHINGTON BLVD. TO JARDINE ST.	
42	L-09	LIGHTING PLAN — JARDINE ST. TO FAIR ST. C.L.	
43	L-10	LIGHTING PLAN - FAIR ST. C.L. TO END AT COMO ST.	


CITY OF COMMERCE

PUBLIC WORKS AND ENGINEERING DEPARTMENT <u>PREPARED BY:</u> REVISIONS REVISED BY APPROVED BY DATE ELECTRONICALLY APPROVED BY: ATLANTIC BOULEVARD CORRIDOR IMPROVEMENTS PUBLIC WORKS & DEV. SERVICES DIRECTOR DATE TITLE SHEET ELECTRONICALLY CHECKED BY: Exp 9-30-19 8/14/2018 DRWG NO. SHEET 1 OF 43 SHEETS SHEILA AMPARO, R.C.E. C78003 DATE TITLE

DEMOLITION NOTES: ABBREVIATIONS: LEGEND: P PROTECT IN PLACE (ITEM) AGGREGATE BASE SIGNAL SIGNAL MANHOLE ABAND ABANDON SMH _____ RIGHT OF WAY LINE 1 SAWCUT SPEC ASPHALT CONCRETE АC SPECIFICATION ARHM ASPHALT RUBBER HOT MIX SPPWC STANDARD PLANS FOR PUBLIC WORKS CONSTRUCTION 2 REMOVE EXISTING CURB AND GUTTER REMOVE EXISTING CURB SSMH **ASPH** ASPHALT SANITARY SEWER MANHOLE ->>>> 3 REMOVE EXISTING CURB RAMP ST AND GUTTER STREET OR STEAM BEGIN CURVE BCR BEGIN CURB RETURN STA STATION 4 REMOVE EXISTING ASPHALT CONCRETE PAVEMENT AND GRIND EXISTING PCC SECTION STD STANDARD BEGIN SAWCUT BFP BACKFLOW PREVENTER SIDEWALK 5 RELOCATE EXISTING (ITEM) BUILDING BLDG TANGENT EXISTING ELECTRICAL 6 SEE STREET LIGHTING PLANS ВМ BENCH MARK TOP OF CURB —— E (OH) —— CAB TCE (OVERHEAD) CRUSHED AGGREGATE BASE TEMPORARY CONSTRUCTION EASEMENT 7 REMOVE EXISTING AC PAVEMENT AND AGGREGATE BASE C&G CURB AND GUTTER TRAFFIC SIGNAL 8 REMOVE PCC SIDEWALK CB CATCH BASIN TELE TELEPHONE EXISTING NATURAL GAS TYP CURB FACE, CUBIC FOOT OR CUBIC FEET TYPICAL 9 NOT USED UNDERGROUND CL, **E** CENTER LINE UNK UNKNOWN 10 ADJUST TO GRADE CONC CONCRETE VALVE OR VENT CONST CONSTRUCTION 11 REMOVE PCC CROSS GUTTER WATER OR WEST OR WIDTH CONT CONTINUOUS, CONTINUATION OR CONTENT WATER METER CY CUBIC YARDS WATER VALVE DRAIN DETAIL NUMBER OR POUND DEP **CONSTRUCTION NOTES:** DEPRESSED AND DRAIN INLET OR DUCTILE IRON EXISTING TELEPHONE PROPERTY LINE _____T___ DIAM DIAMETER (UNDERGROUND) (20) CONSTRUCT 7" HMA OVER 9" CAB (CLASS II) DIM DIMENSION DRAWING (21) CONSTRUCT 4" MIN. HMA OVER GRINDED PCC PAVEMENT ______COM ____ EXISTING COMMUNICATION EAST EXISTING CONSTRUCT CURB PER SPPWC STD DWG NO. 120-2, TYPE A1-8(200) (MODIFIED). SEE CONSTRUCTION DETAIL 21 ON CD-3 FOR CURB DETAIL EACH END OF CURVE (23) CONSTRUCT CURB RAMP PER SPPWC STD DWG NO. 111-5, CASE A TYPE 3 (MODIFIED) EXISTING ROADSIDE SIGN (ONE POST) ECR END OF CURB RETURN ELEVATION (24) CONSTRUCT CURB RAMP PER SPPWC STD DWG NO. 111-5, CASE B TYPE 2 (MODIFIED) ELEC ELECTRIC OR ELECTRICAL EΡ EDGE OF PAVEMENT EXISTING STREET LIGHT POLE (25) CONSTRUCT CURB AND GUTTER PER SPPWC STD DWG NO. 120-2, TYPE A3-8(200) END VERTICAL CURVE EXISTING (26) INSTALL BUS SHELTER FIRE HYDRANT EXISTING TRAFFIC SIGNAL POLE FLOW LINE (27) CONSTRUCT CURB RAMP PER SPPWC STD DWG NO. 111-5, CASE D TYPE 2 (MODIFIED) FOOT OR FEET EXISTING POWER POLE FINISHED SURFACE (28) SEE STREET LIGHTING PLANS GAS 0 EXISTING FIRE HYDRANT GRADE BREAK (29) INSTALL WHITE SOLID LANE LINE WITH PAVEMENT MARKERS EXISTING GUY WIRE GRADE GAS VALVE EXISTING MANHOLE (30) INSTALL TRAFFIC STRIPE PER DETAIL 8 OF SPPWC STD PLAN NO. 170 HEIGHT EXISTING UTILITY BOX HORIZONTAL (31) INSTALL CROSSWALK PER SPPWC STD PLAN NO. 174 HMAHOT MIX ASPHALT HIGHWAY EXISTING TREE (32) INSTALL SOLID WHITE LINE IRRIGATION BOX INSIDE DIAMETER (33) INSTALL YIELD LINE PER CALTRANS STD PLAN A24E NEW ROADSIDE SIGN (ONE POST) INCH OR INCHES IRRIGATION (34) INSTALL PAVEMENT MARKING PER SPPWC STD PLAN NO. 171 IRRIGATION CONTROL VALVE STREET LIGHT POLE W/BANNER LENGTH OR LENGTH OF CURVE (35) INSTALL 12" WIDE WHITE LIMIT LINE (STOP LINE) PER CALTRANS STD PLAN A24E LINEAR FEET (36) INSTALL PAVEMENT MARKING TYPE II ARROW PER SPPWC STD PLAN NO. 171 LIP OF GUTTER LOW POINT LIGHT, LEFT (37) INSTALL TRAFFIC SIGN AS SHOWN ON PLAN МН MANHOLE MINIMUM (38) INSTALL MONUMENT SIGN (OBELISK PER APPENDIX A OF THESE PLANS) MISCELLANEOUS (39) INSTALL ASPHALT RUBBER AND AGGREGATE MEMBRANE NORTH NUMBER (40) CONSTRUCT 1-FOOT CONCRETE PAVEMENT (MATCH EXISTING DEPTH) NEWSPAPER STAND NOT TO SCALE INSTALL 3/8" MINIMUM ARAM FABRIC FROM EDGE OF GUTTER TO MEDIAN CURB, UNLESS NOTED OTHERWISE OUTSIDE DIAMETER ORIGINAL GROUND, ORIGINAL GRADE OVERHEAD (42) SEE TRAFFIC SIGNAL PLANS PULL BOX POINT OF COMPOUND CURVE OR PORTLAND CEMENT CONCRETE (43) REMOVE AND RECONSTRUCT PORTION OF PCC CROSS GUTTER PARKWAY DRAIN PEDESTRIAN (44) INSTALL RETAINING CURB POINT OF INTERSECTION PKWY PARKWAY (45) INSTALL ADA COMPLIANT HANDRAIL POINT ON CURVE OR POINT OF CONNECTION POWER POLE (46) INSTALL TRUNCATED DOMES PROPOSED POINT OF TANGENCY INSTALL MTK FABRIC LONGITUDINALLY BETWEEN THE PCC PAVEMENT EDGE AND AC/AB PAVEMENT SECTION PAVEMENT RADIUS RETAINING CURB RCP REINFORCED CONCRETE PIPE RD ROAD RDWY ROADWAY REV REVISION RT RIGHT R/W, ROW RIGHT OF WAY RECLAIMED WATER SOUTH OR SLOPE OR SEWER SANITARY SEWER SD STORM DRAIN SDMH STORM DRAIN MANHOLE SDV STORM DRAIN VAULT STREET LIGHT (ELECTRICAL) SQUARE FEET SHLD SHOULDER SHEET SHT CITY OF COMMERCE PUBLIC WORKS AND ENGINEERING DEPARTMENT

	Underground Service Alert Call: TOLL FREE
	811
TWO	WORKING DAYS BEFORE YOU DIG

NO.	REVISIONS	REVISED BY	APPROVED BY	DATE

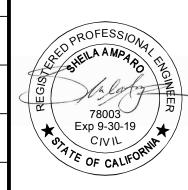



REPARED BY:	ELECTRONICALLY APPROVED BY:	
	PUBLIC WORKS & DEV. SERVICES DIRECTOR DATE	
	ELECTRONICALLY CHECKED BY:	
SHEILA AMPARO, R.C.E. C78003 B/14/2018 DATE	TITLE DATE	- 5

ATLANTIC BOULEVARD CORRIDOR IMPROVEMENTS CONSTRUCTION NOTES, LEGEND, AND

ABBREVIATIONS

DRWG NO. T-2 SHEET 2 OF 43 SHEETS

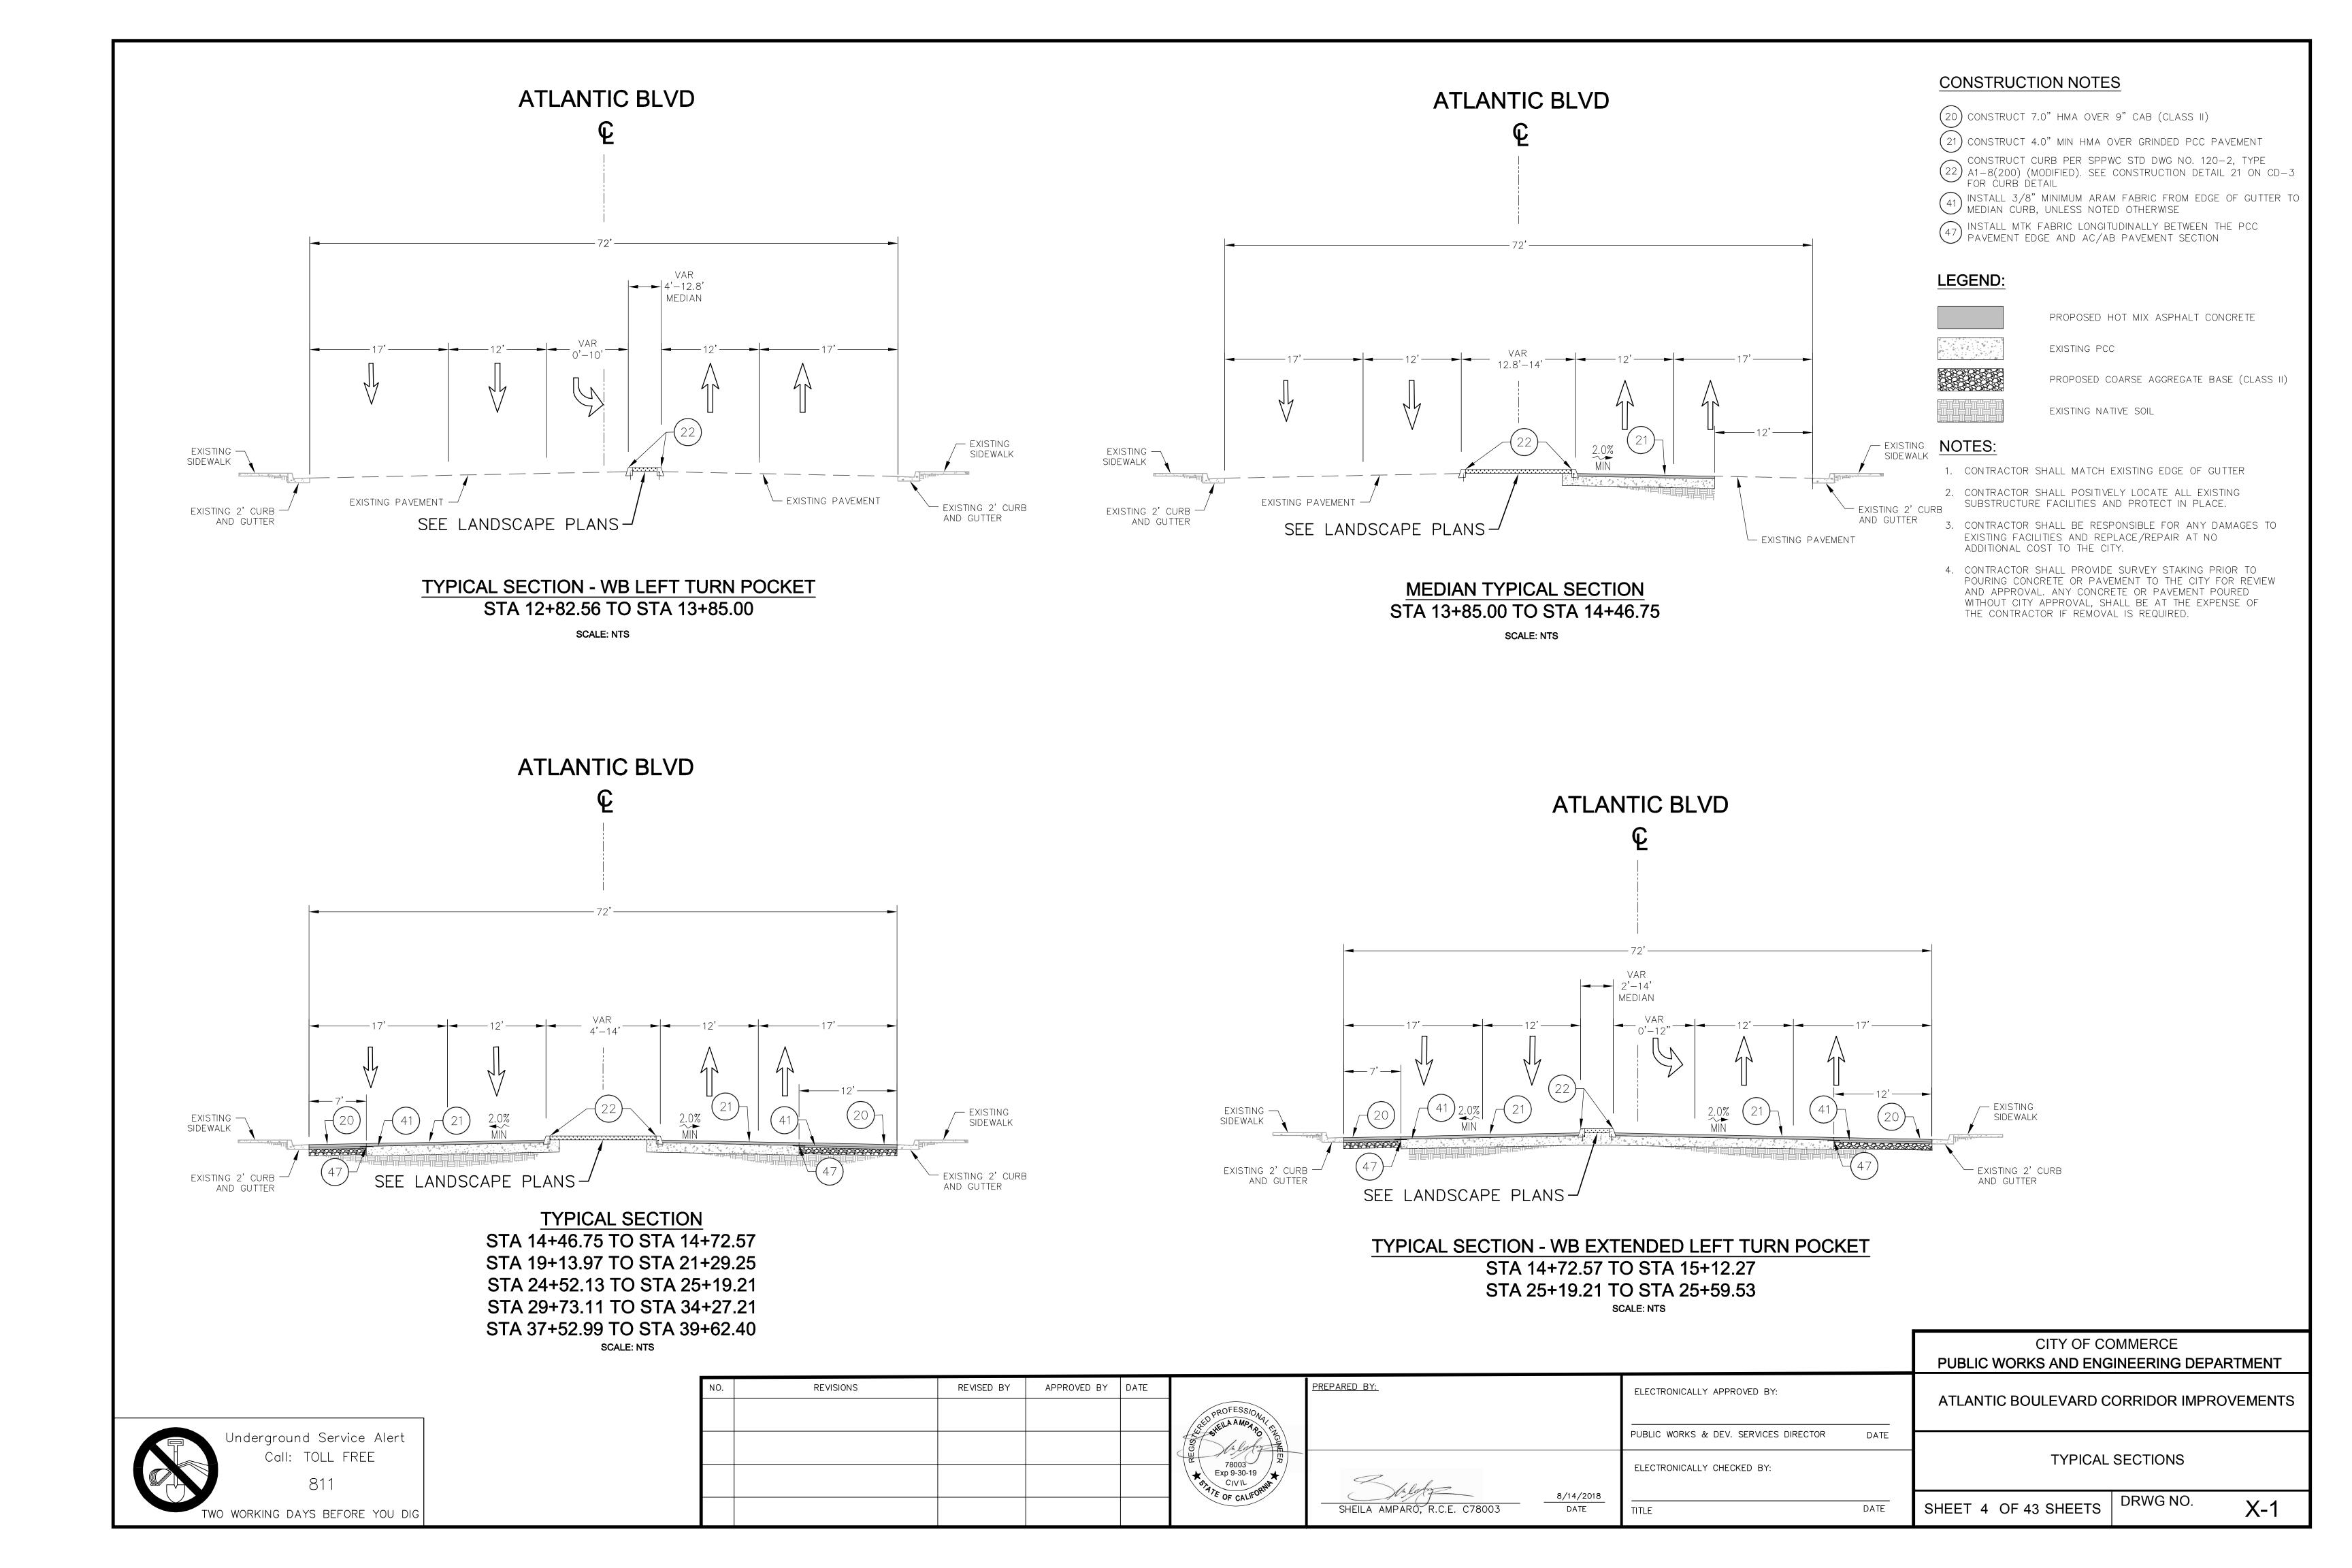

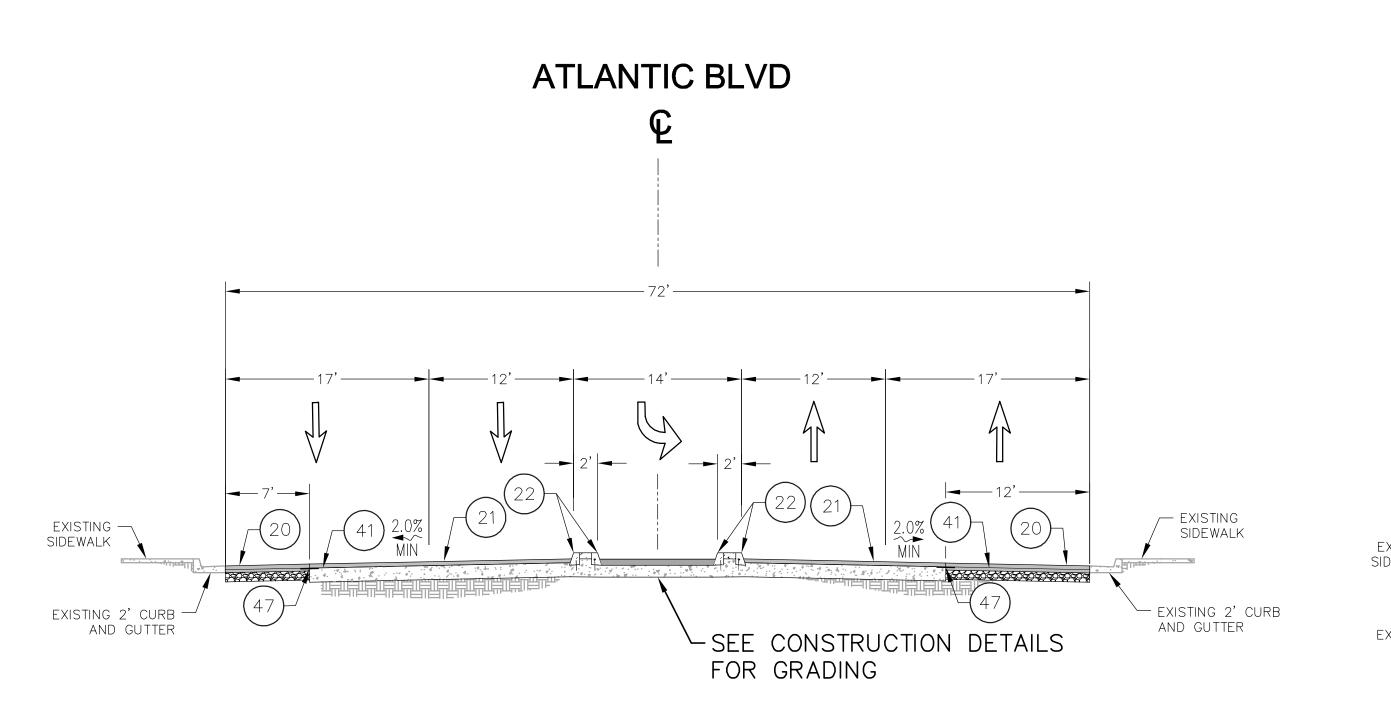

TYPICAL SECTION - LEFT TURN POCKET STA 15+12.27 TO STA 15+25.96 STA 25+59.53 TO STA 25+63.97 SCALE: NTS

ATLANTIC BLVD MEDIAN / EXISTING SIDEWALK EXISTING — SIDEWALK EXISTING 2' CURB AND GUTTER SEE LANDSCAPE PLANS -EXISTING 2' CURB — AND GUTTER

> TYPICAL SECTION - WB LEFT TURN POCKET STA 15+25.96 TO STA 16+17.27

STA 17+99.99 TO STA 19+13.97 STA 23+27.95 TO STA 24+52.13 STA 25+63.97 TO STA 26+64.51 STA 28+48.67 TO STA 29+73.11

STA 36+28.68 TO STA 37+52.99 SCALE: NTS

CONSTRUCTION NOTES

(20) CONSTRUCT 7.0" HMA OVER 9" CAB (CLASS II)

21) CONSTRUCT 4.0" MIN HMA OVER GRINDED PCC PAVEMENT

CONSTRUCT CURB PER SPPWC STD DWG NO. 120-2, TYPE A1-8(200) (MODIFIED). SEE CONSTRUCTION DETAIL 21 ON CD-3

PROPOSED HOT MIX ASPHALT CONCRETE

INSTALL 3/8" MINIMUM ARAM FABRIC FROM EDGE OF GUTTER TO MEDIAN CURB, UNLESS NOTED OTHERWISE

INSTALL MTK FABRIC LONGITUDINALLY BETWEEN THE PCC PAVEMENT EDGE AND AC/AB PAVEMENT SECTION

LEGEND:


NOTES:

EXISTING PCC


PROPOSED COARSE AGGREGATE BASE (CLASS II)

EXISTING NATIVE SOIL

- 1. CONTRACTOR SHALL MATCH EXISTING EDGE OF GUTTER
- 2. CONTRACTOR SHALL POSITIVELY LOCATE ALL EXISTING SUBSTRUCTURE FACILITIES AND PROTECT IN PLACE.
- 3. CONTRACTOR SHALL BE RESPONSIBLE FOR ANY DAMAGES TO EXISTING FACILITIES AND REPLACE/REPAIR AT NO ADDITIONAL COST TO THE CITY.
- 4. CONTRACTOR SHALL PROVIDE SURVEY STAKING PRIOR TO POURING CONCRETE OR PAVEMENT TO THE CITY FOR REVIEW AND APPROVAL. ANY CONCRETE OR PAVEMENT POURED WITHOUT CITY APPROVAL, SHALL BE AT THE EXPENSE OF THE CONTRACTOR IF REMOVAL IS REQUIRED.

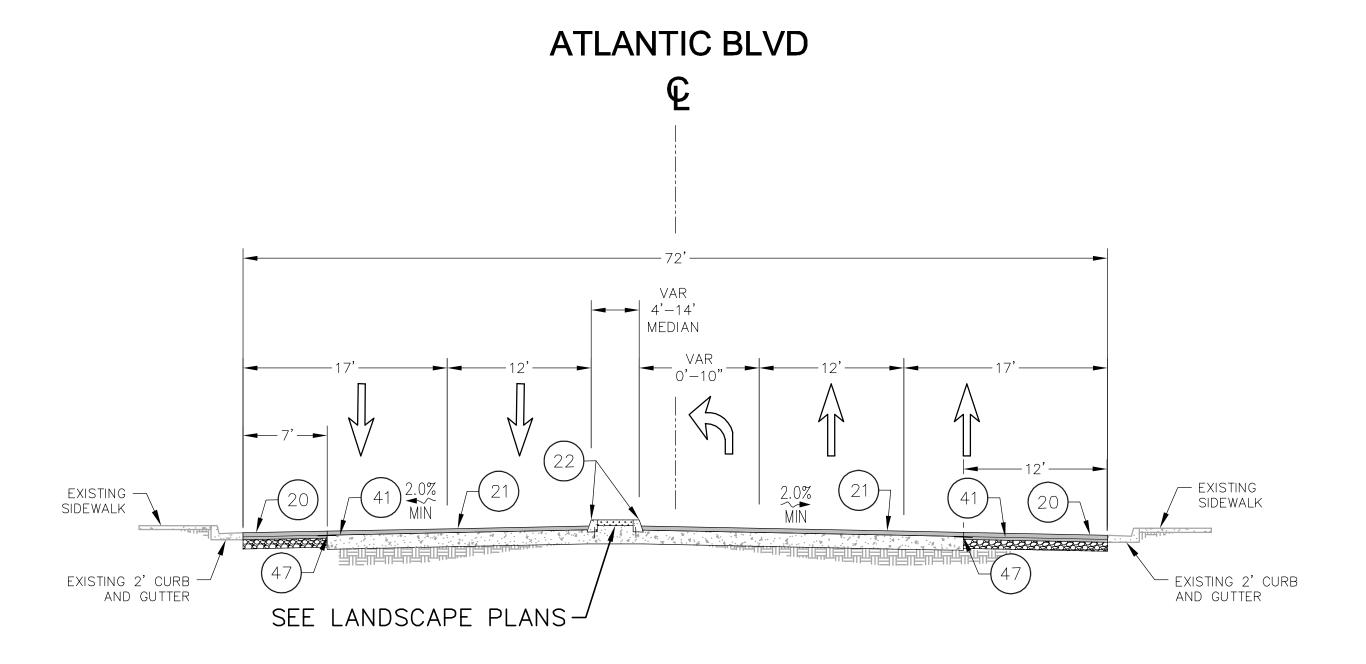

TYPICAL SECTION - EB LEFT TURN POCKET STA 16+17.27 TO STA 17+35.71 STA 21+29.25 TO STA 22+54.79 STA 34+27.21 TO STA 35+52.73 SCALE: NTS

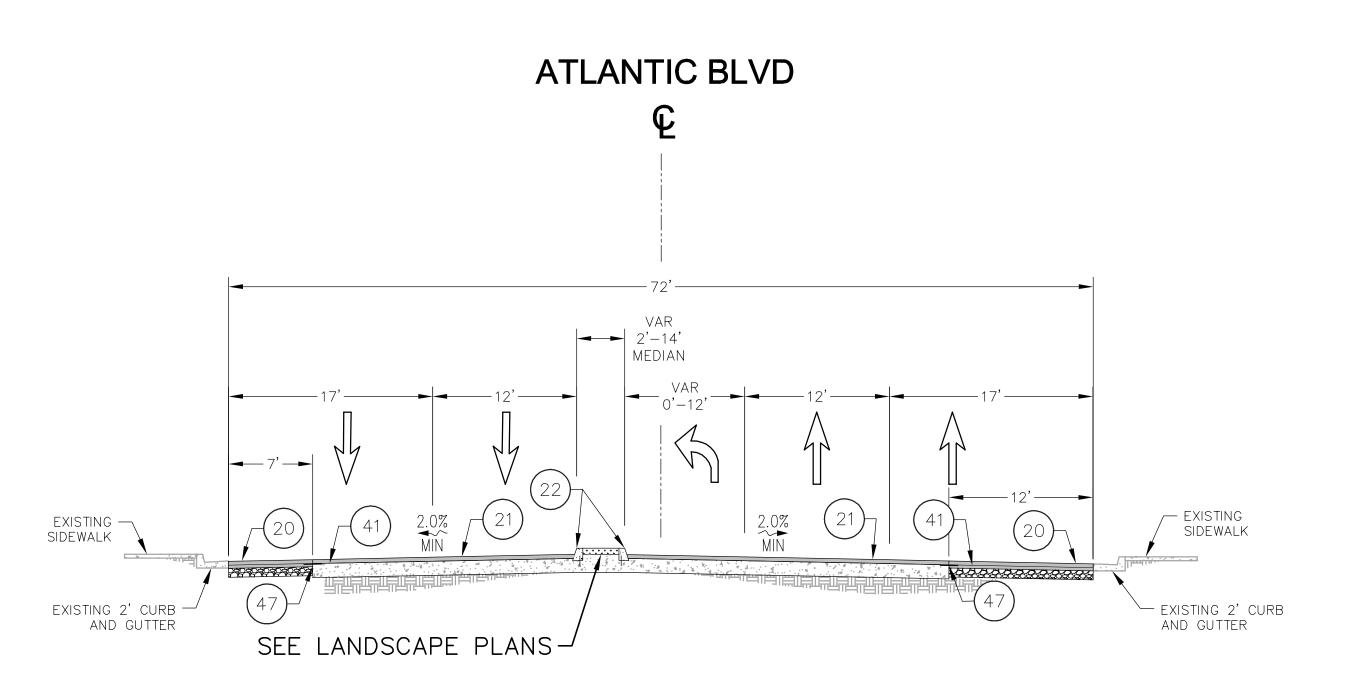

TYPICAL SECTION - EB LEFT TURN POCKET STA 26+64.51 TO STA 27+75.49 SCALE: NTS

	Underground Service Alert Call: TOLL FREE 811
TWO	WORKING DAYS BEFORE YOU DIG

NO.	REVISIONS	REVISED BY	APPROVED BY	DATE	
					1
					4



PREPARED BY:		ELEC
		––– PUBLI
		ELEC
SHEILA AMPARO, R.C.E. C78003	8/14/2018 DATE	TITLE


ELECTRONICALLY APPROVED BY:		
PUBLIC WORKS & DEV. SERVICES DIRECTOR	DATE	ŀ
ELECTRONICALLY CHECKED BY:		
TITI F	DATE	

CITY OF COMMERCE PUBLIC WORKS AND ENGINEERING DEPARTMENT ATLANTIC BOULEVARD CORRIDOR IMPROVEMENTS

TYPICAL SECTIONS

DRWG NO. SHEET 3 OF 43 SHEETS

X-2

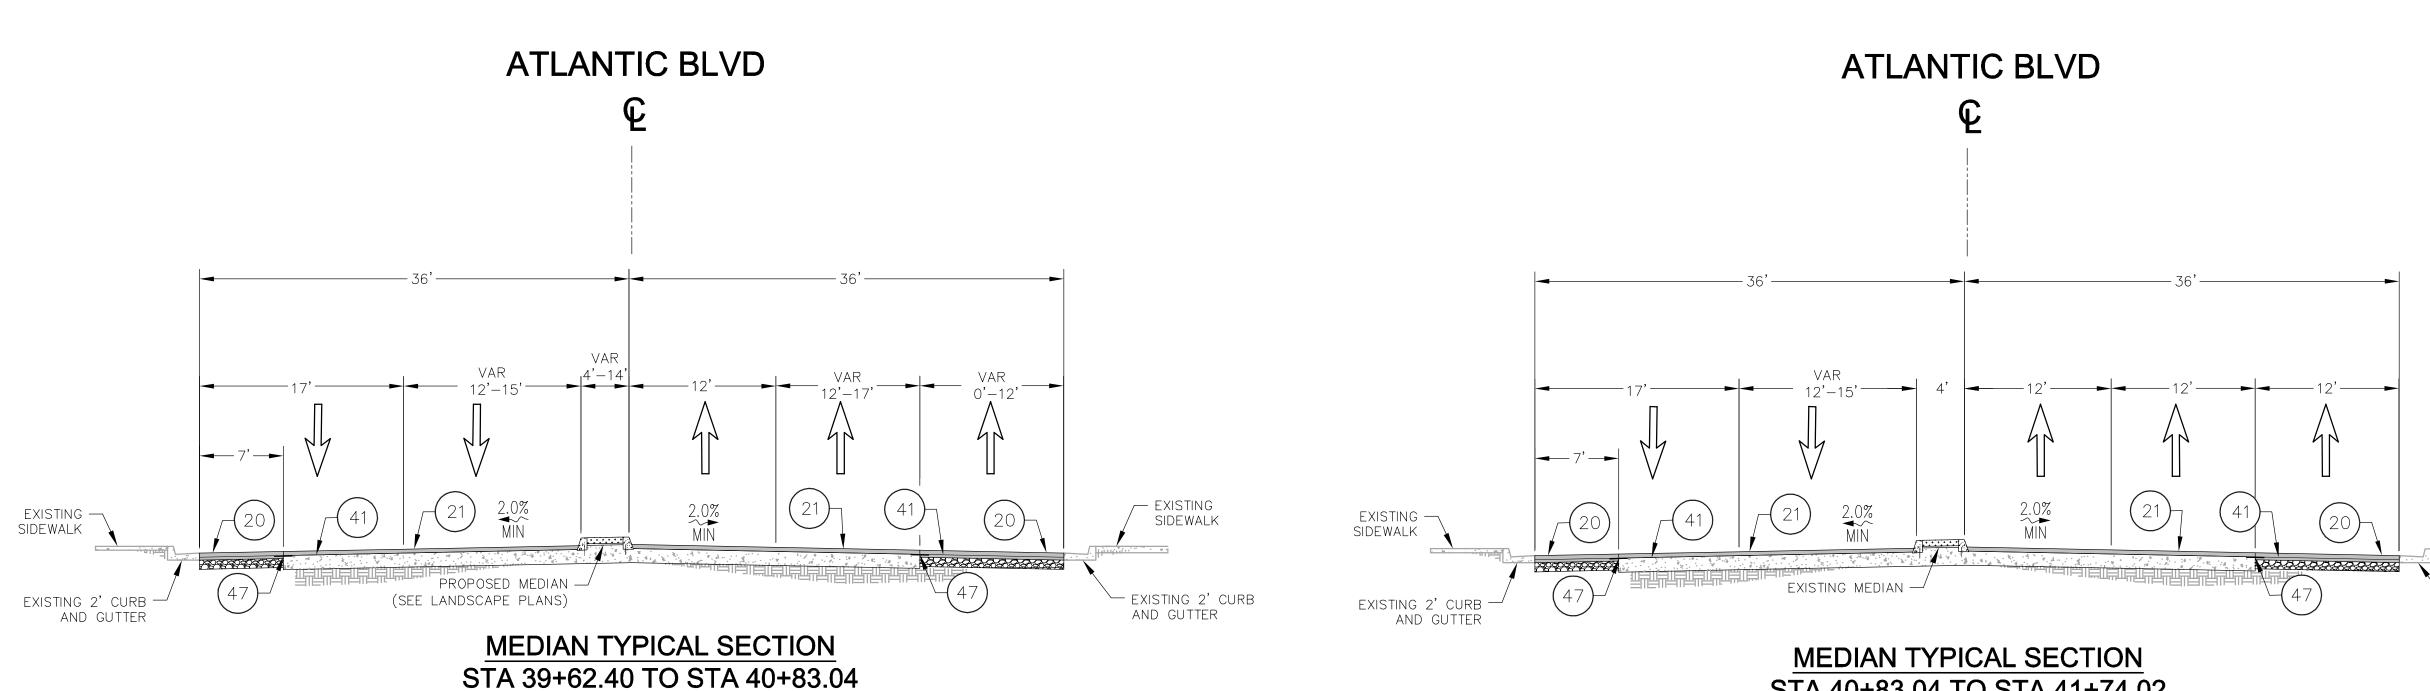

SCALE: NTS

STA 40+83.04 TO STA 41+74.02

SCALE: NTS

CONSTRUCTION NOTES

(20) CONSTRUCT 7.0" HMA OVER 9" CAB (CLASS II)

(21) construct 4.0" min hma over grinded PCC pavement

CONSTRUCT CURB PER SPPWC STD DWG NO. 120-2, TYPE
A1-8(200) (MODIFIED). SEE CONSTRUCTION DETAIL 21 ON CD-3
FOR CURB DETAIL

(41) INSTALL 3/8" MINIMUM ARAM FABRIC FROM EDGE OF GUTTER TO MEDIAN CURB, UNLESS NOTED OTHERWISE

17 INSTALL MTK FABRIC LONGITUDINALLY BETWEEN THE PCC PAVEMENT EDGE AND AC/AB PAVEMENT SECTION

LEGEND:

EXISTING PCC

PROPOSED COARSE AGGREGATE BASE (CLASS II)

EXISTING NATIVE SOIL


PROPOSED HOT MIX ASPHALT CONCRETE

NOTES:


/ EXISTING SIDEWALK

EXISTING 2' CURB AND GUTTER

- 1. CONTRACTOR SHALL MATCH EXISTING EDGE OF GUTTER
- 2. CONTRACTOR SHALL POSITIVELY LOCATE ALL EXISTING SUBSTRUCTURE FACILITIES AND PROTECT IN PLACE.
- 3. CONTRACTOR SHALL BE RESPONSIBLE FOR ANY DAMAGES TO EXISTING FACILITIES AND REPLACE/REPAIR AT NO ADDITIONAL COST TO THE CITY.
- 4. CONTRACTOR SHALL PROVIDE SURVEY STAKING PRIOR TO POURING CONCRETE OR PAVEMENT TO THE CITY FOR REVIEW AND APPROVAL. ANY CONCRETE OR PAVEMENT POURED WITHOUT CITY APPROVAL, SHALL BE AT THE EXPENSE OF THE CONTRACTOR IF REMOVAL IS REQUIRED.

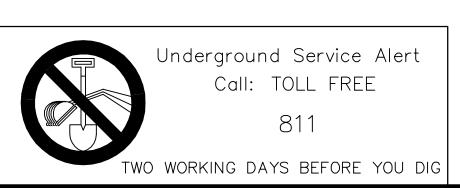

NO.	REVISIONS	REVISED BY	APPROVED BY	DATE		PREPARED BY:	
					PROFESSION TO THE PROFESSION OF THE PROFESSION O		
					78003 Exp 9-30-19 C/V/L OF CALIFORNIA	SHEILA AMPARO, R.C.E. C78003 8/14/2018 DATE	

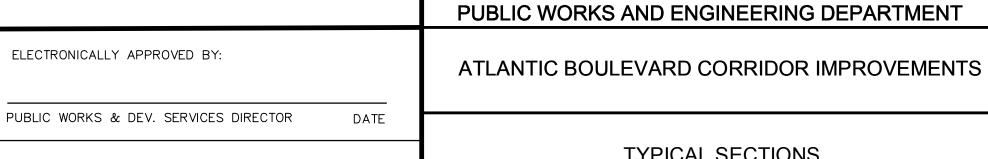


ELECTRONICALLY CHECKED BY:


TYPICAL SECTIONS


CITY OF COMMERCE


DRWG NO. SHEET 5 OF 43 SHEETS


X-3

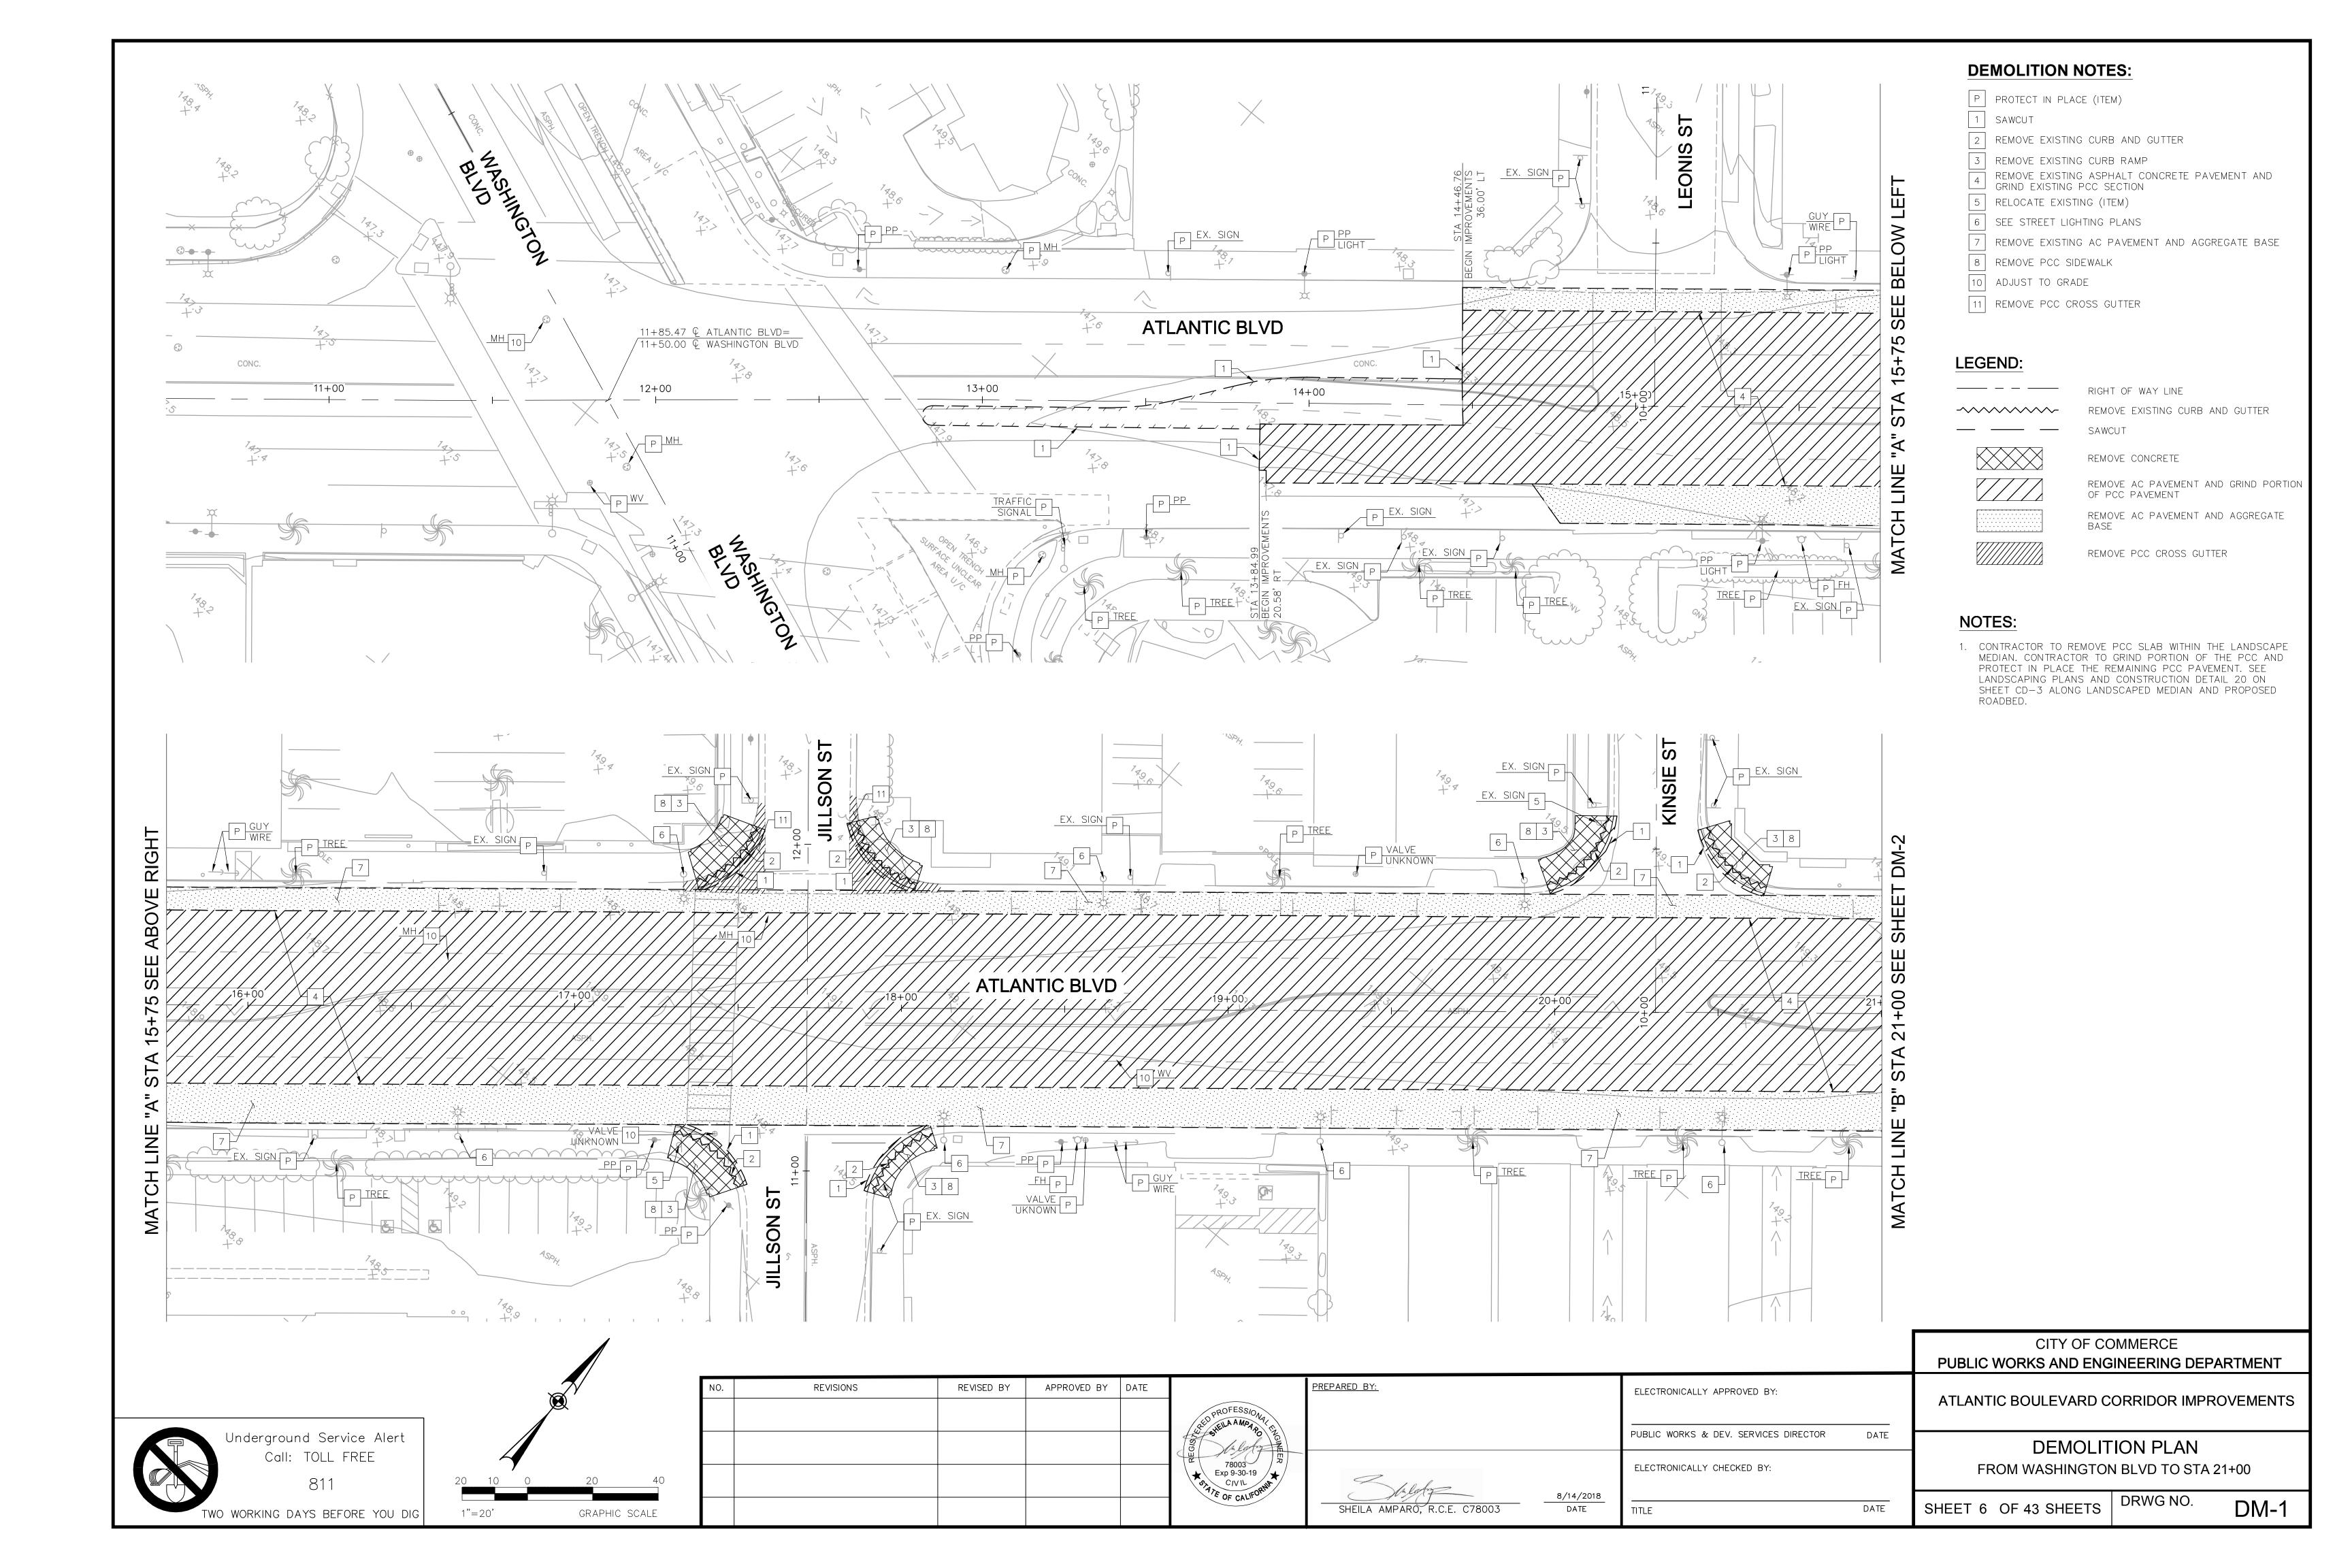


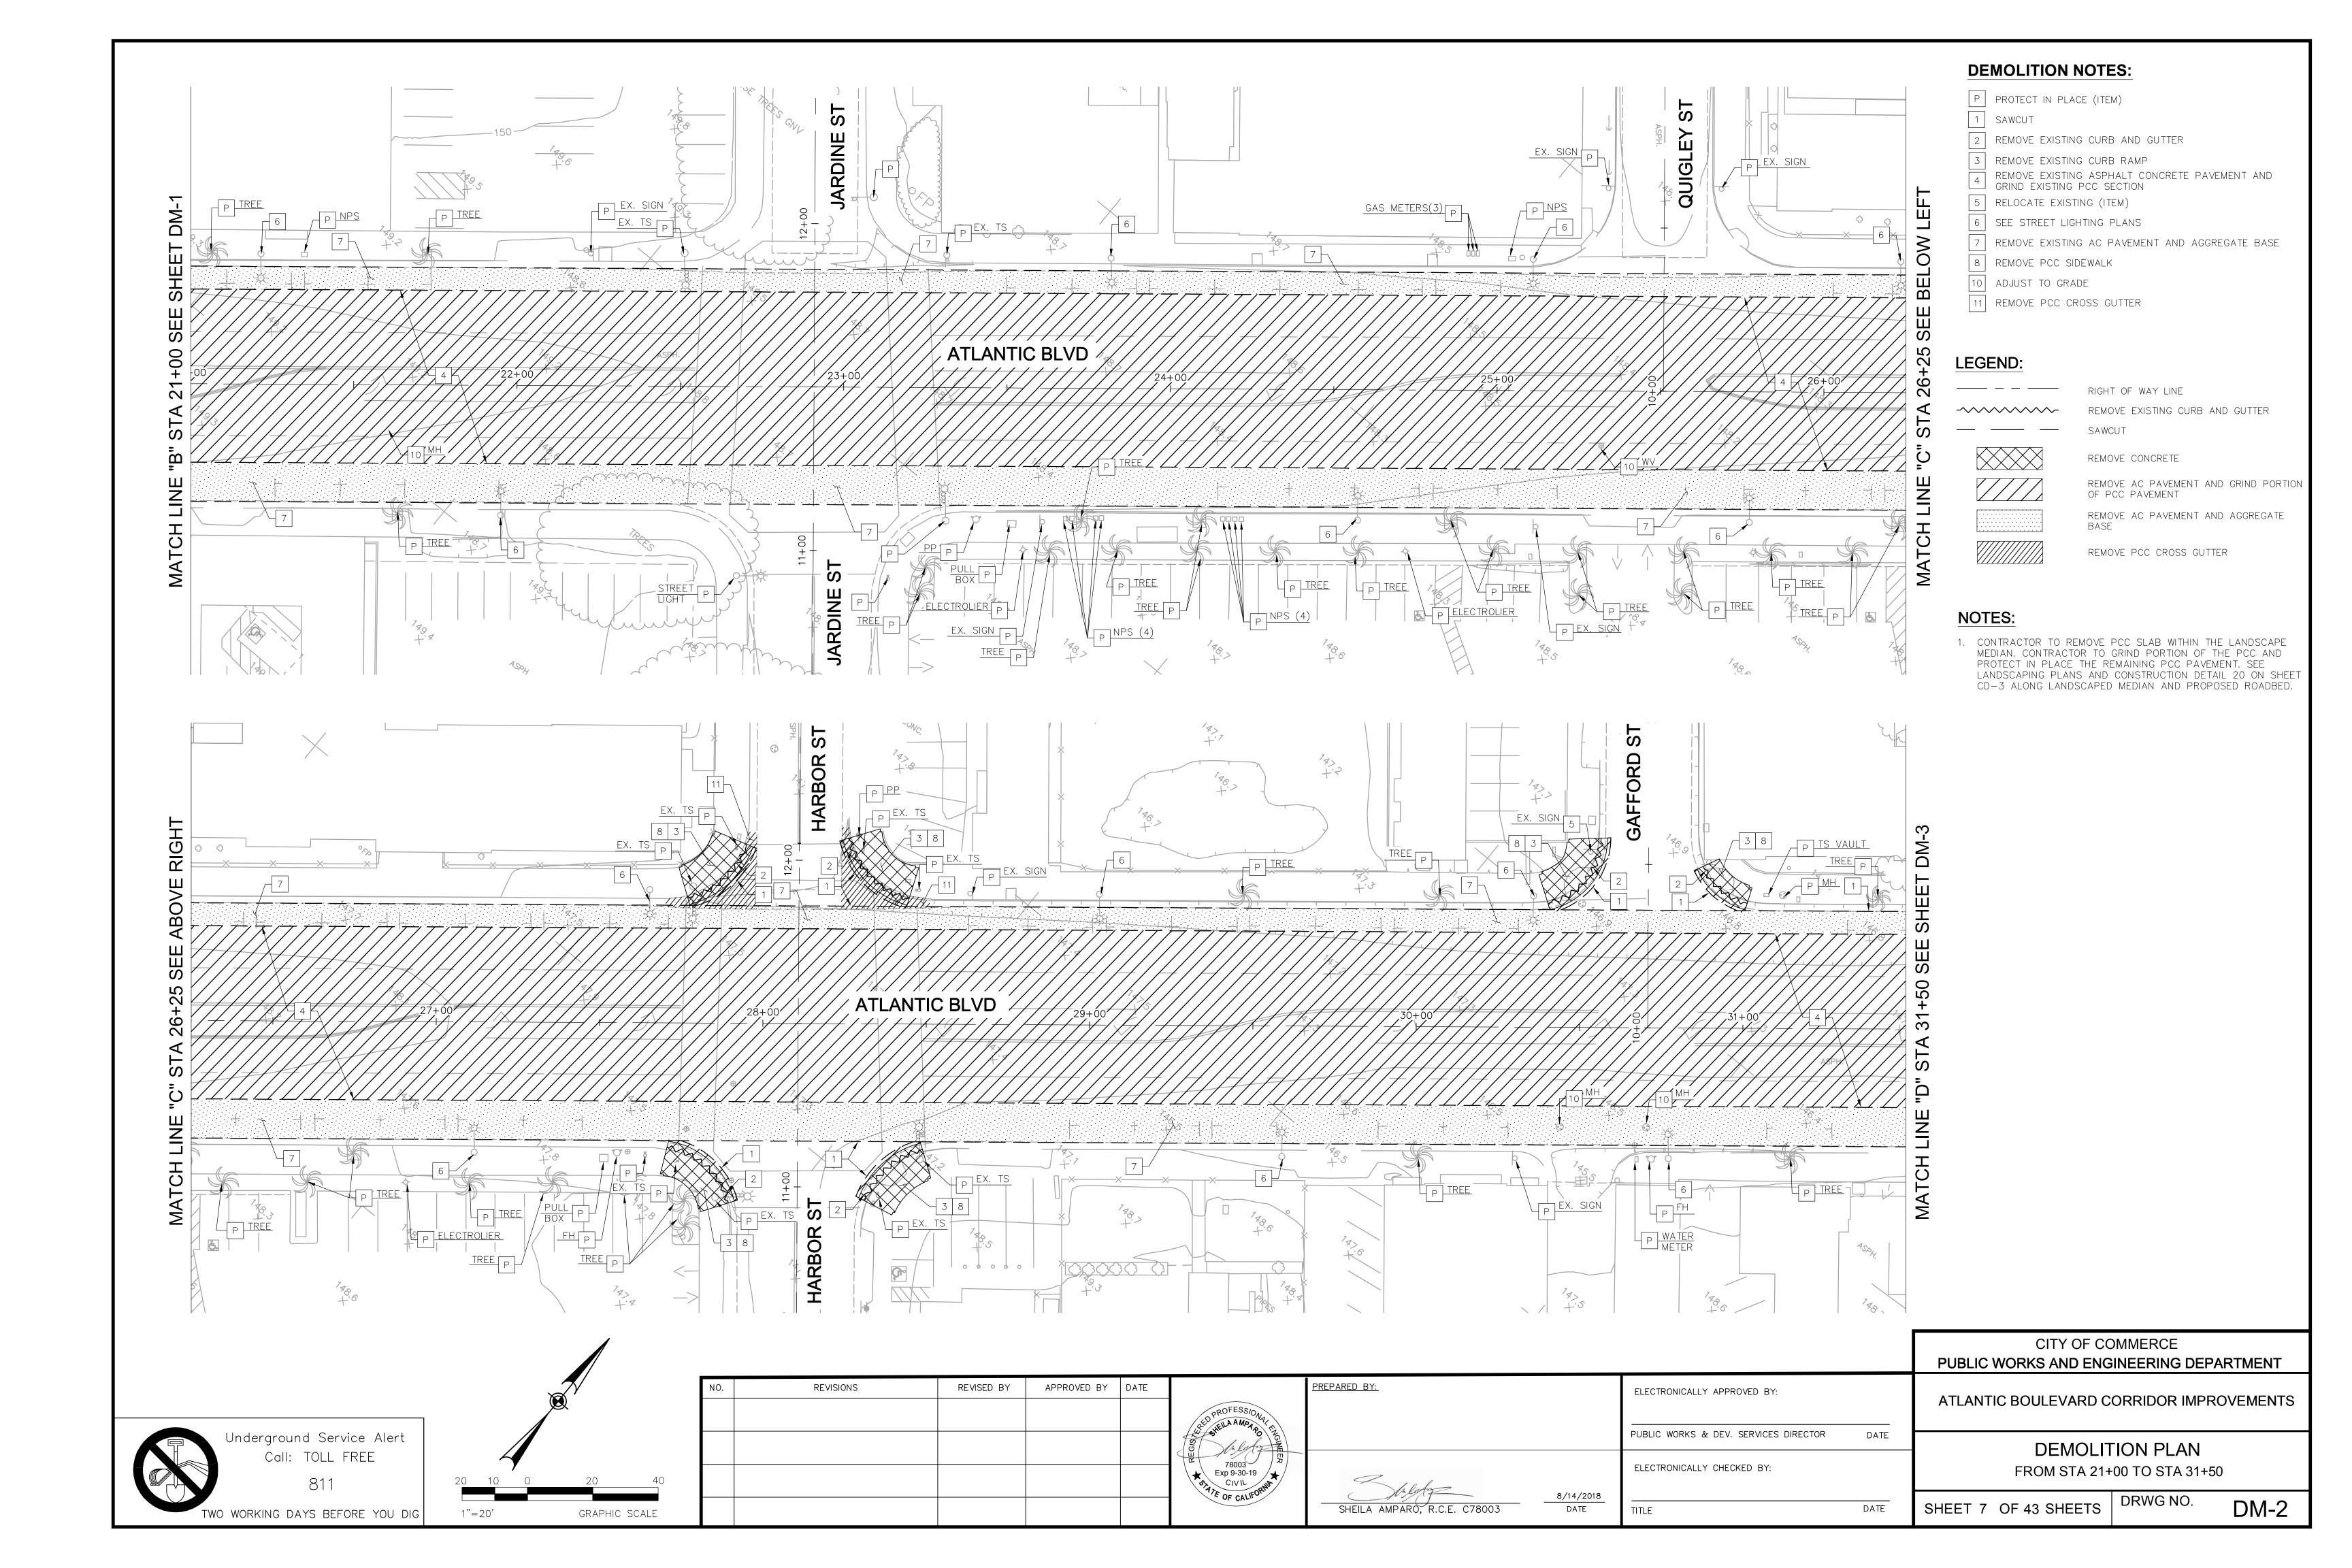


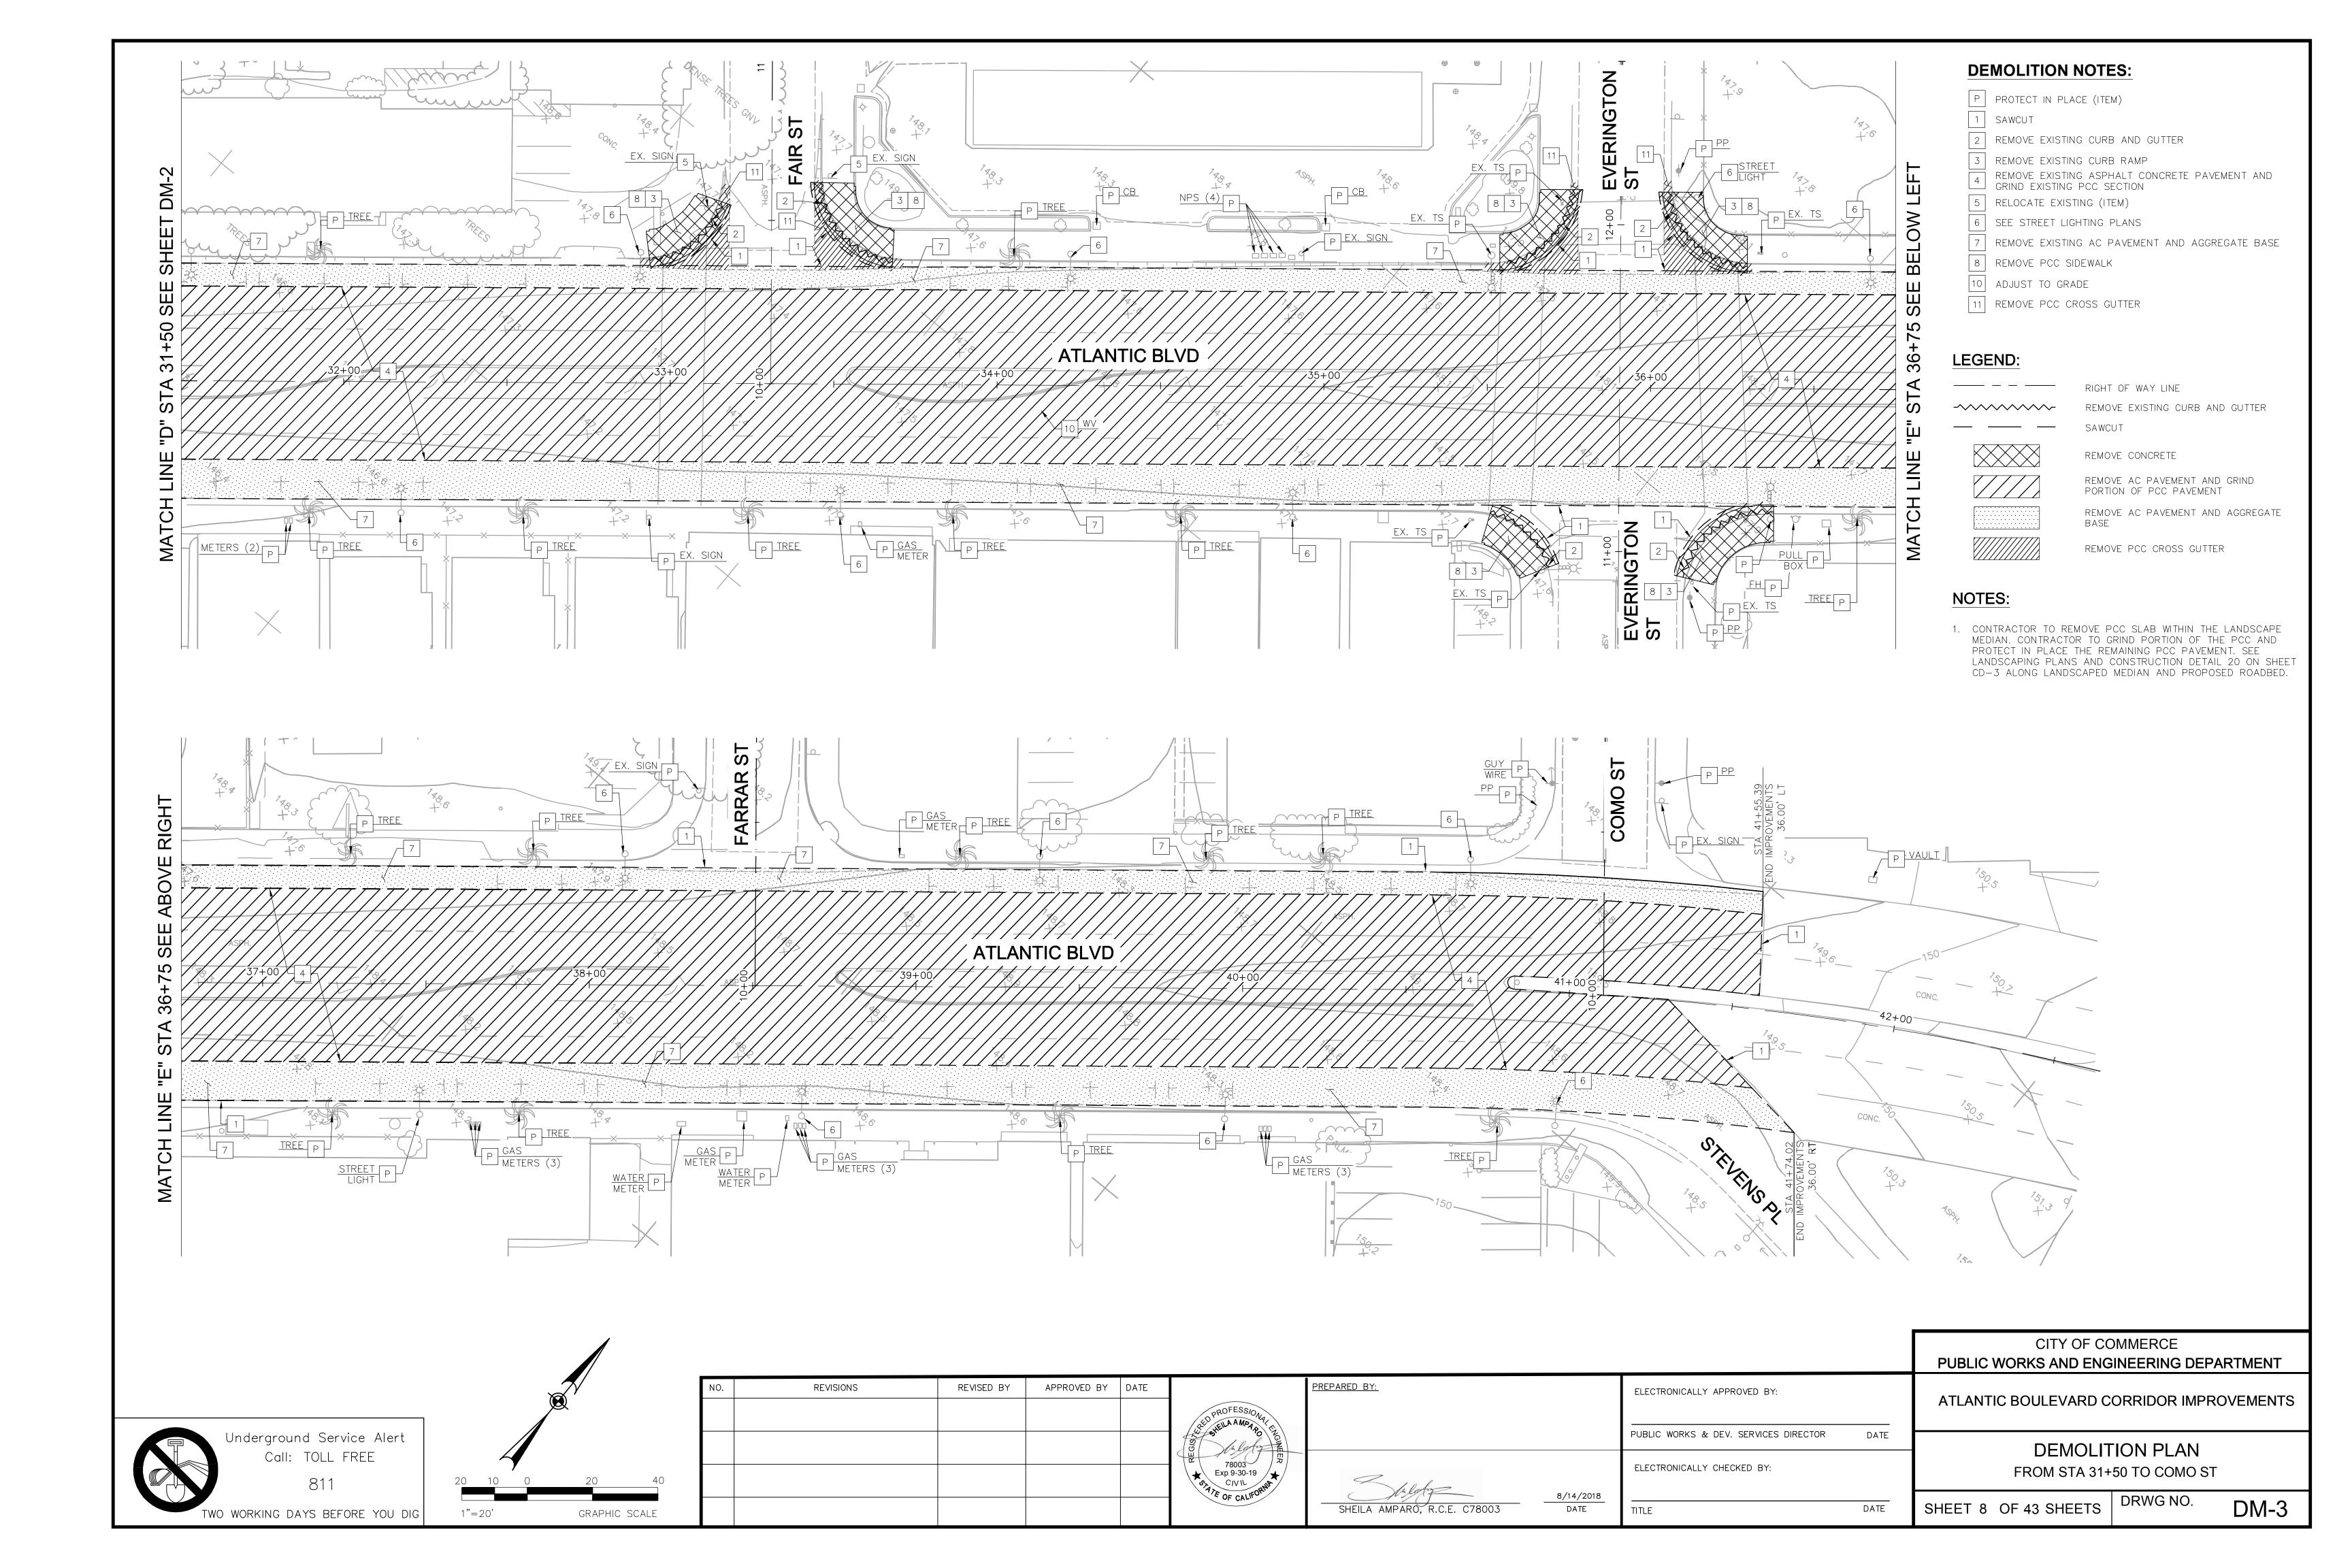


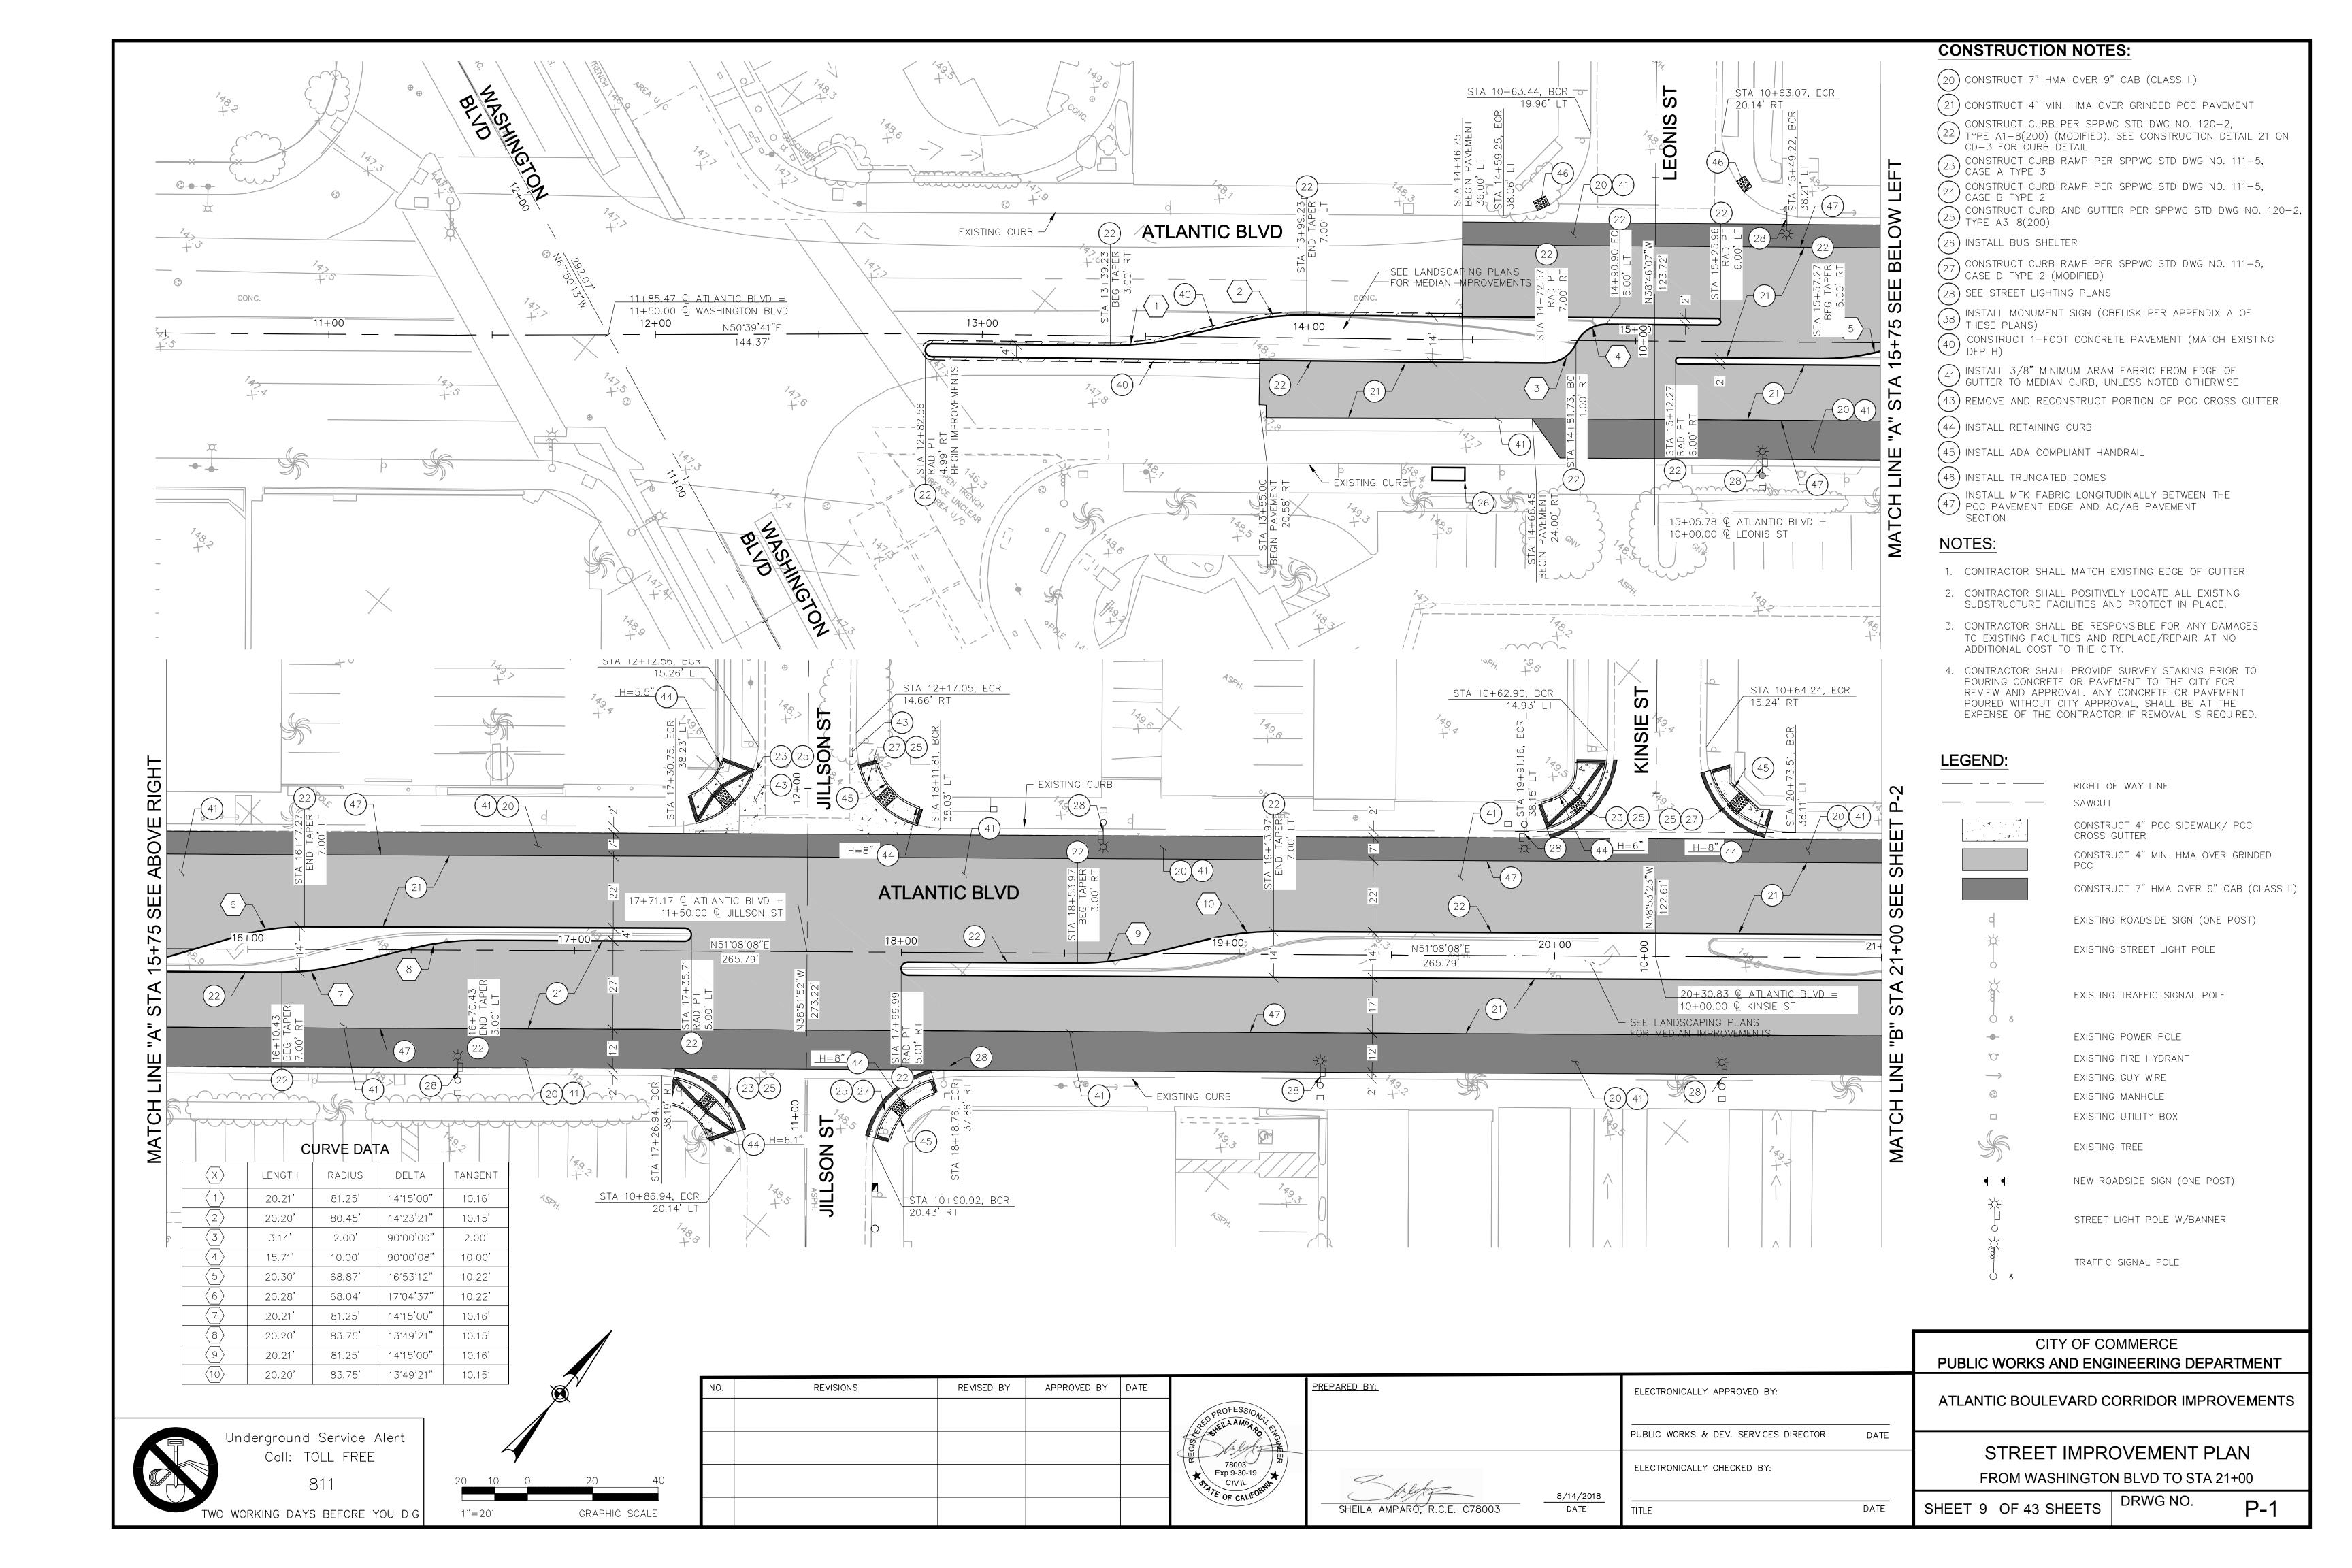


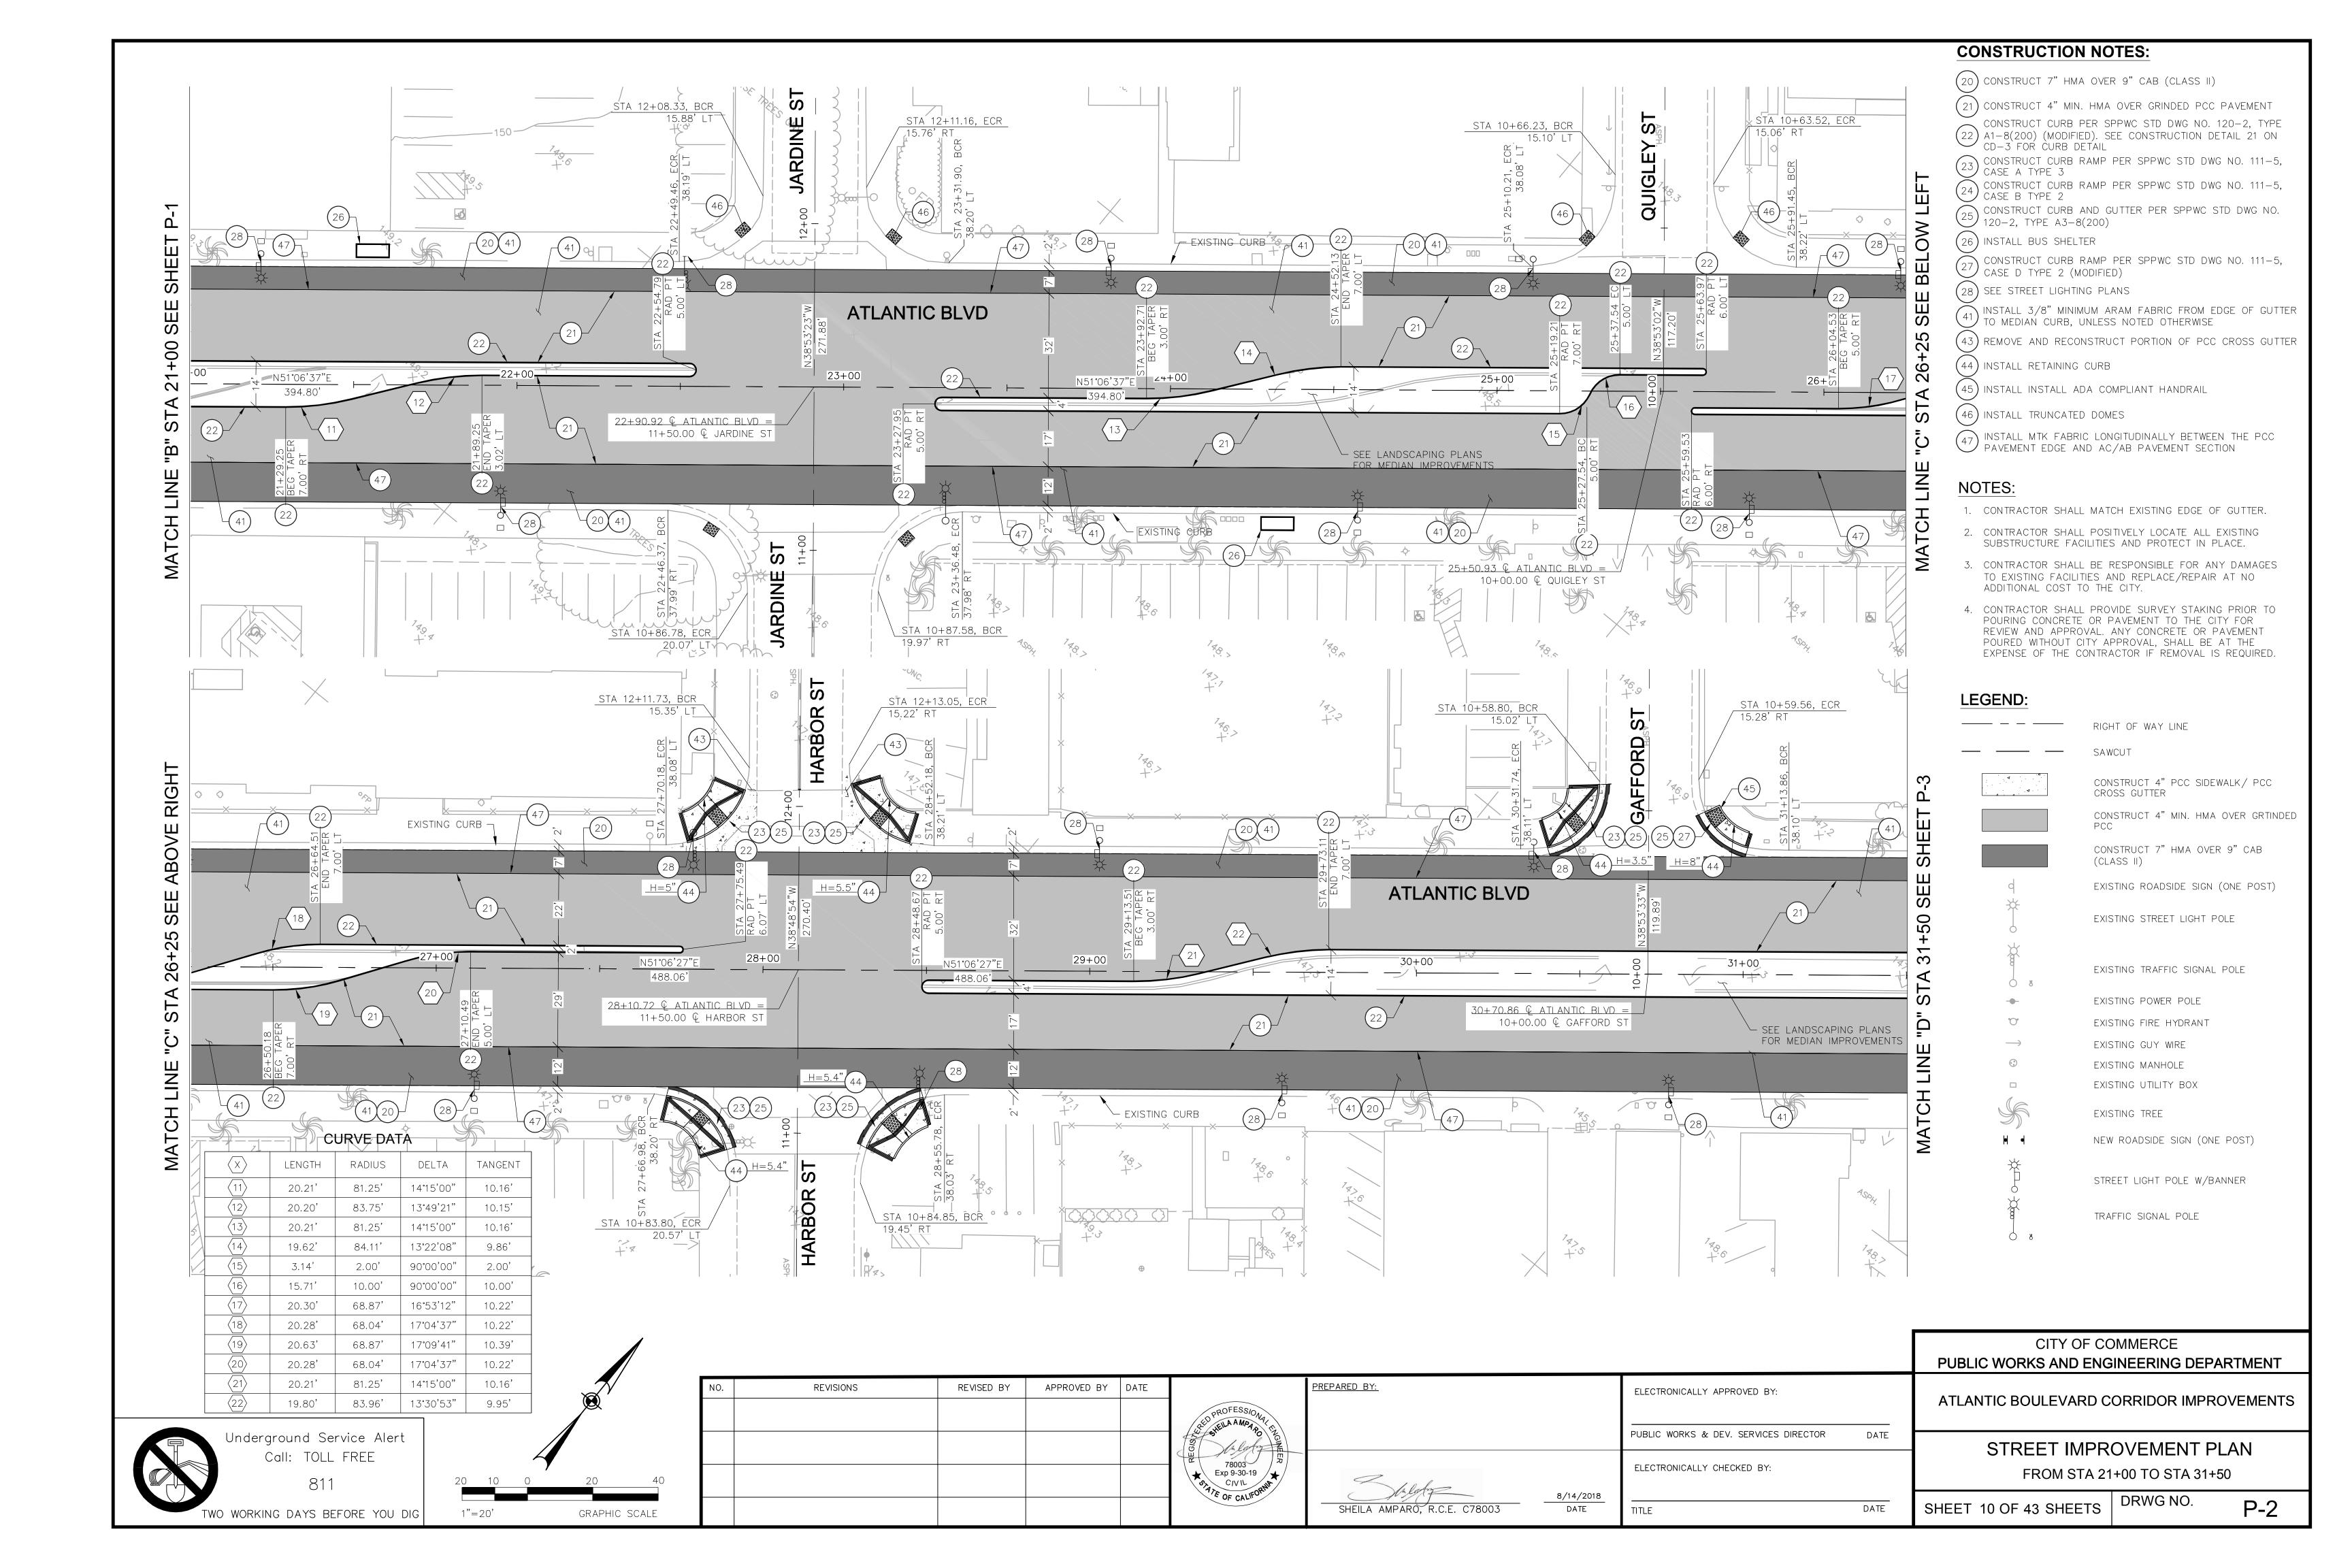


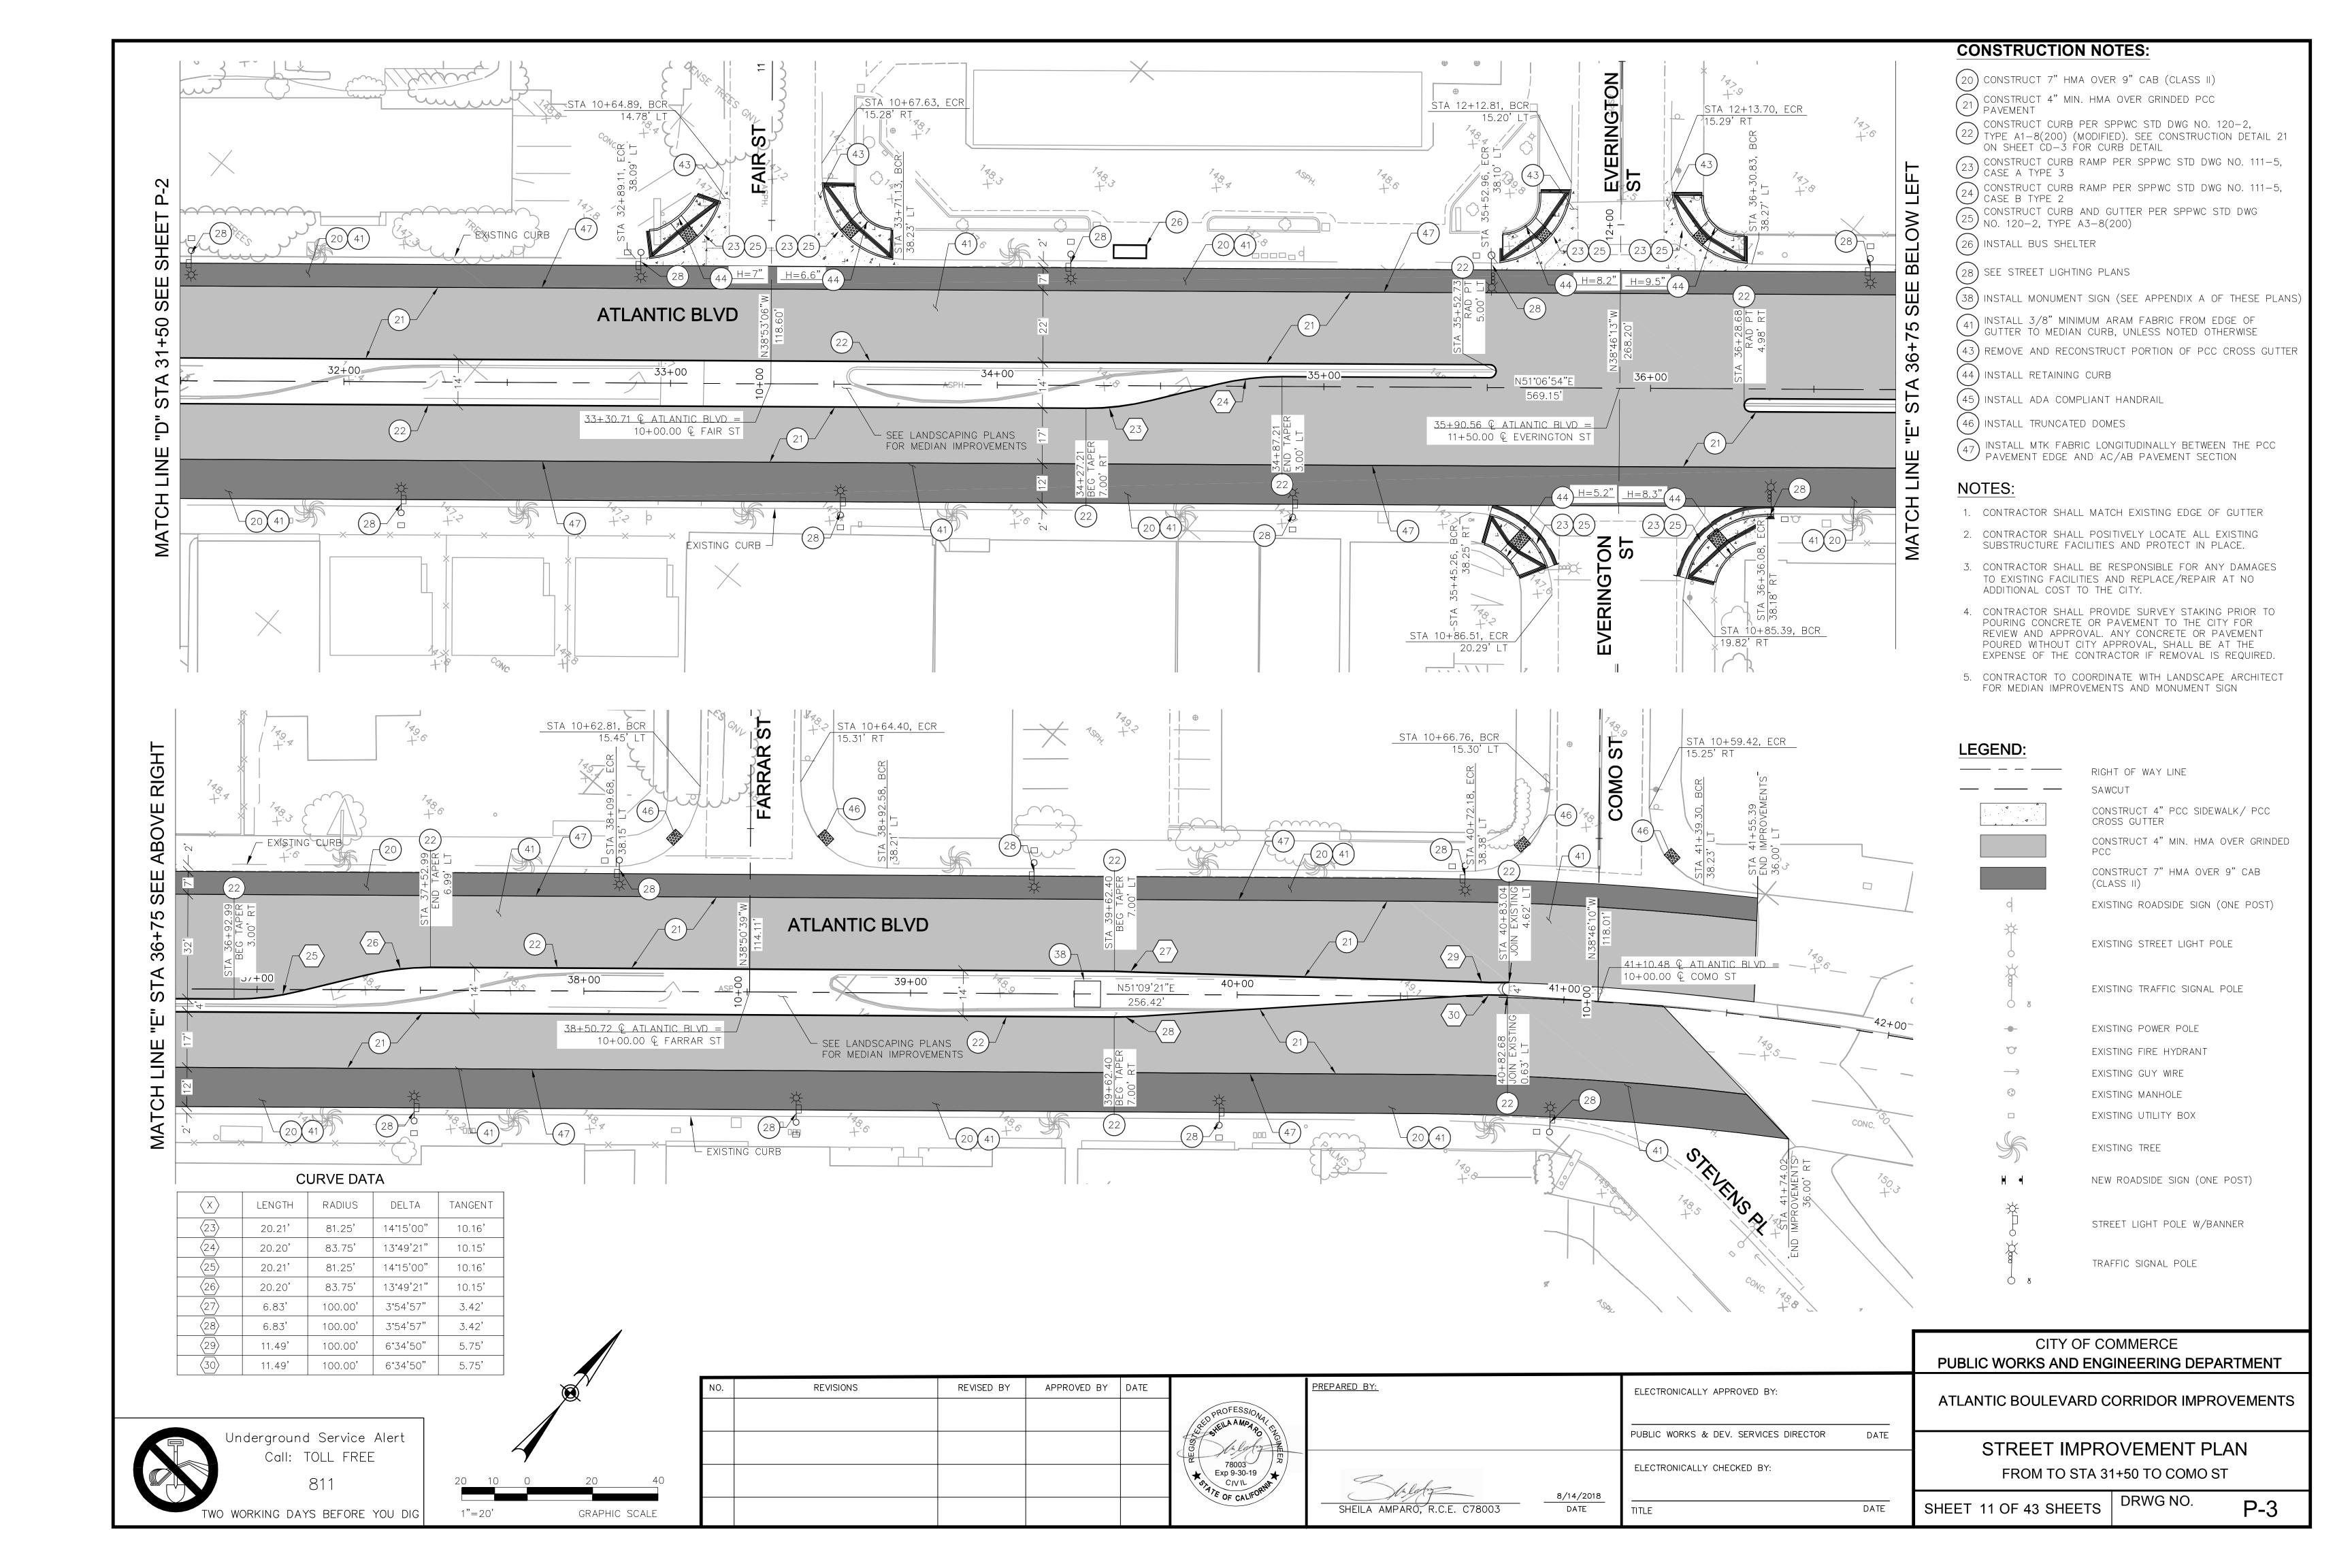


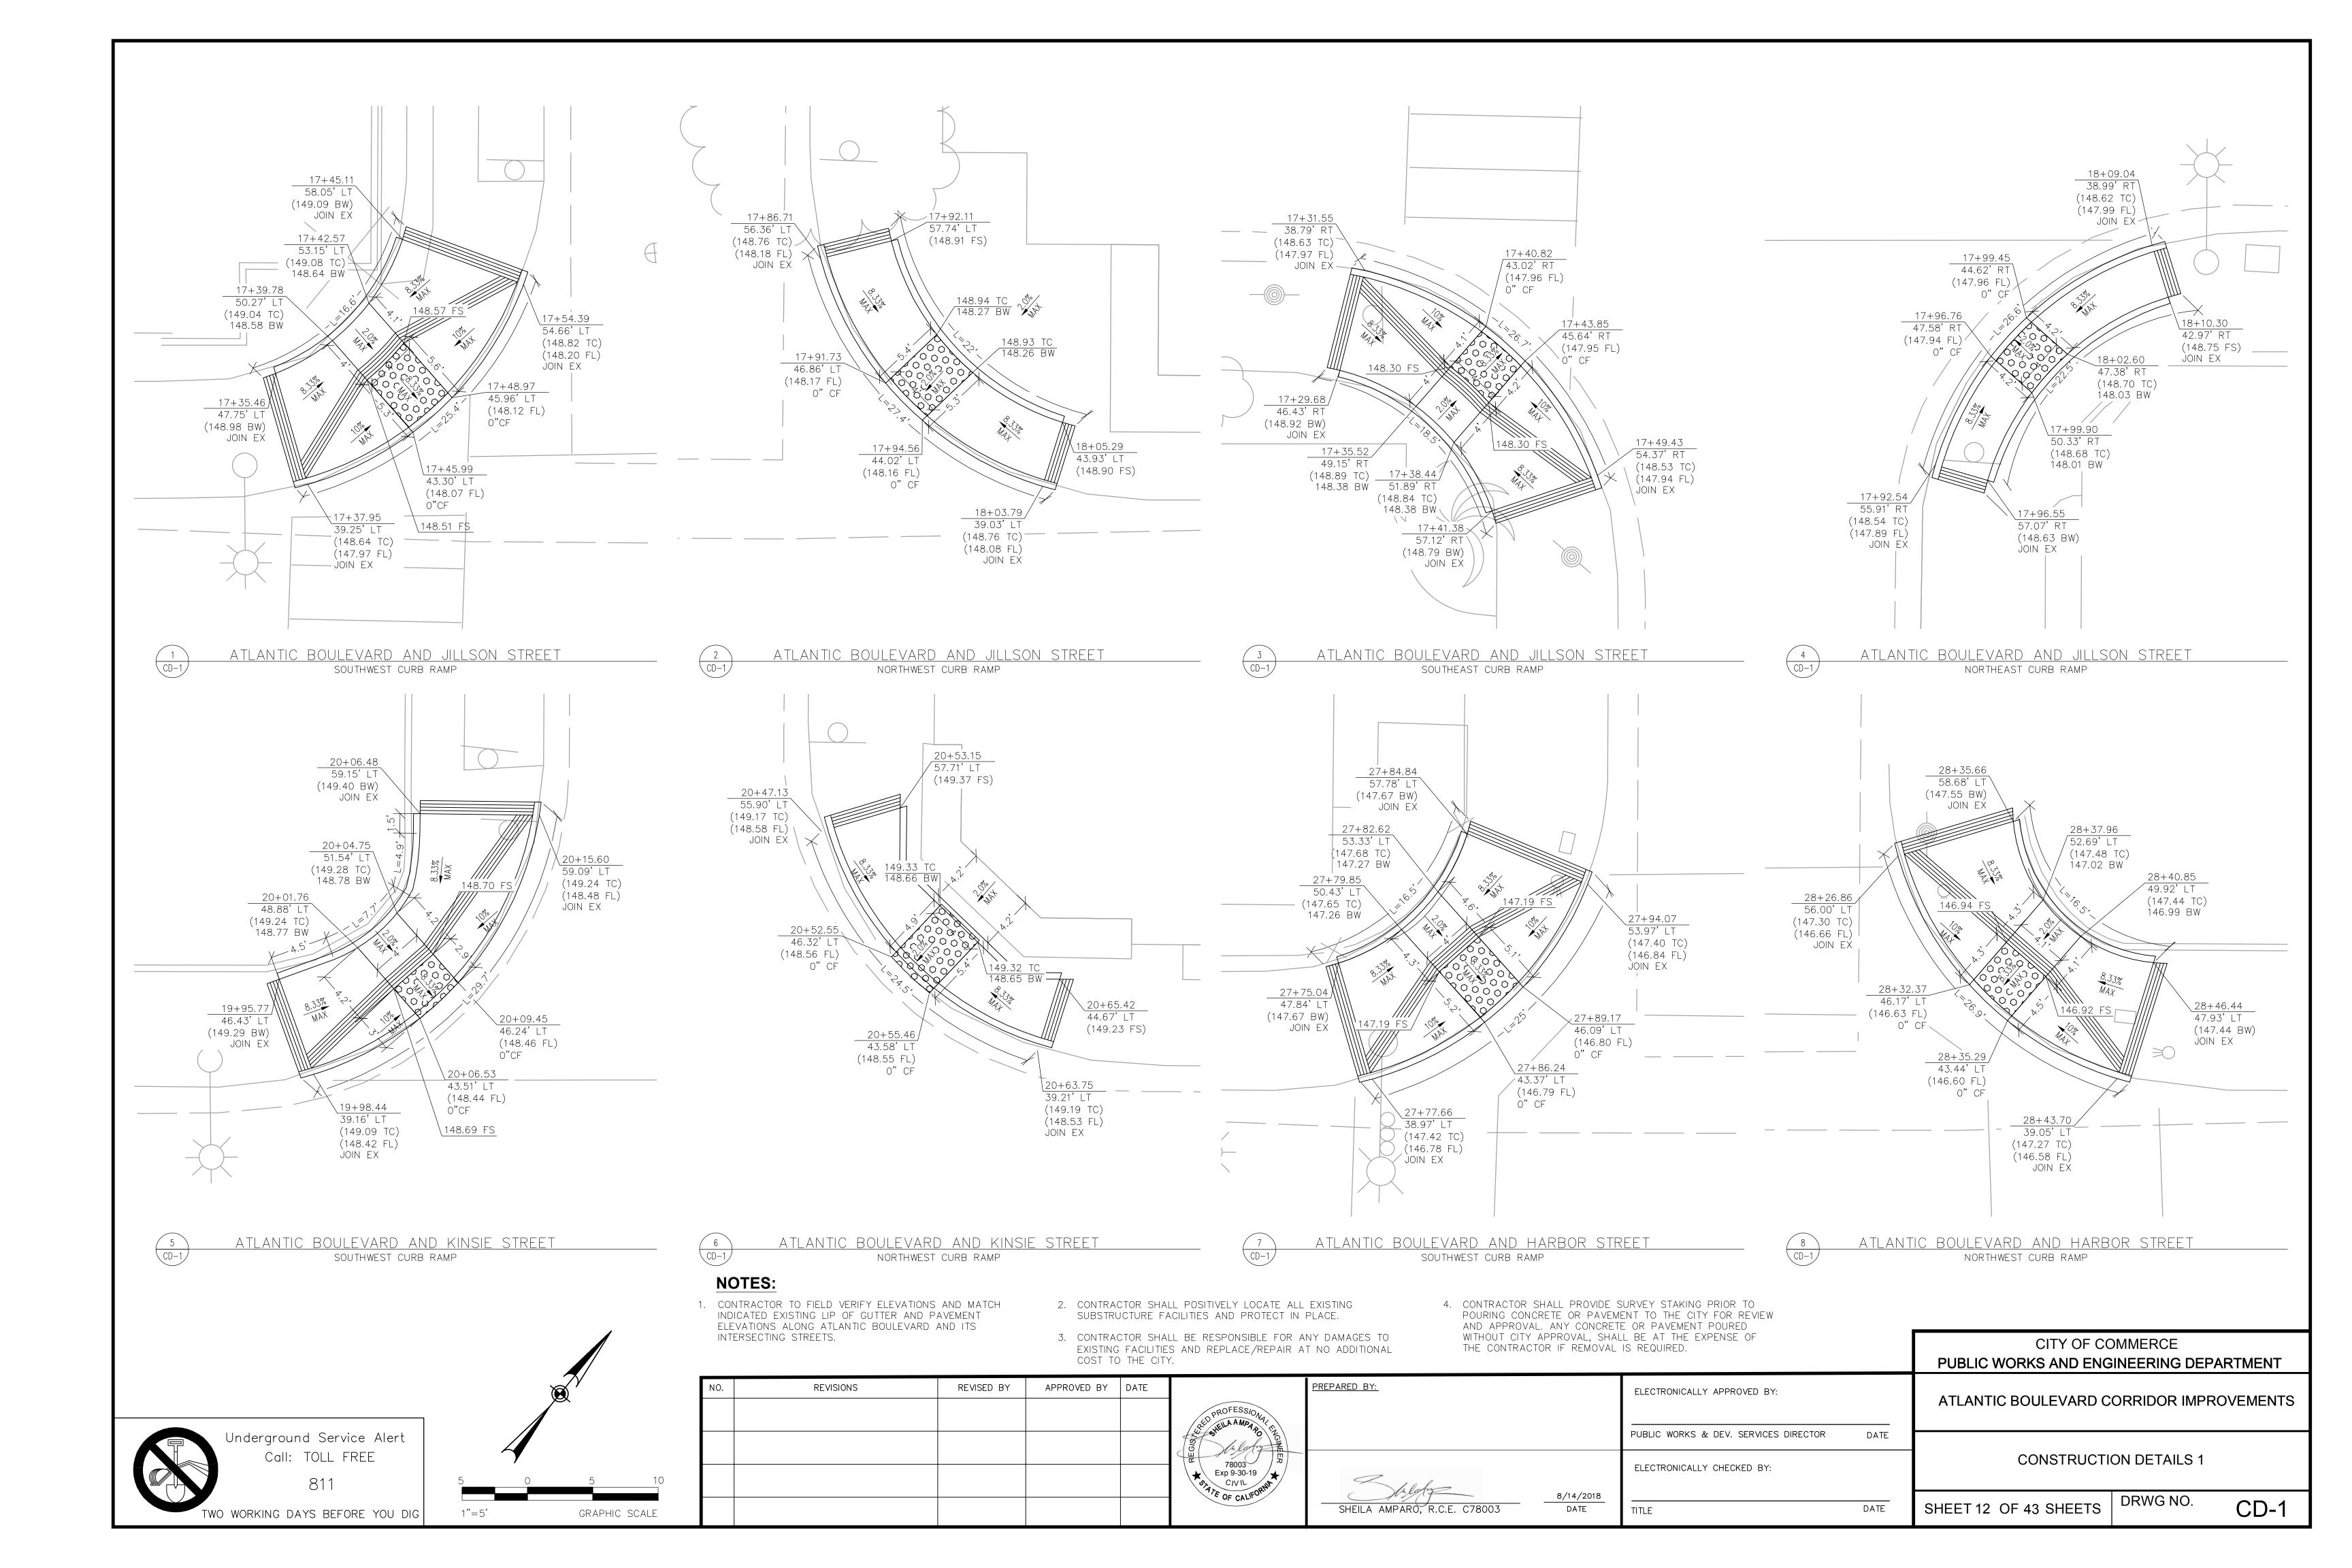


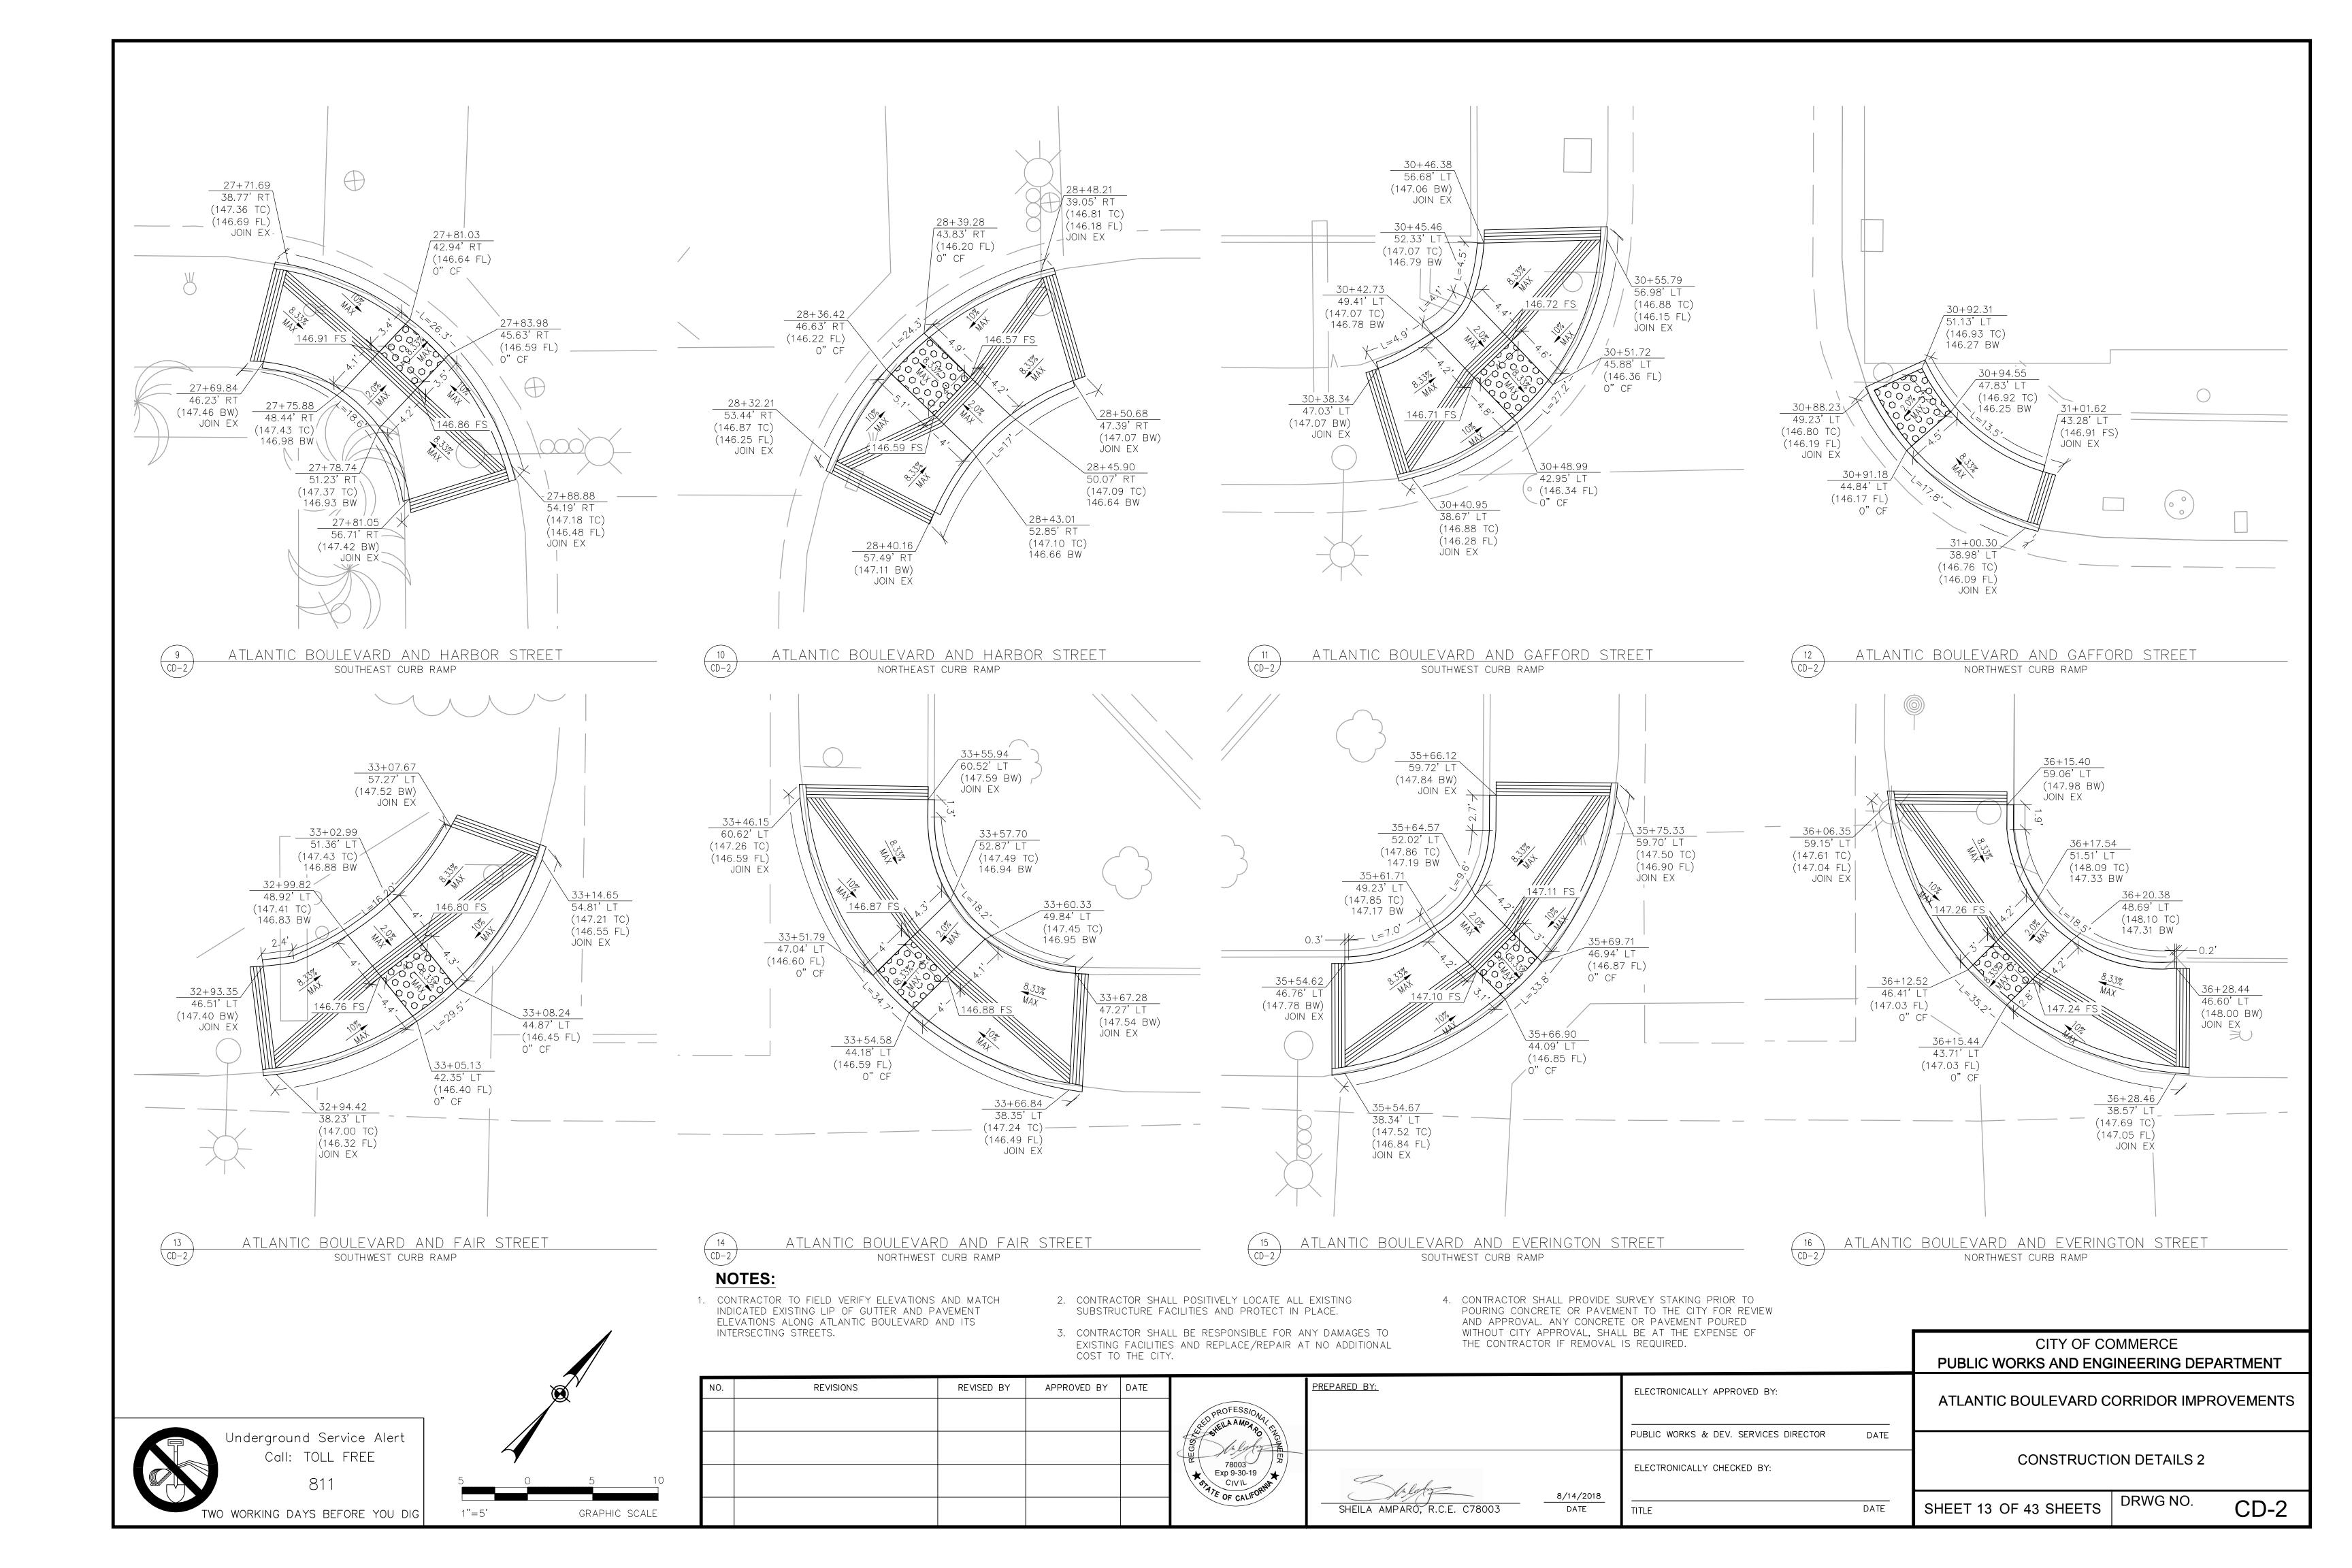


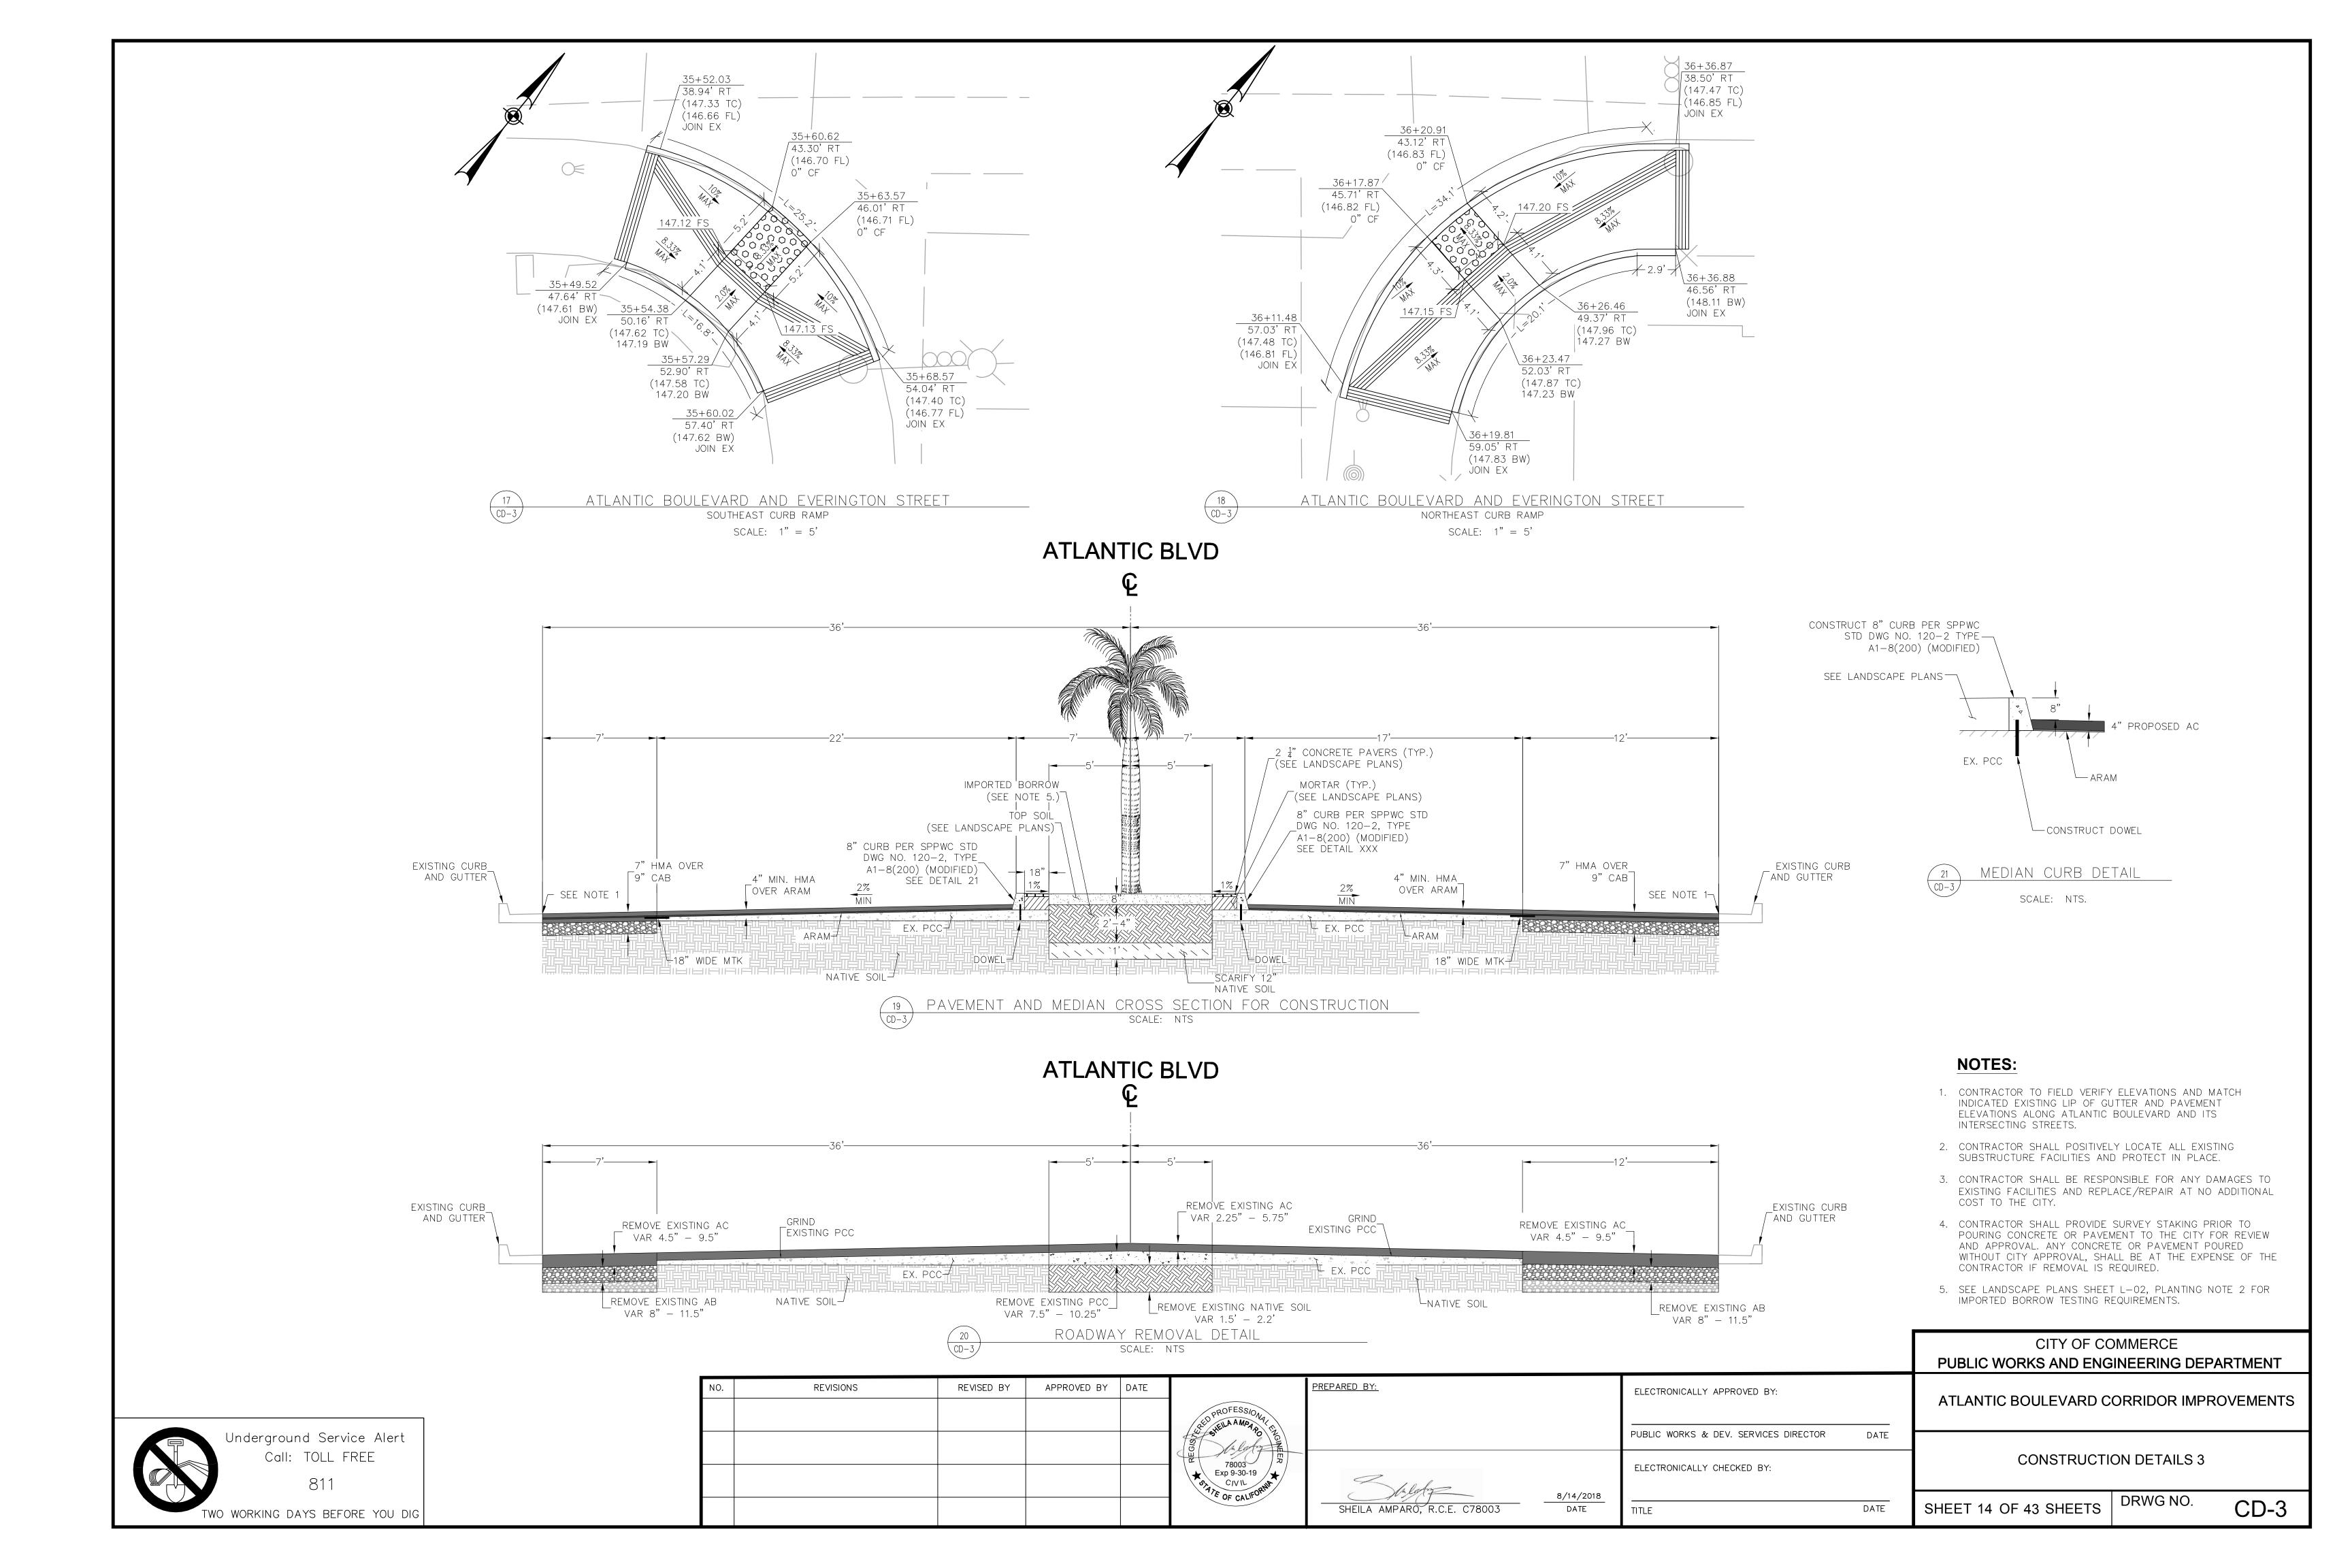

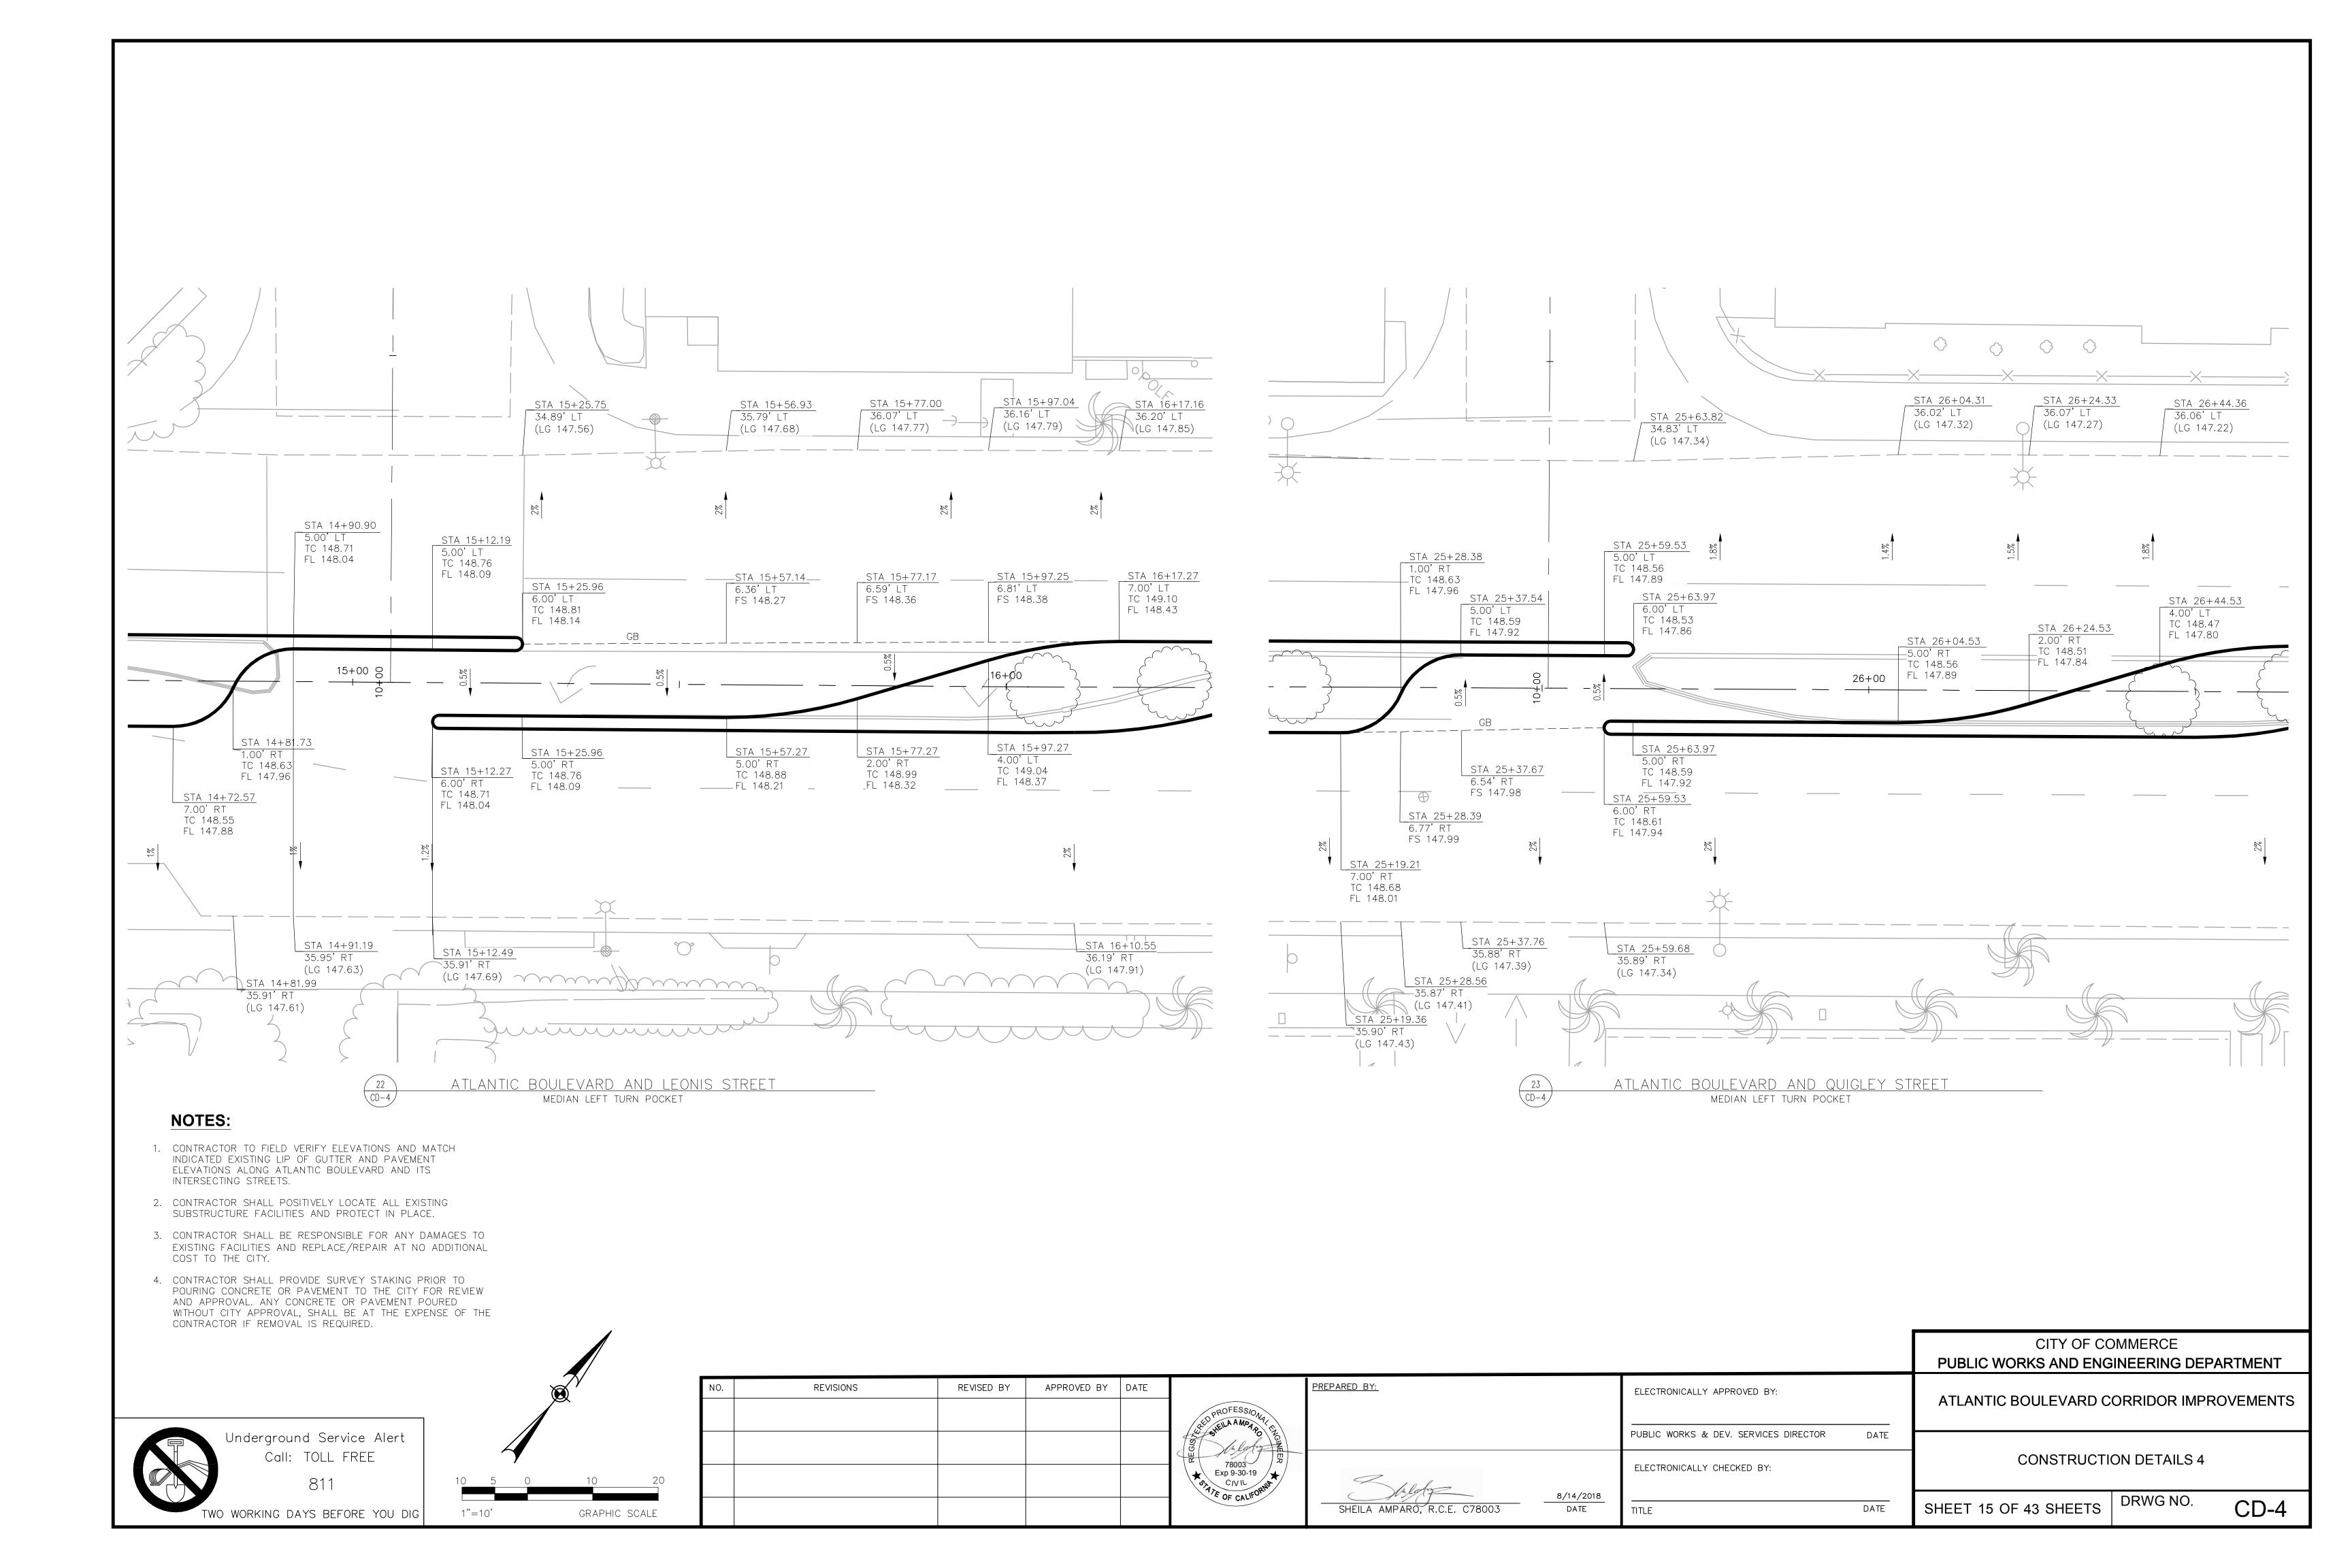

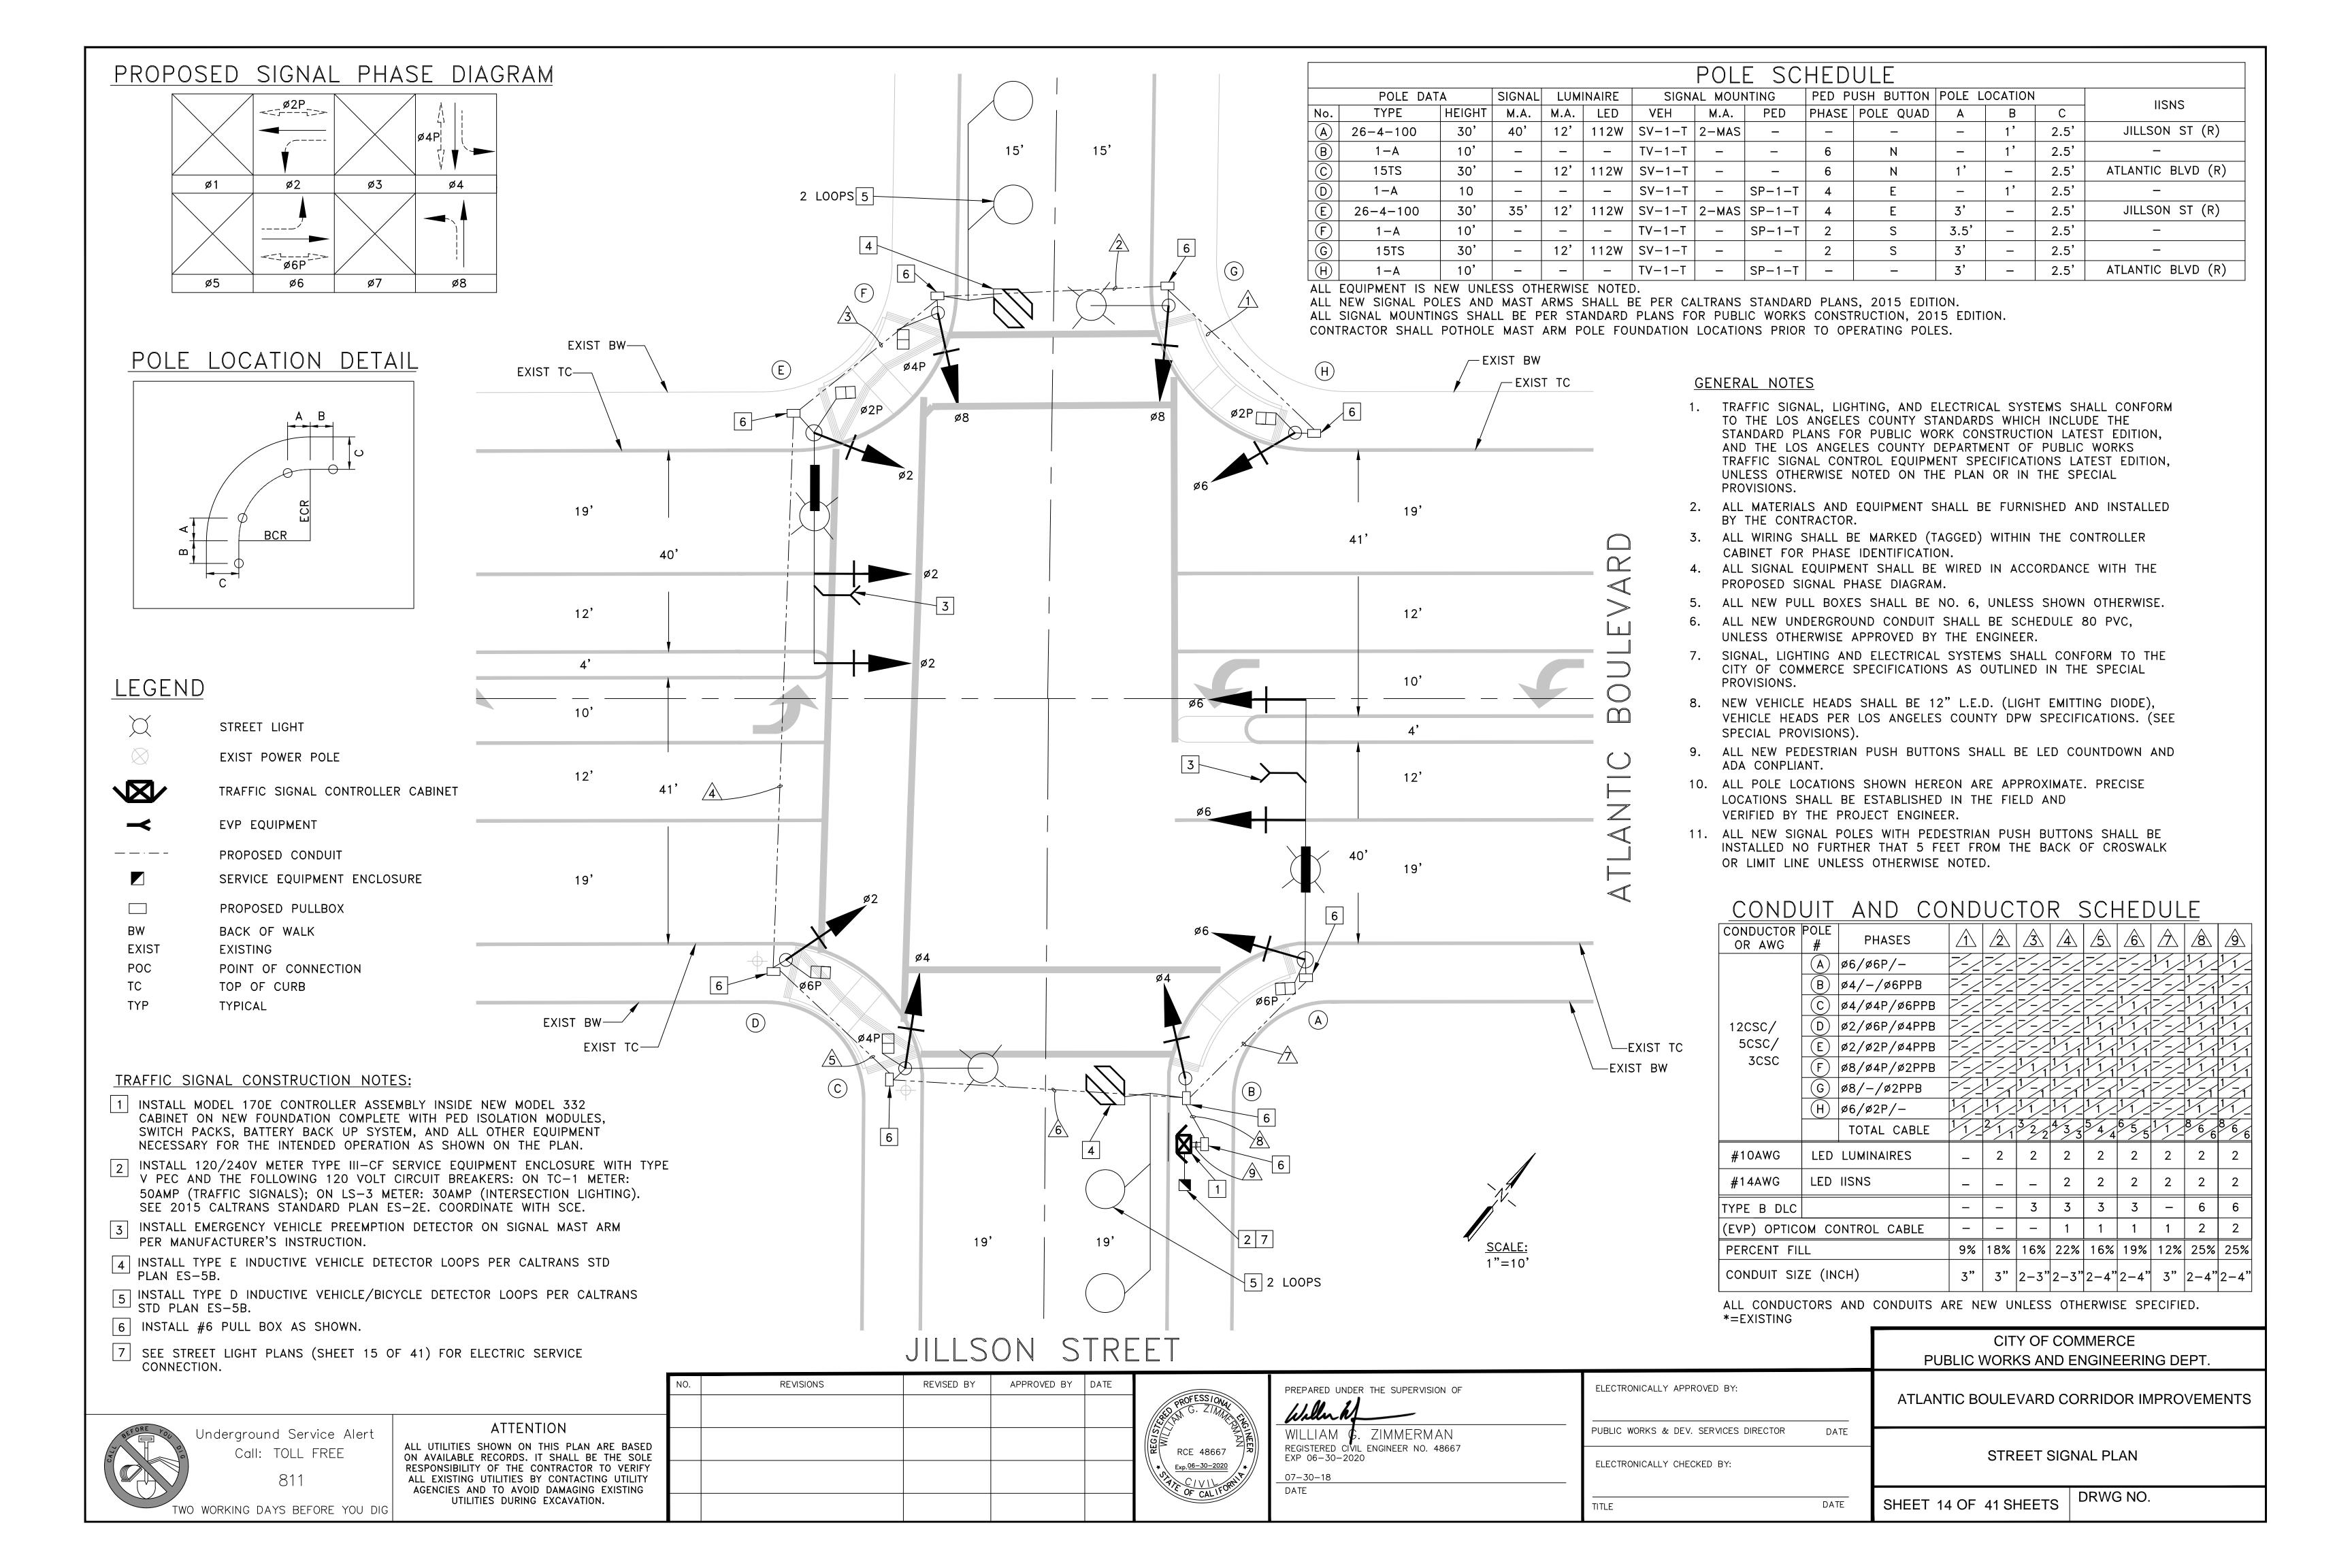

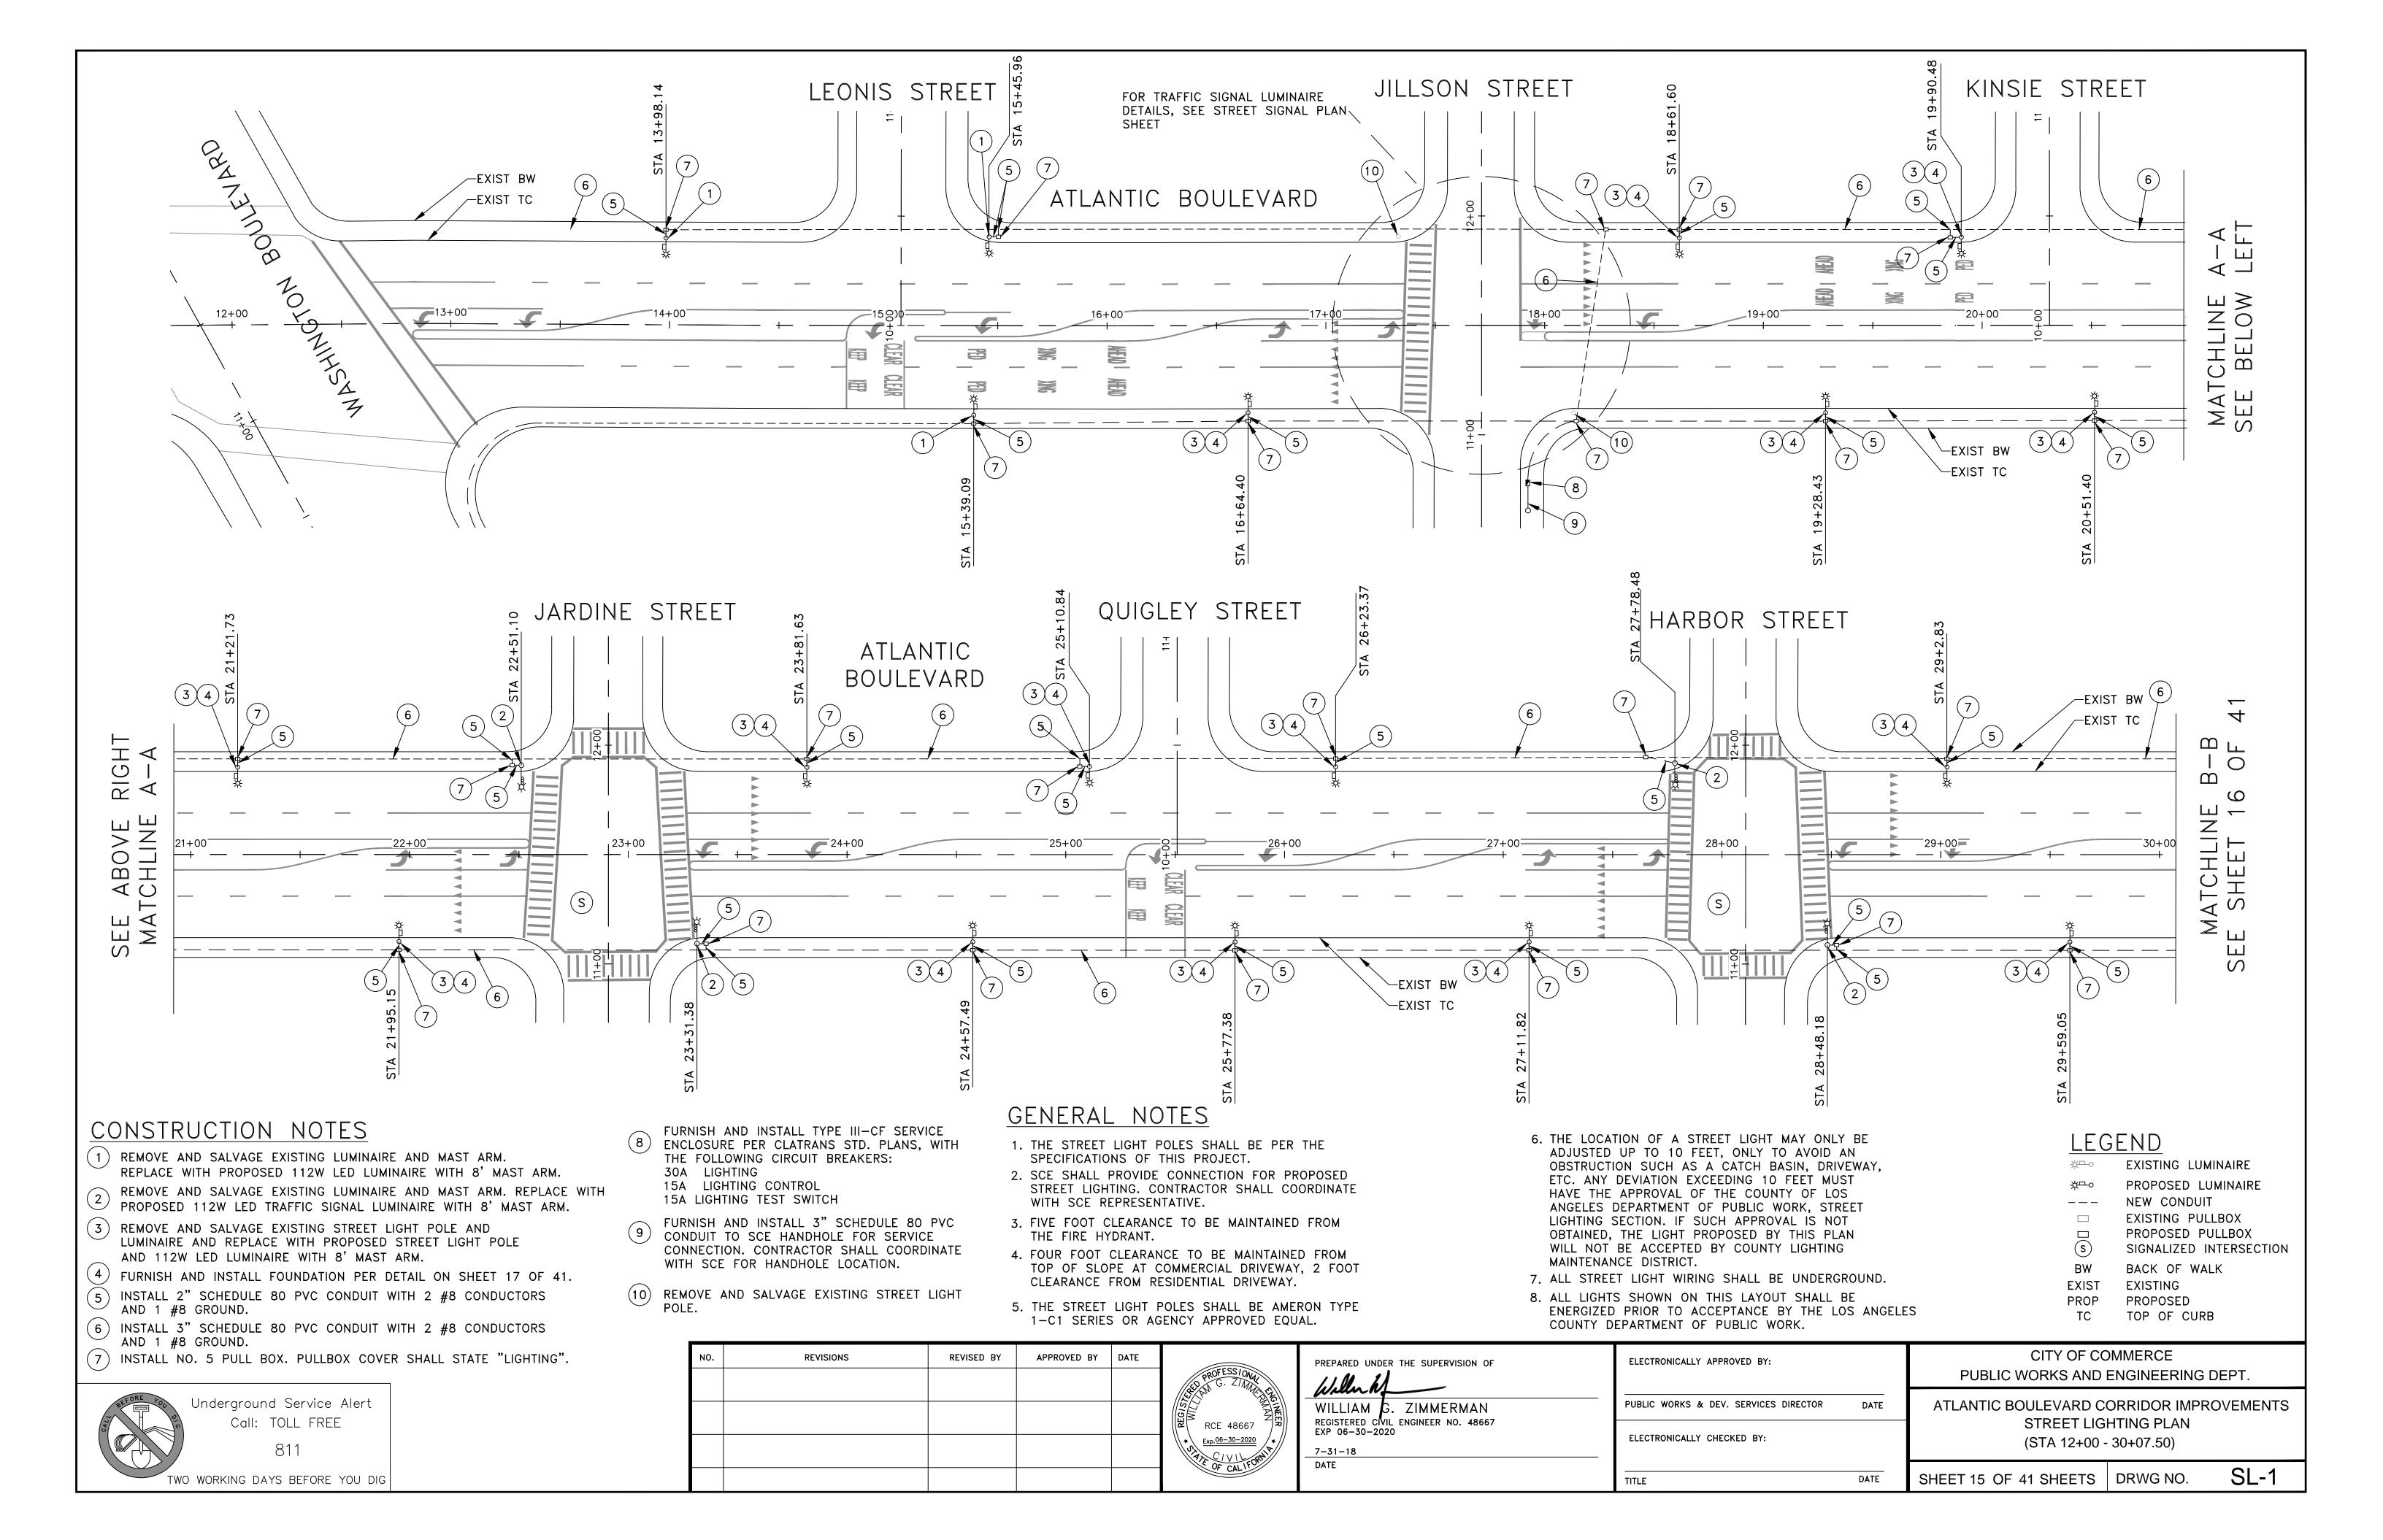

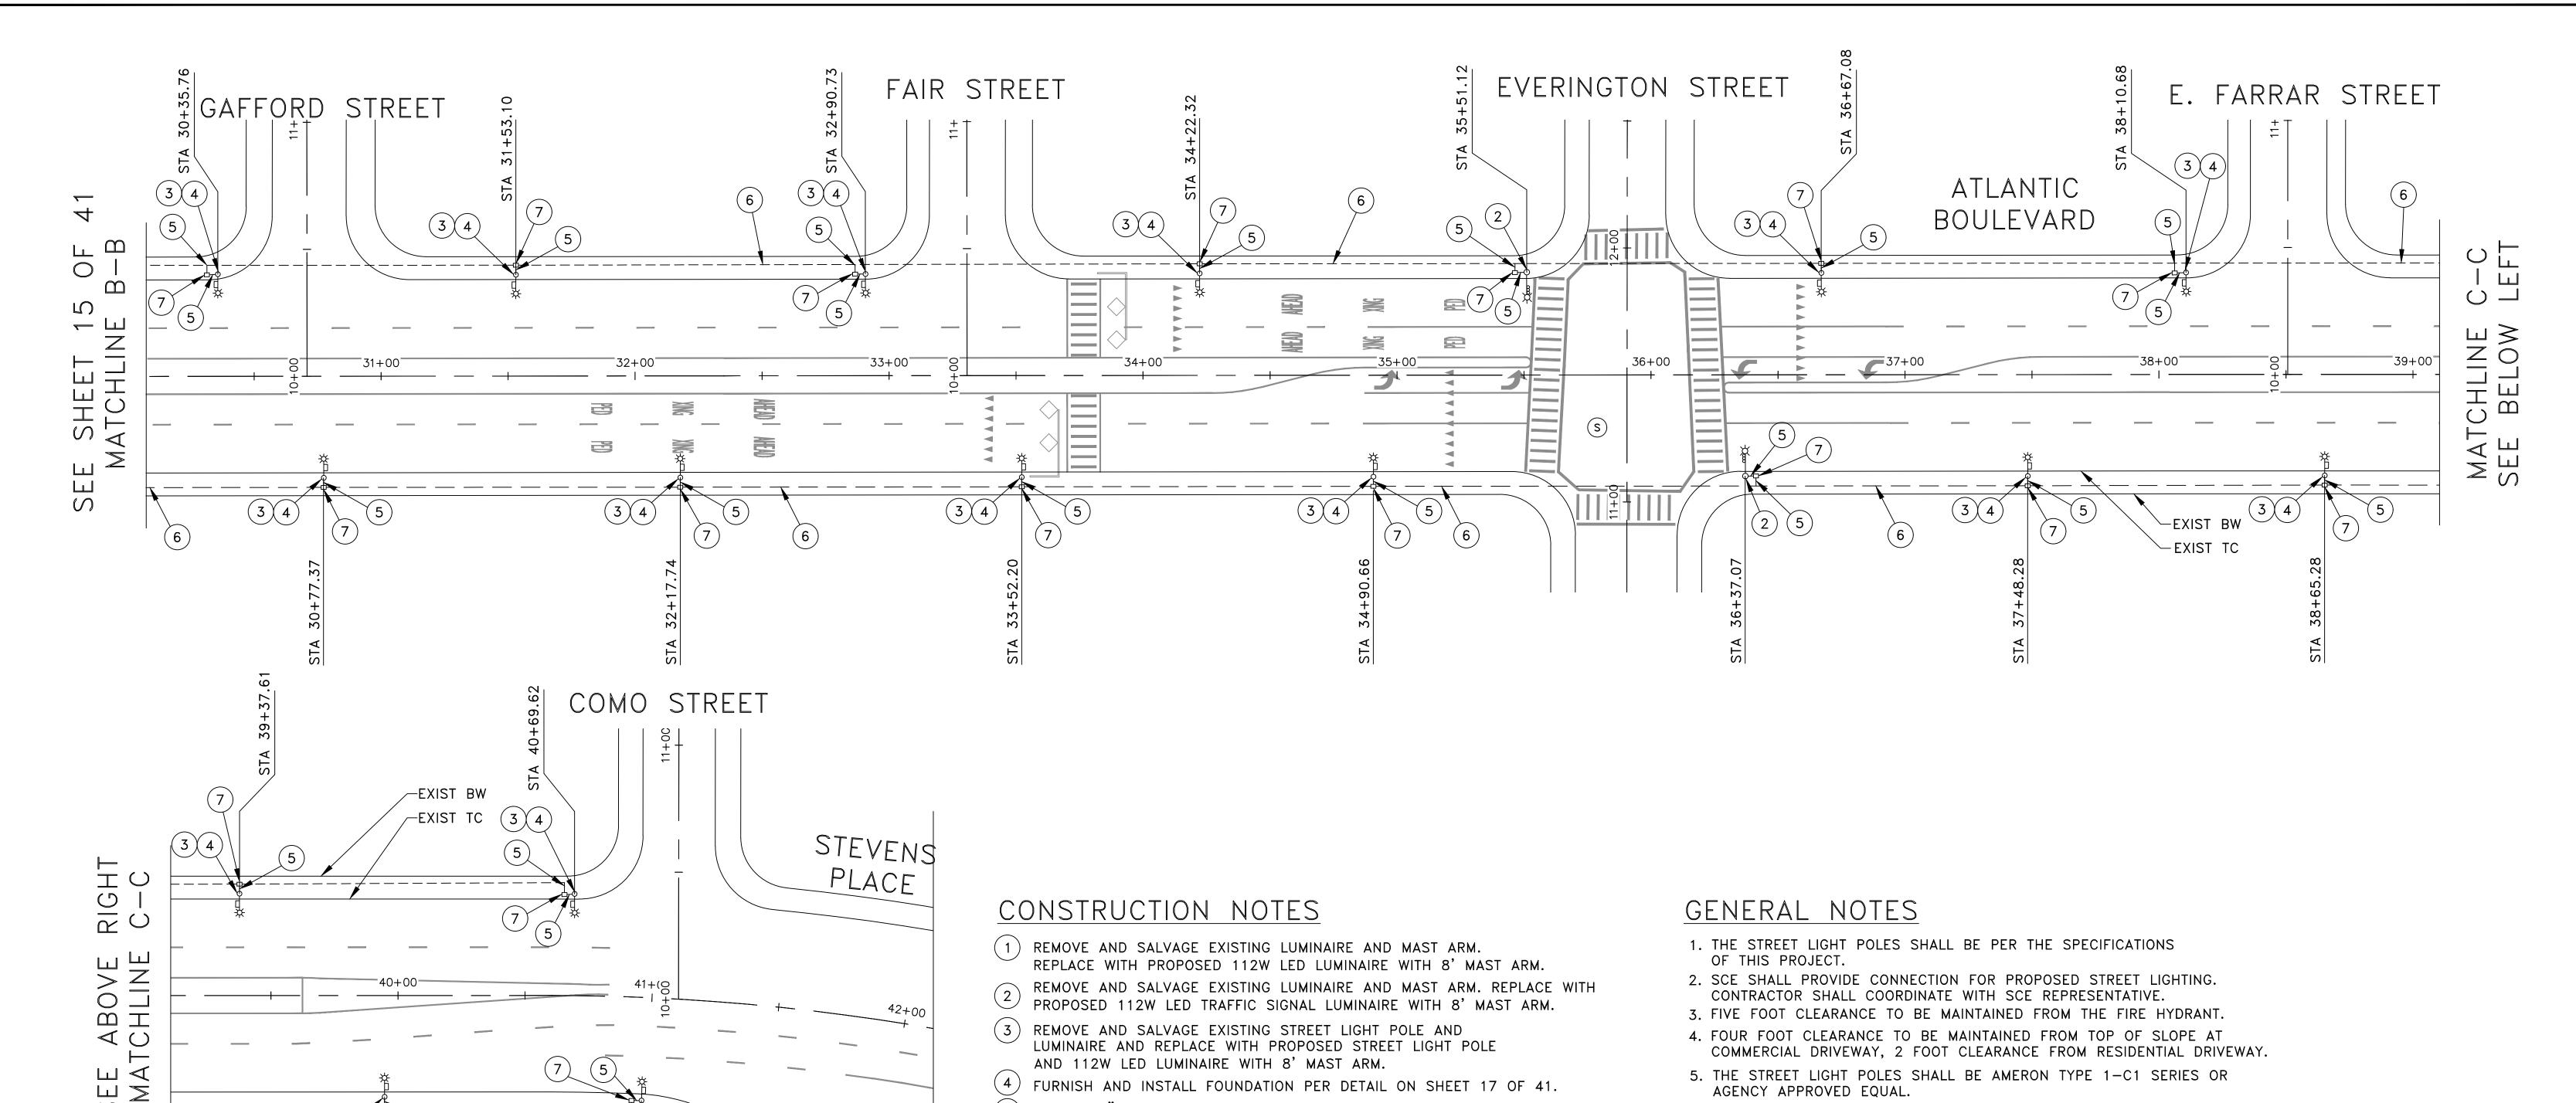

- INSTALL 2" SCHEDULE 80 PVC CONDUIT WITH 2 #8
- CONDUCTORS AND 1 #8 GROUND.
- INSTALL 3" SCHEDULE 80 PVC CONDUIT WITH 2 #8 CONDUCTORS AND 1 #8 GROUND.
- INSTALL NO. 5 PULL BOX. PULLBOX COVER SHALL STATE "LIGHTING".
- FURNISH AND INSTALL TYPE III-CF SERVICE ENCLOSURE PER CLATRANS STD. (8) PLANS, WITH THE FOLLOWING CIRCUIT BREAKERS: 30A LIGHTING
 - 15A LIGHTING CONTROL 15A LIGHTING TEST SWITCH
- FURNISH AND INSTALL 3" SCHEDULE 80 PVC CONDUIT TO SCE HANDHOLE (9) FOR SERVICE CONNECTION. CONTRACTOR SHALL COORDINATE WITH SCE FOR HANDHOLE LOCATION.
- (10) REMOVE AND SALVAGE EXISTING STREET LIGHT POLE.

- 6. THE LOCATION OF A STREET LIGHT MAY ONLY BE ADJUSTED UP TO 10 FEET, ONLY TO AVOID AN OBSTRUCTION SUCH AS A CATCH BASIN, DRIVEWAY, ETC. ANY DEVIATION EXCEEDING 10 FEET MUST HAVE THE APPROVAL OF THE COUNTY OF LOS ANGELES DEPARTMENT OF PUBLIC WORK, STREET LIGHTING SECTION. IF SUCH APPROVAL IS NOT OBTAINED, THE LIGHT PROPOSED BY THIS PLAN WILL NOT BE ACCEPTED BY COUNTY LIGHTING MAINTENANCE DISTRICT.
- 7. ALL STREET LIGHT WIRING SHALL BE UNDERGROUND.
- 8. ALL LIGHTS SHOWN ON THIS LAYOUT SHALL BE ENERGIZED PRIOR TO ACCEPTANCE BY THE LOS ANGELES COUNTY DEPARTMENT OF PUBLIC WORK.

LEGEND

EXISTING LUMINAIRE

PROPOSED LUMINAIRE **NEW CONDUIT**


EXISTING PULLBOX PROPOSED PULLBOX

SIGNALIZED INTERSECTION

BACK OF WALK EXISTING


PROPOSED

EXIST TOP OF CURB

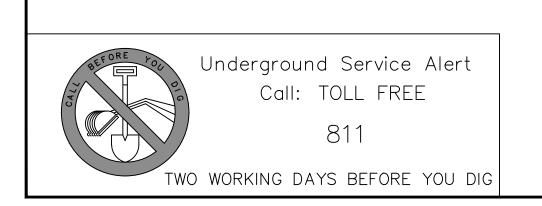


 \bigcirc

(3)(4)

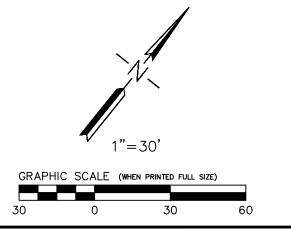

(3)(4)

NO.	REVISIONS	REVISED BY	APPROVED BY	DATE	
					`

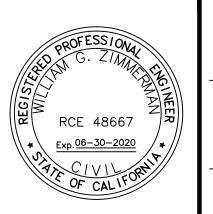

PREPARED UNDER THE SUPERVISION OF
WILLIAM G. ZIMMERMAN REGISTERED CIVIL ENGINEER NO. 48667 EXP 06-30-2020
7-31-18
DATE

ELECTRONICALLY APPROVED BY:	
PUBLIC WORKS & DEV. SERVICES DIRECTOR	DATE
ELECTRONICALLY CHECKED BY:	

TITLE

PUE	BLIC WOF	KKS AND	ENGINE	ERING L	DEPT.
ATLANT	TC BOULI	EVARD C			OVEMEN

CITY OF COMMERCE

(STA 30+07.50 - 42+00)

SL-2 SHEET 16 OF 41 SHEETS DRWG NO.

GENERAL NOTES

- 1. ALL WORK SHALL CONFORM TO APPLICABLE PROVISIONS OF THE CALIFORNIA BUILDING CODE - 2013 EDITION.
- 2. NO REVISION SHALL BE MADE WITHOUT PRIOR WRITTEN APPROVAL OF THE ENGINEER.
- 3. CONTRACTOR SHALL CHECK AND VERIFY ALL DIMENSIONS AND CONDITIONS ON THE JOB SITE AND REPORT ANY ERRORS, OMISSIONS, OR POSSIBLE DISCREPANCIES BETWEEN FIELD CONDITIONS AND DRAWINGS TO THE ENGINEER PRIOR TO PROCEEDING WITH THE WORK.

DESIGN CRITERIA

1. SOIL DESIGN CRITERIA:

COEFFICIENT OF FRICTION = N/A= 130 PSFPASSIVE PRESSURE

2. GOVERNING DESIGN CODES:

CALIFORNIA BUILDING CODE (2013 EDITION)

ASCE/SEI 7-05, "MINIMUM DESIGN LOADS FOR BUILDINGS AND OTHER STRUCTURES," AMERICAN SOCIETY OF CIVIL ENGINEERS.

ACI 318-05, BUILDING CODE REQUIREMENTS FOR STRUCTURAL CONCRETE, AMERICAN CONCRETE INSTITUTE

- 3. <u>WIND LOADS (W)</u> PER AASHTO STANDARD SPECIFICATIONS FOR STRUCTURAL SUPPORTS FOR HIGHWAY SIGNS, LUMINAIRES AND TRAFFIC SIGNALS (6th EDITION)
- 4. SEISMIC LOADS (E) PER AASHTO AND SDC 1.7-APRIL 2013 PEAK ROCK ACCELERATION = 0.558g

FOUNDATION

- 1. FOUNDATION EXCAVATIONS SHALL BE VISUALLY OBSERVED BY THE SOIL ENGINEER FOR COMPLIANCE WITH THE REQUIREMENTS OF THE SOILS REPORT PRIOR TO PLACEMENT OF REINFORCING STEEL OR CONCRETE. A CERTIFICATION FOR COMPACTION OF BACKFILL FROM THE GEOTECHNICAL ENGINEER SHALL BE PROVIDED TO THE BUILDING INSPECTOR PRIOR TO FINAL SIGN OFF AND ACCEPTANCE OF RETAINING WALL.
- 2. ALL FOOTINGS SHALL BE EMBEDDED 24" MINIMUM INTO COMPETENT UNDISTURBED NATURAL SOIL OR CERTIFIED COMPACTED FILL, UNLESS NOTED OTHERWISE IN SOILS REPORT.
- 3. SOILS BENEATH FOOTINGS SHALL BE PREMOISTENED AND COMPACTED TO MINIMUM REQUIREMENTS PRIOR TO PLACING CONCRETE.

REINFORCING STEEL

1. DIMENSIONS LOCATING REINFORCING BARS ARE CLEAR AND DENOTE CONCRETE COVERAGE TO MAIN STEEL. UNLESS NOTED OTHERWISE, COVERAGE SHALL BE AS FOLLOWS:

> CONCRETE PLACED AGAINST EARTH (NOT FORMED) FORMED CONCRETE AGAINST EARTH

WALLS, ABOVE GRADE, EXPOSED TO WEATHER


- 2. REINFORCING STEEL SHALL BE DEFORMED BARS, CONFORMING TO ASTM A615, LATEST REVISION AND SHALL BE GRADE 60.
- 3. REINFORCING IS TO BE SECURELY TIED IN PLACE PRIOR TO CASTING CONCRETE OR PLACING GROUT.
- 4. SUPPORT REINFORCING OFF FORMS WITH STEEL CHAIRS. SUPPORT REINFORCING OFF GRADE WITH DENSE CONCRETE BLOCKS. NO BRICK OR POROUS CONCRETE WILL BE PERMITTED TO SUPPORT REINFORCING.
- 5. VERTICAL REINFORCEMENT TO BE HELD IN PLACE AT TOP, BOTTOM AND INTERVALS NOT EXCEEDING 200 BAR DIAMETERS.

CONCRETE


1. CONCRETE SHALL HAVE A 28-DAY ULTIMATE COMPRESSIVE STRENGTH AS SHOWN FOR THE CORRESPONDING LOCATION LISTED IN THE SCHEDULE BELOW. DESIGN STRENGTH EQUAL TO 2500 PSI, THEREFORE SPECIAL INSPECTION NOT REQUIRED.


LOCATION	STRENGTH	DENSITY	MAX WATER/CEMENT	CEMENT
	(PSI)	(PCF)	RATIO	TYPE
ALL CONCRETE	2500	150	0.5	TYPE II

- 2. PORLAND CEMENT SHALL CONFORM TO ASTM C150.
- 3. AGGREGATE SHALL CONFORM TO ASTM C-33 FOR NORMAL WEIGHT CONCRETE.
- 4. READY MIX CONCRETE SHALL BE MISED AND DELIVERED IN ACCORDANCE WITH ASTM C-94.
- 5. ADMIXTURES SHALL NOT BE USED UNLESS APPROVED BY THE ENGINEER.
- 6. CONCRETE CONSTRUCTION SHALL BE IN ACCORDANCE WITH THE LATEST ACI CODE (ACI 318) AND DETAILING MANUAL (ACI 315) UNLESS OTHERWISE DETAILED OR NOTED ON DRAWINGS.

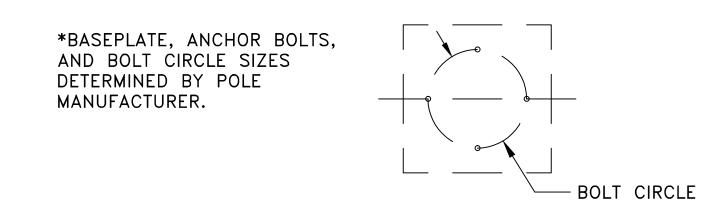

CONTRACTOR TO SUBMIT SHOP DRAWING INCLUDING POLE, BASE PLATE, ANCHOR BOLTS, EQUIPMENT BOX AND CONDUIT TO ENGINEER FOR REVIEW PRIOR TO ORDERING, FABRICATING OR CONSTRUCTING FOOTING SHOWN HEREON.

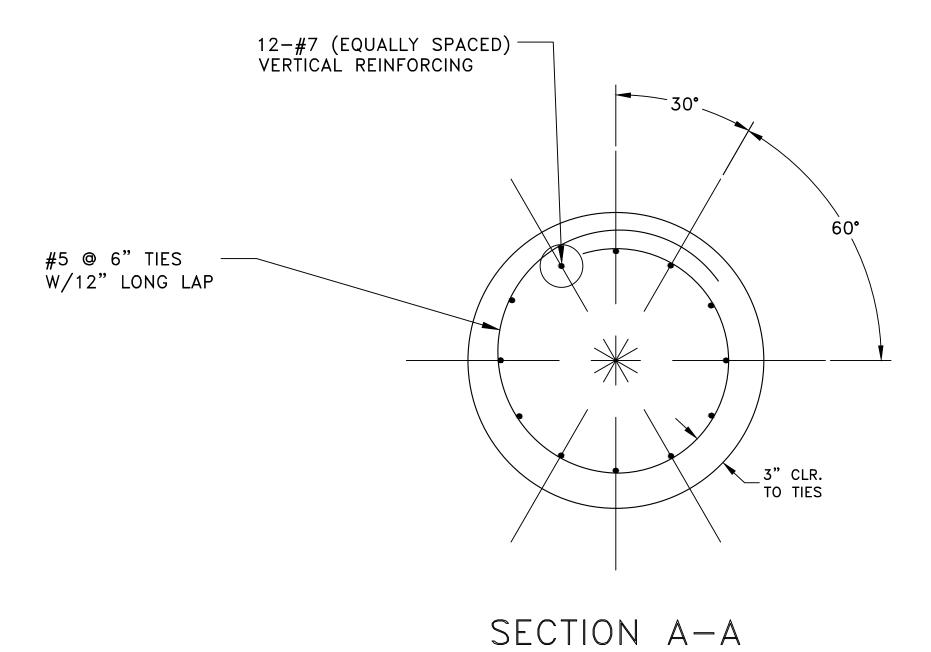


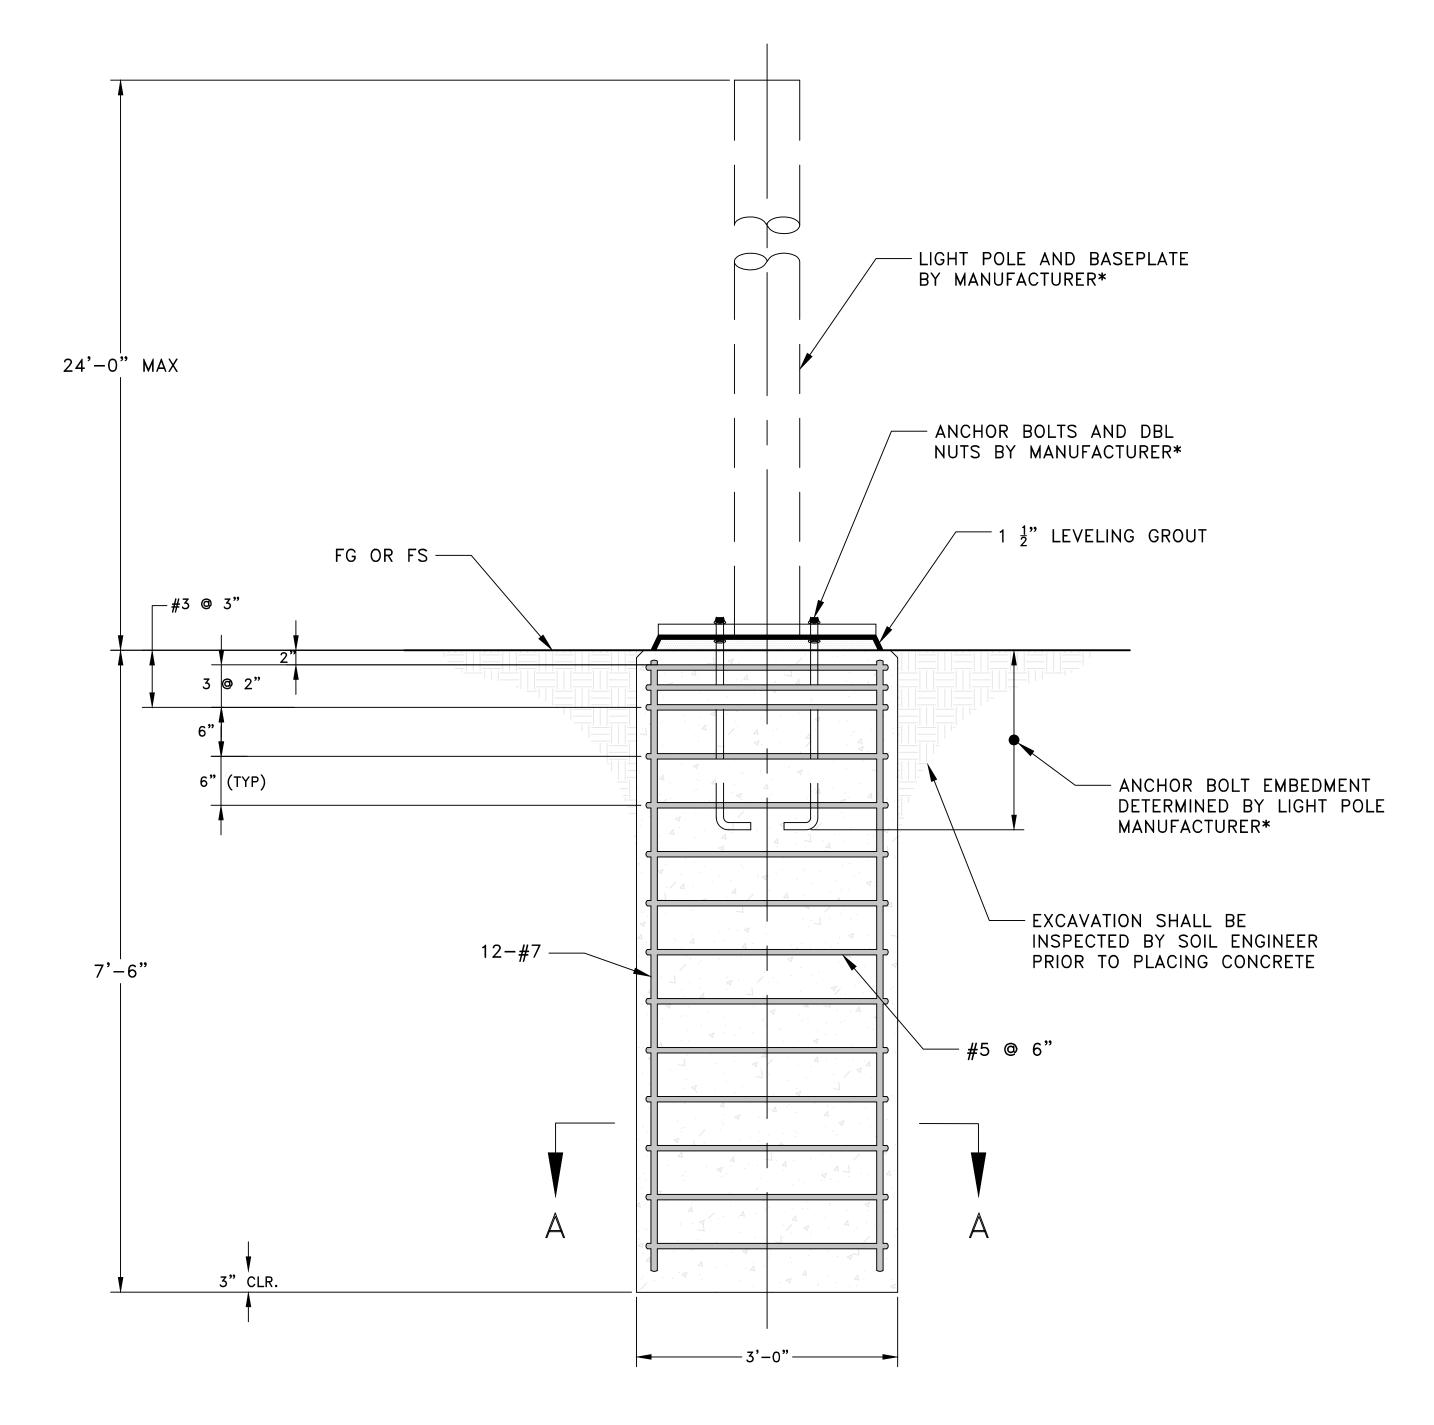



LIGHT POLE FOOTING


NOT TO SCALE


NO.	REVISIONS	REVISED BY	APPROVED BY	DATE	PROFESSIONAL G. ZIMMA CL	PREPARED UNDER THE SUPERVISION OF	ELECTRONICALLY APPROVED BY:		CITY OF COMMERCE PUBLIC WORKS AND ENGINEERING DEPT.
					RCE 48667 *** *** *** ** ** ** ** **	WILLIAM G. ZIMMERMAN REGISTERED CIVIL ENGINEER NO. 48667 EXP 06-30-2020 07-31-2018	PUBLIC WORKS & DEV. SERVICES DIRECTOR ELECTRONICALLY CHECKED BY:	DATE	ATLANTIC BOULEVARD CORRIDOR IMPROVEMENTS STREET LIGHTING PLAN FOUNDATION DETAIL
					OF CALIFORNIA	DATE	TITLE	DATE	SHEET 17 OF 41 SHEETS DRWG NO. SL-3

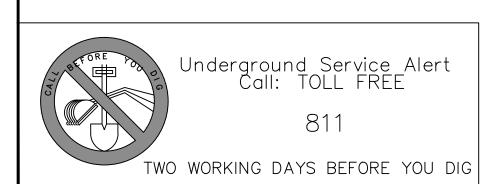


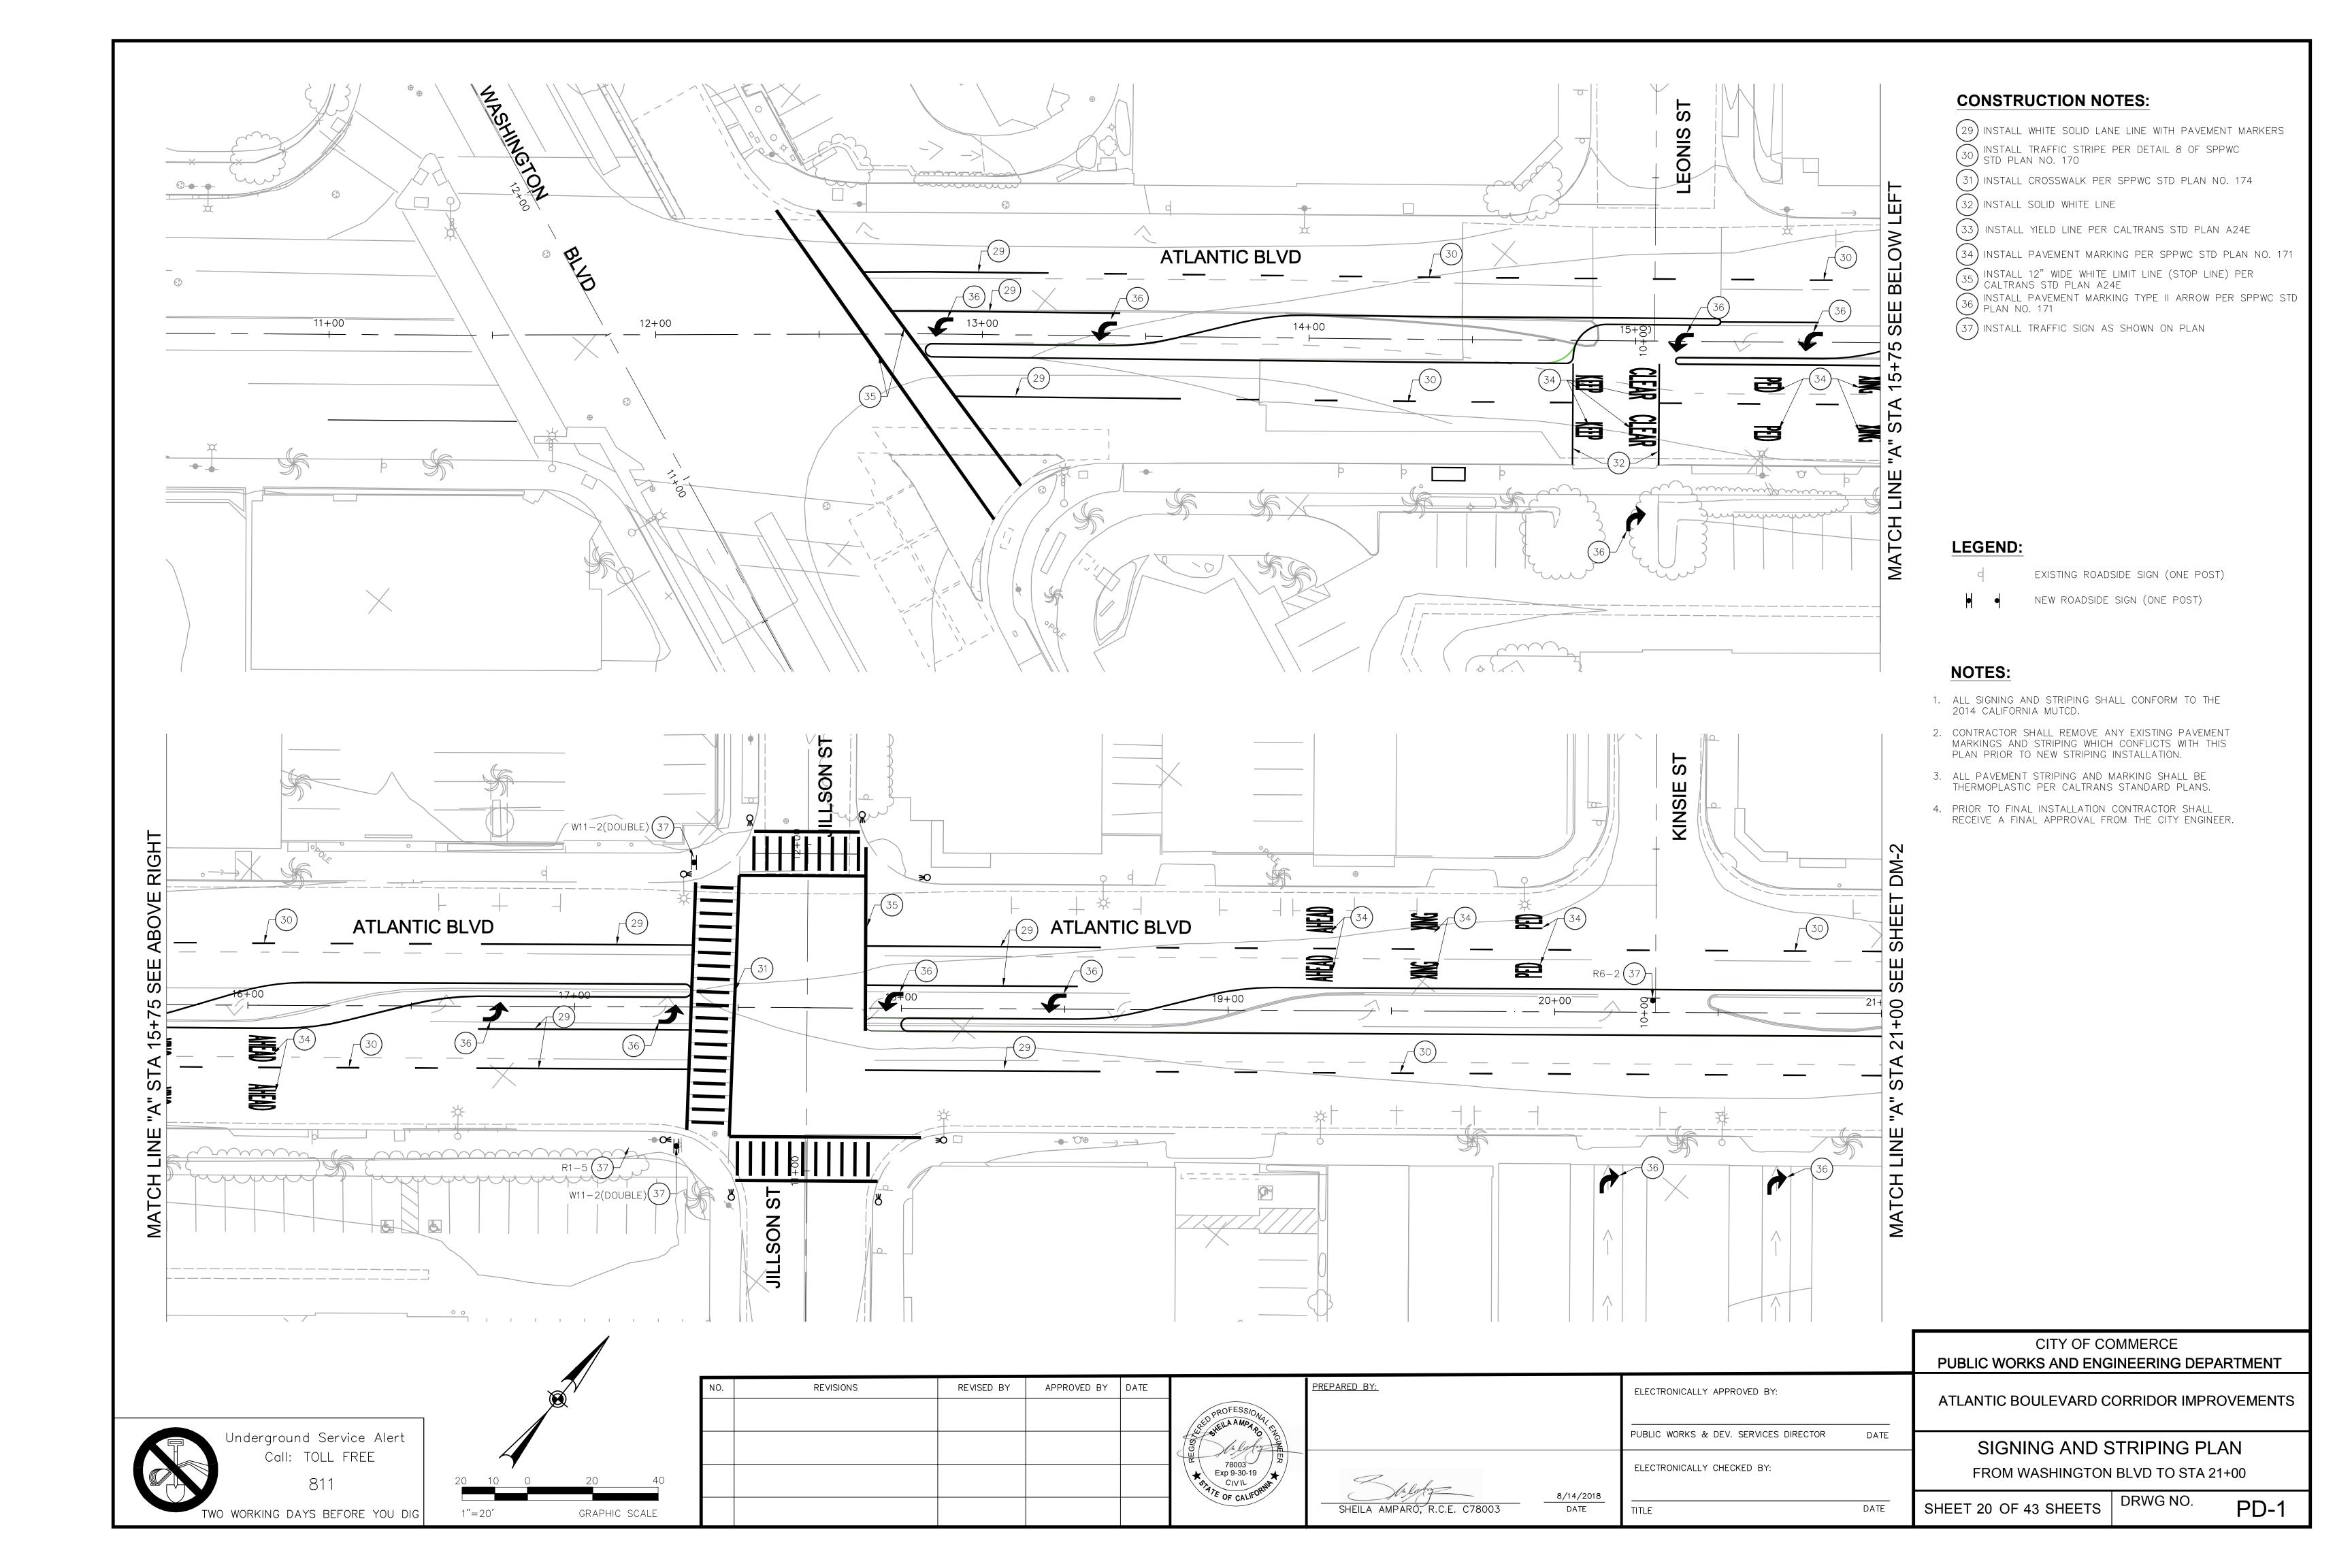


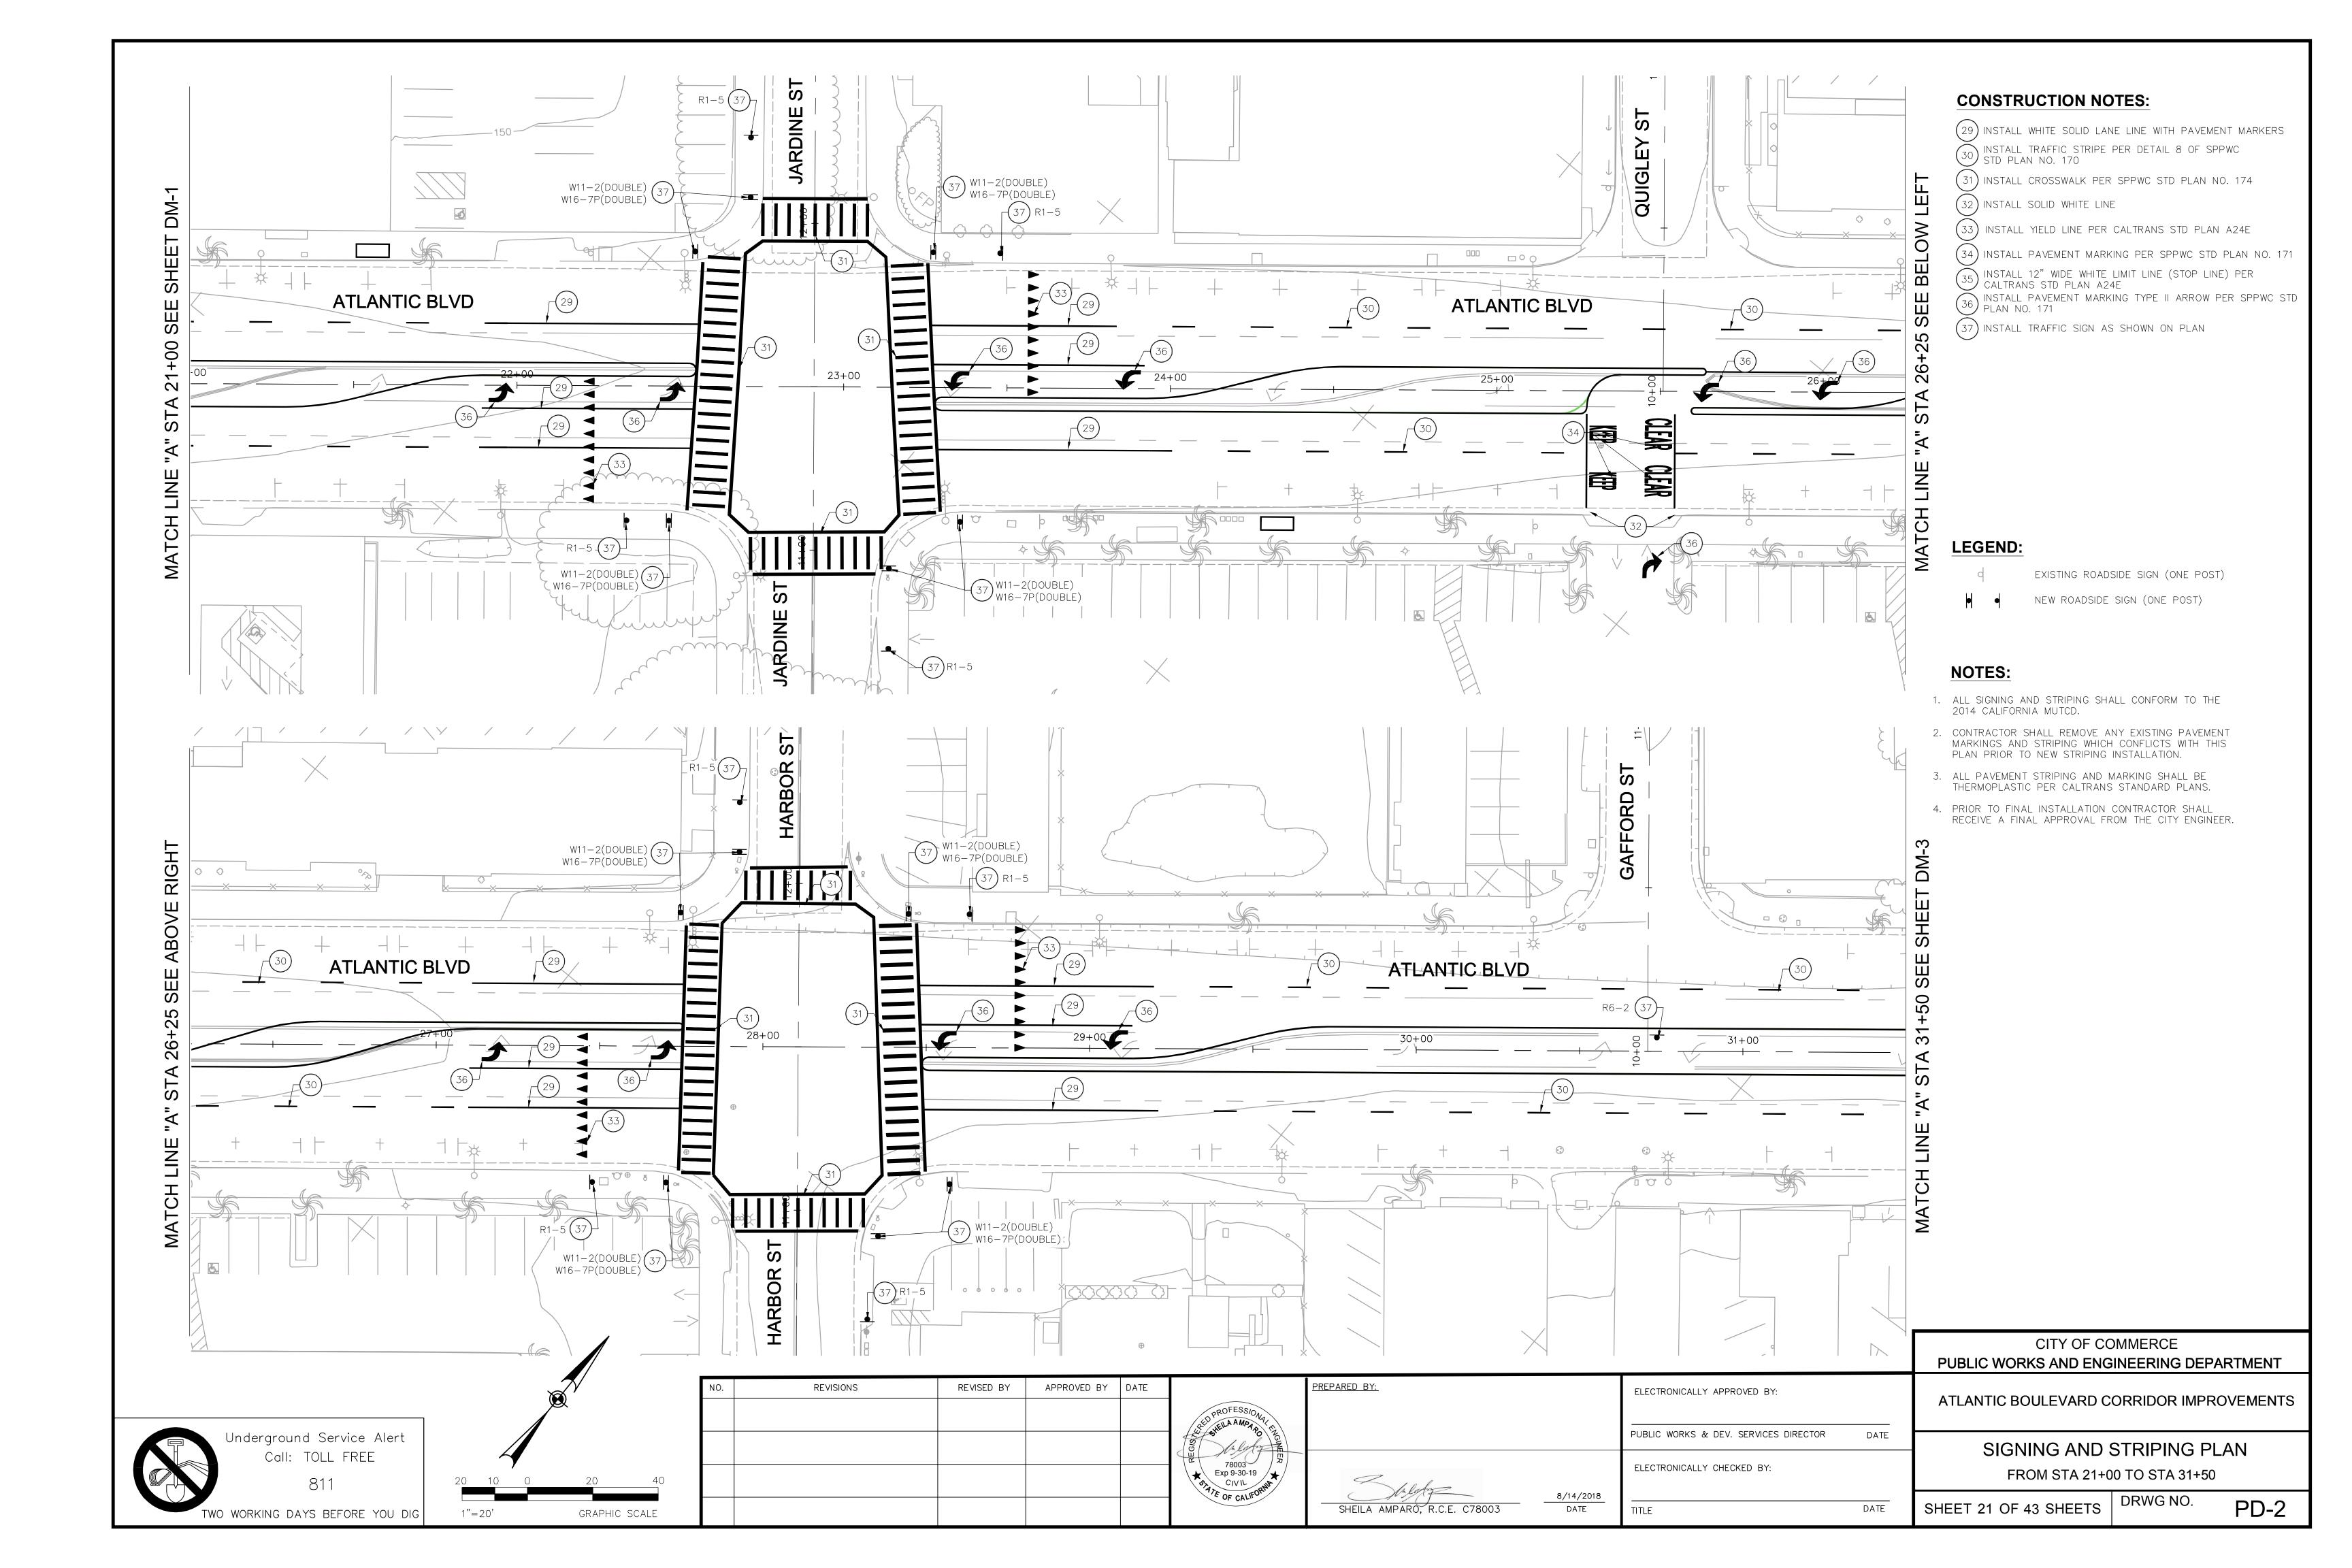


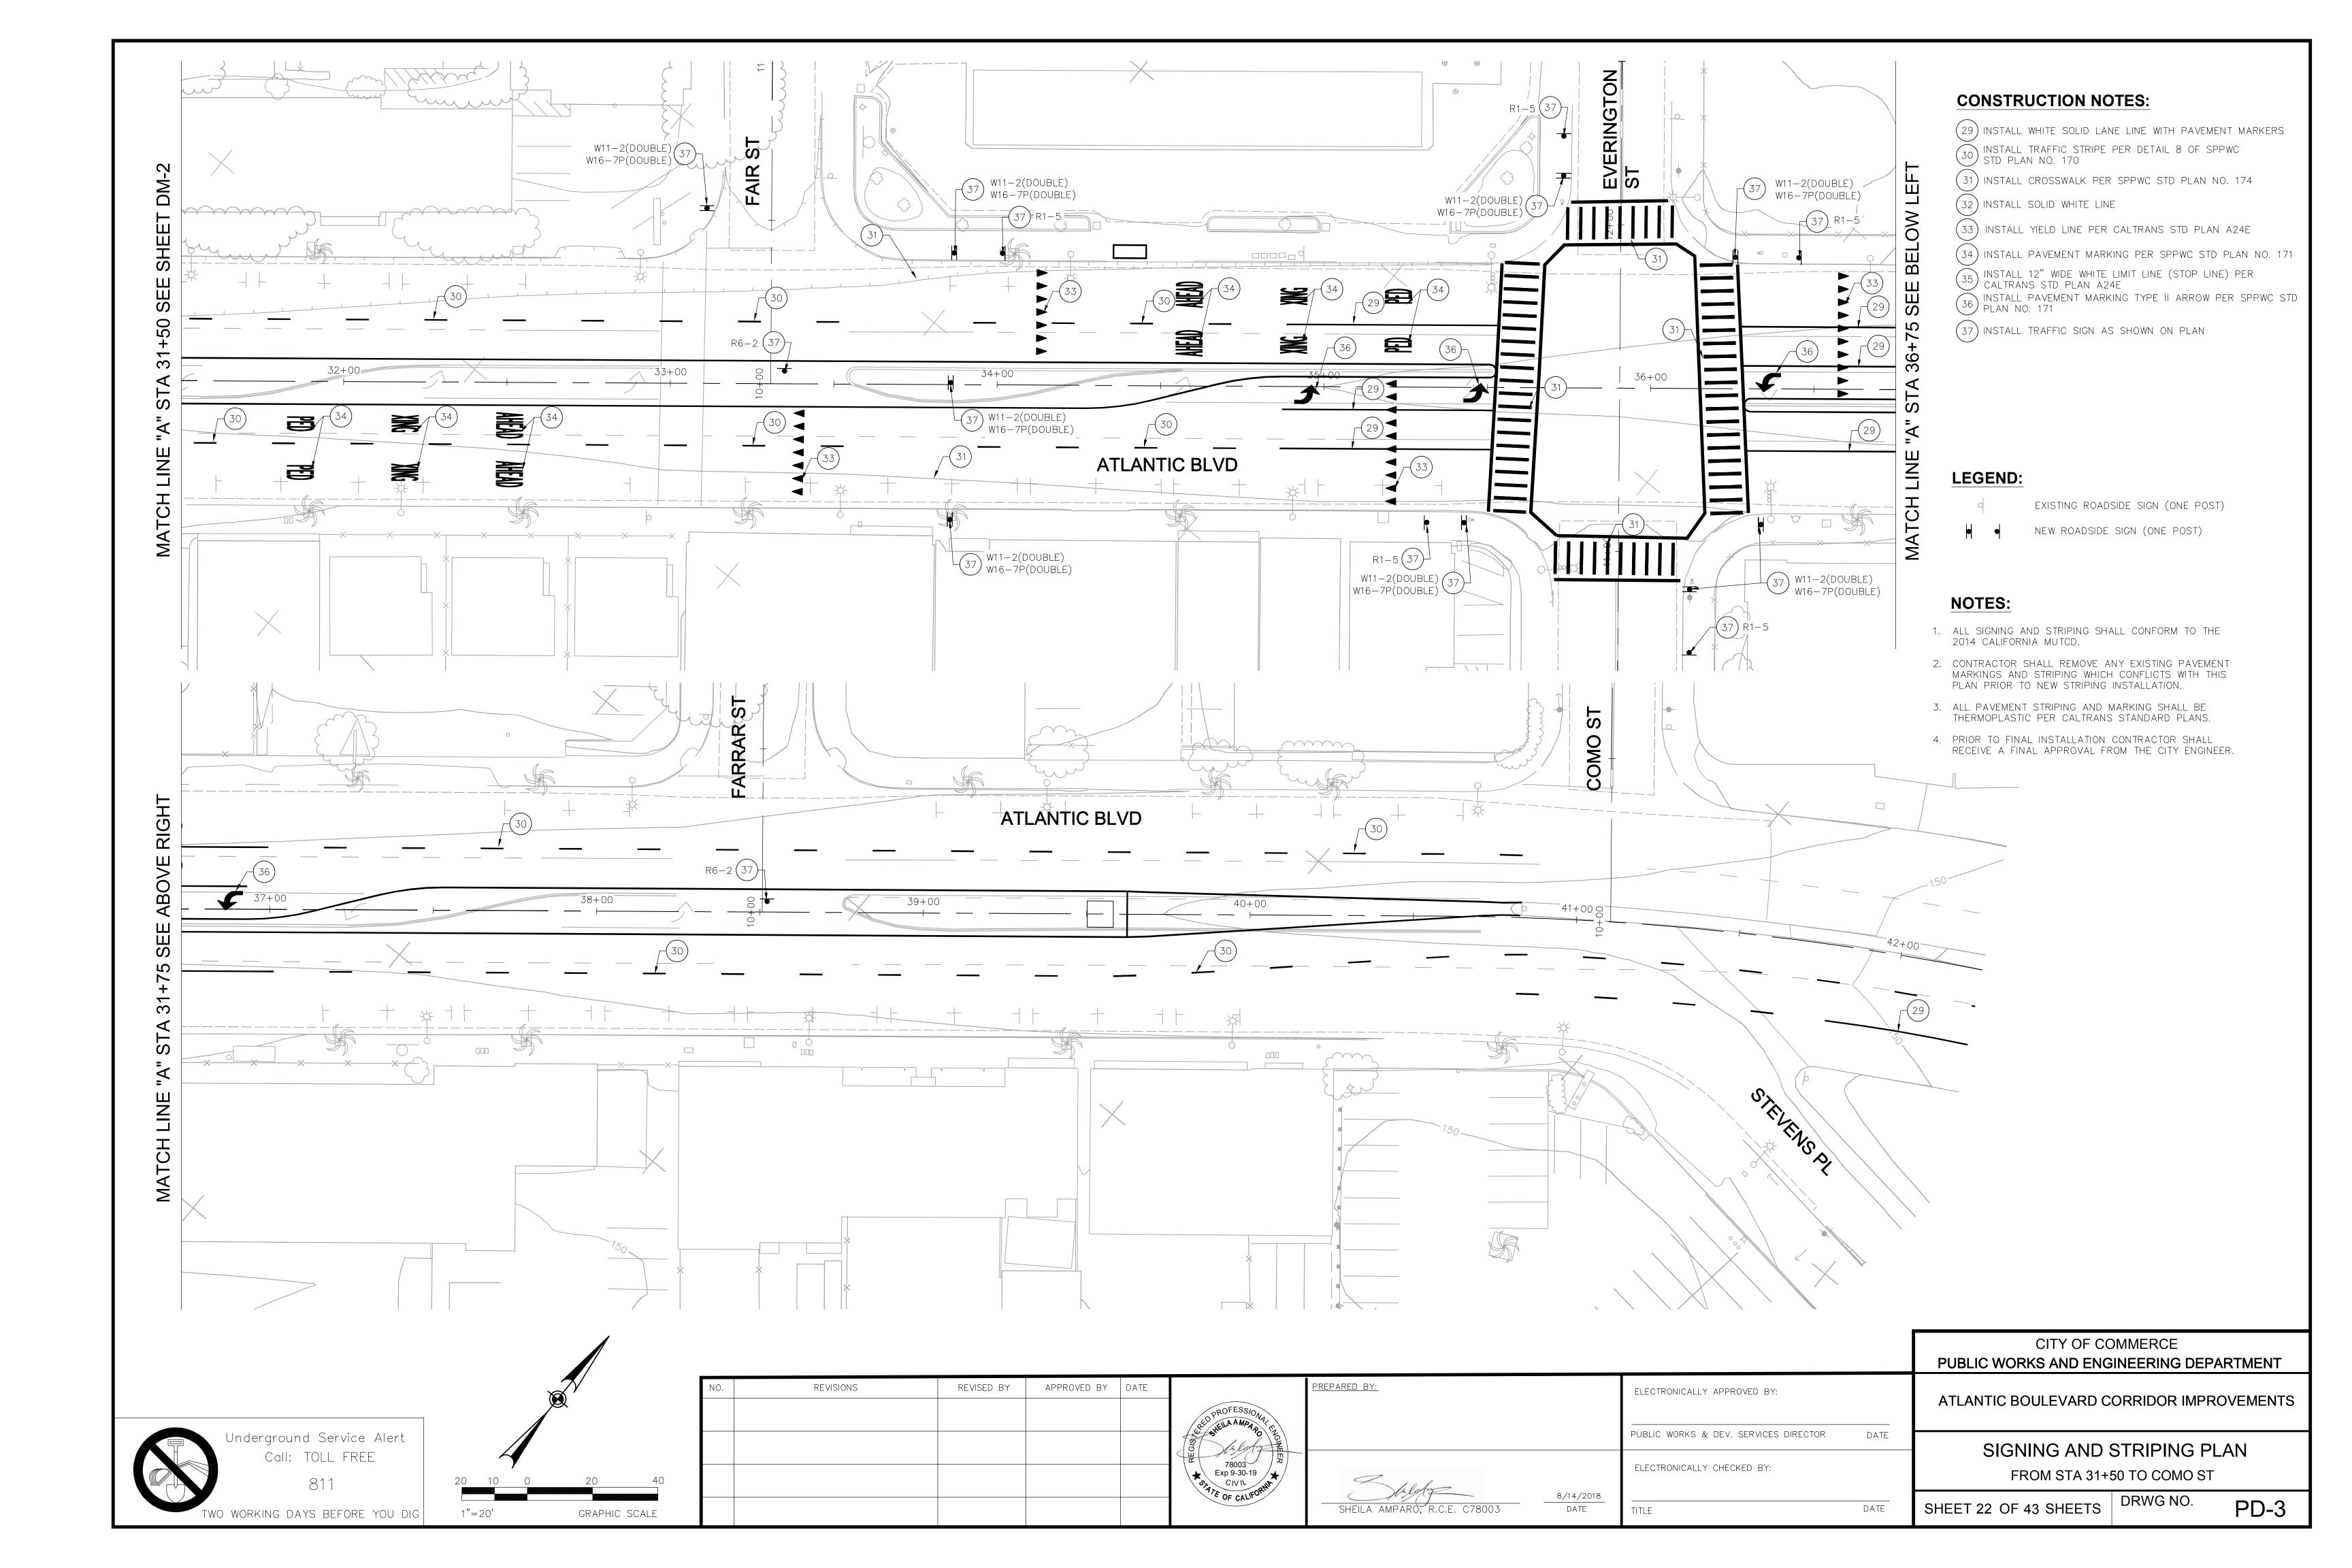


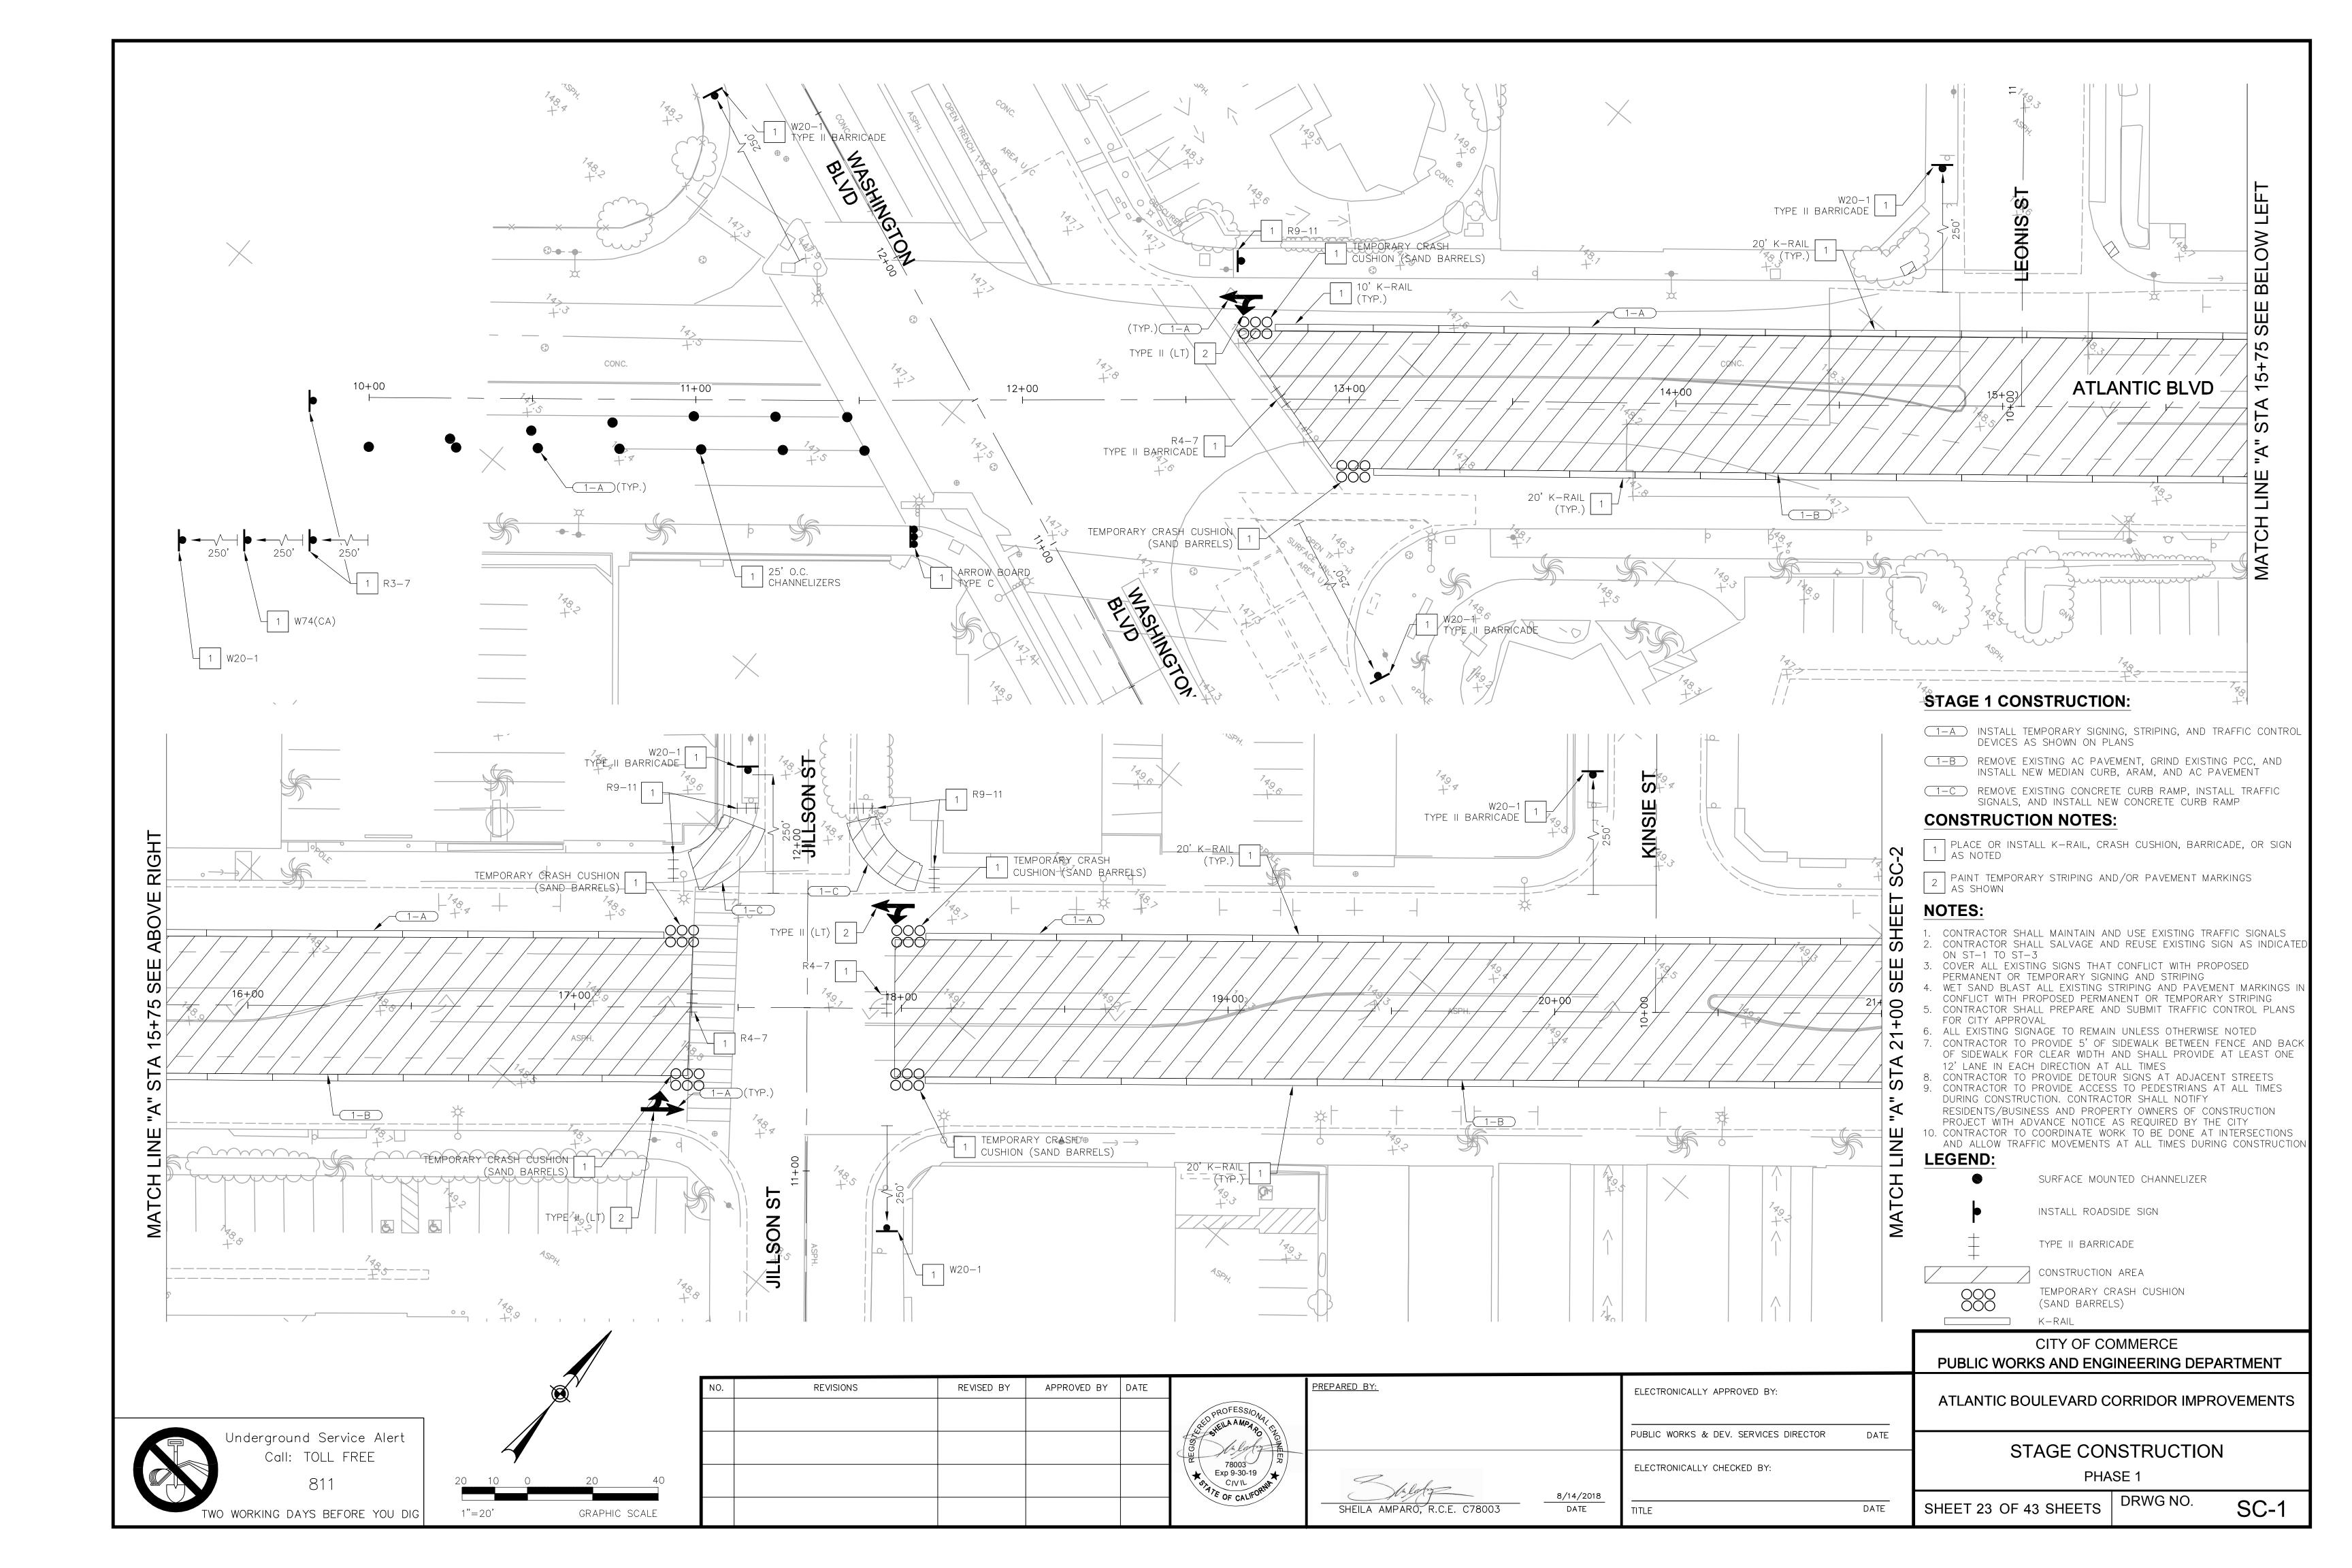


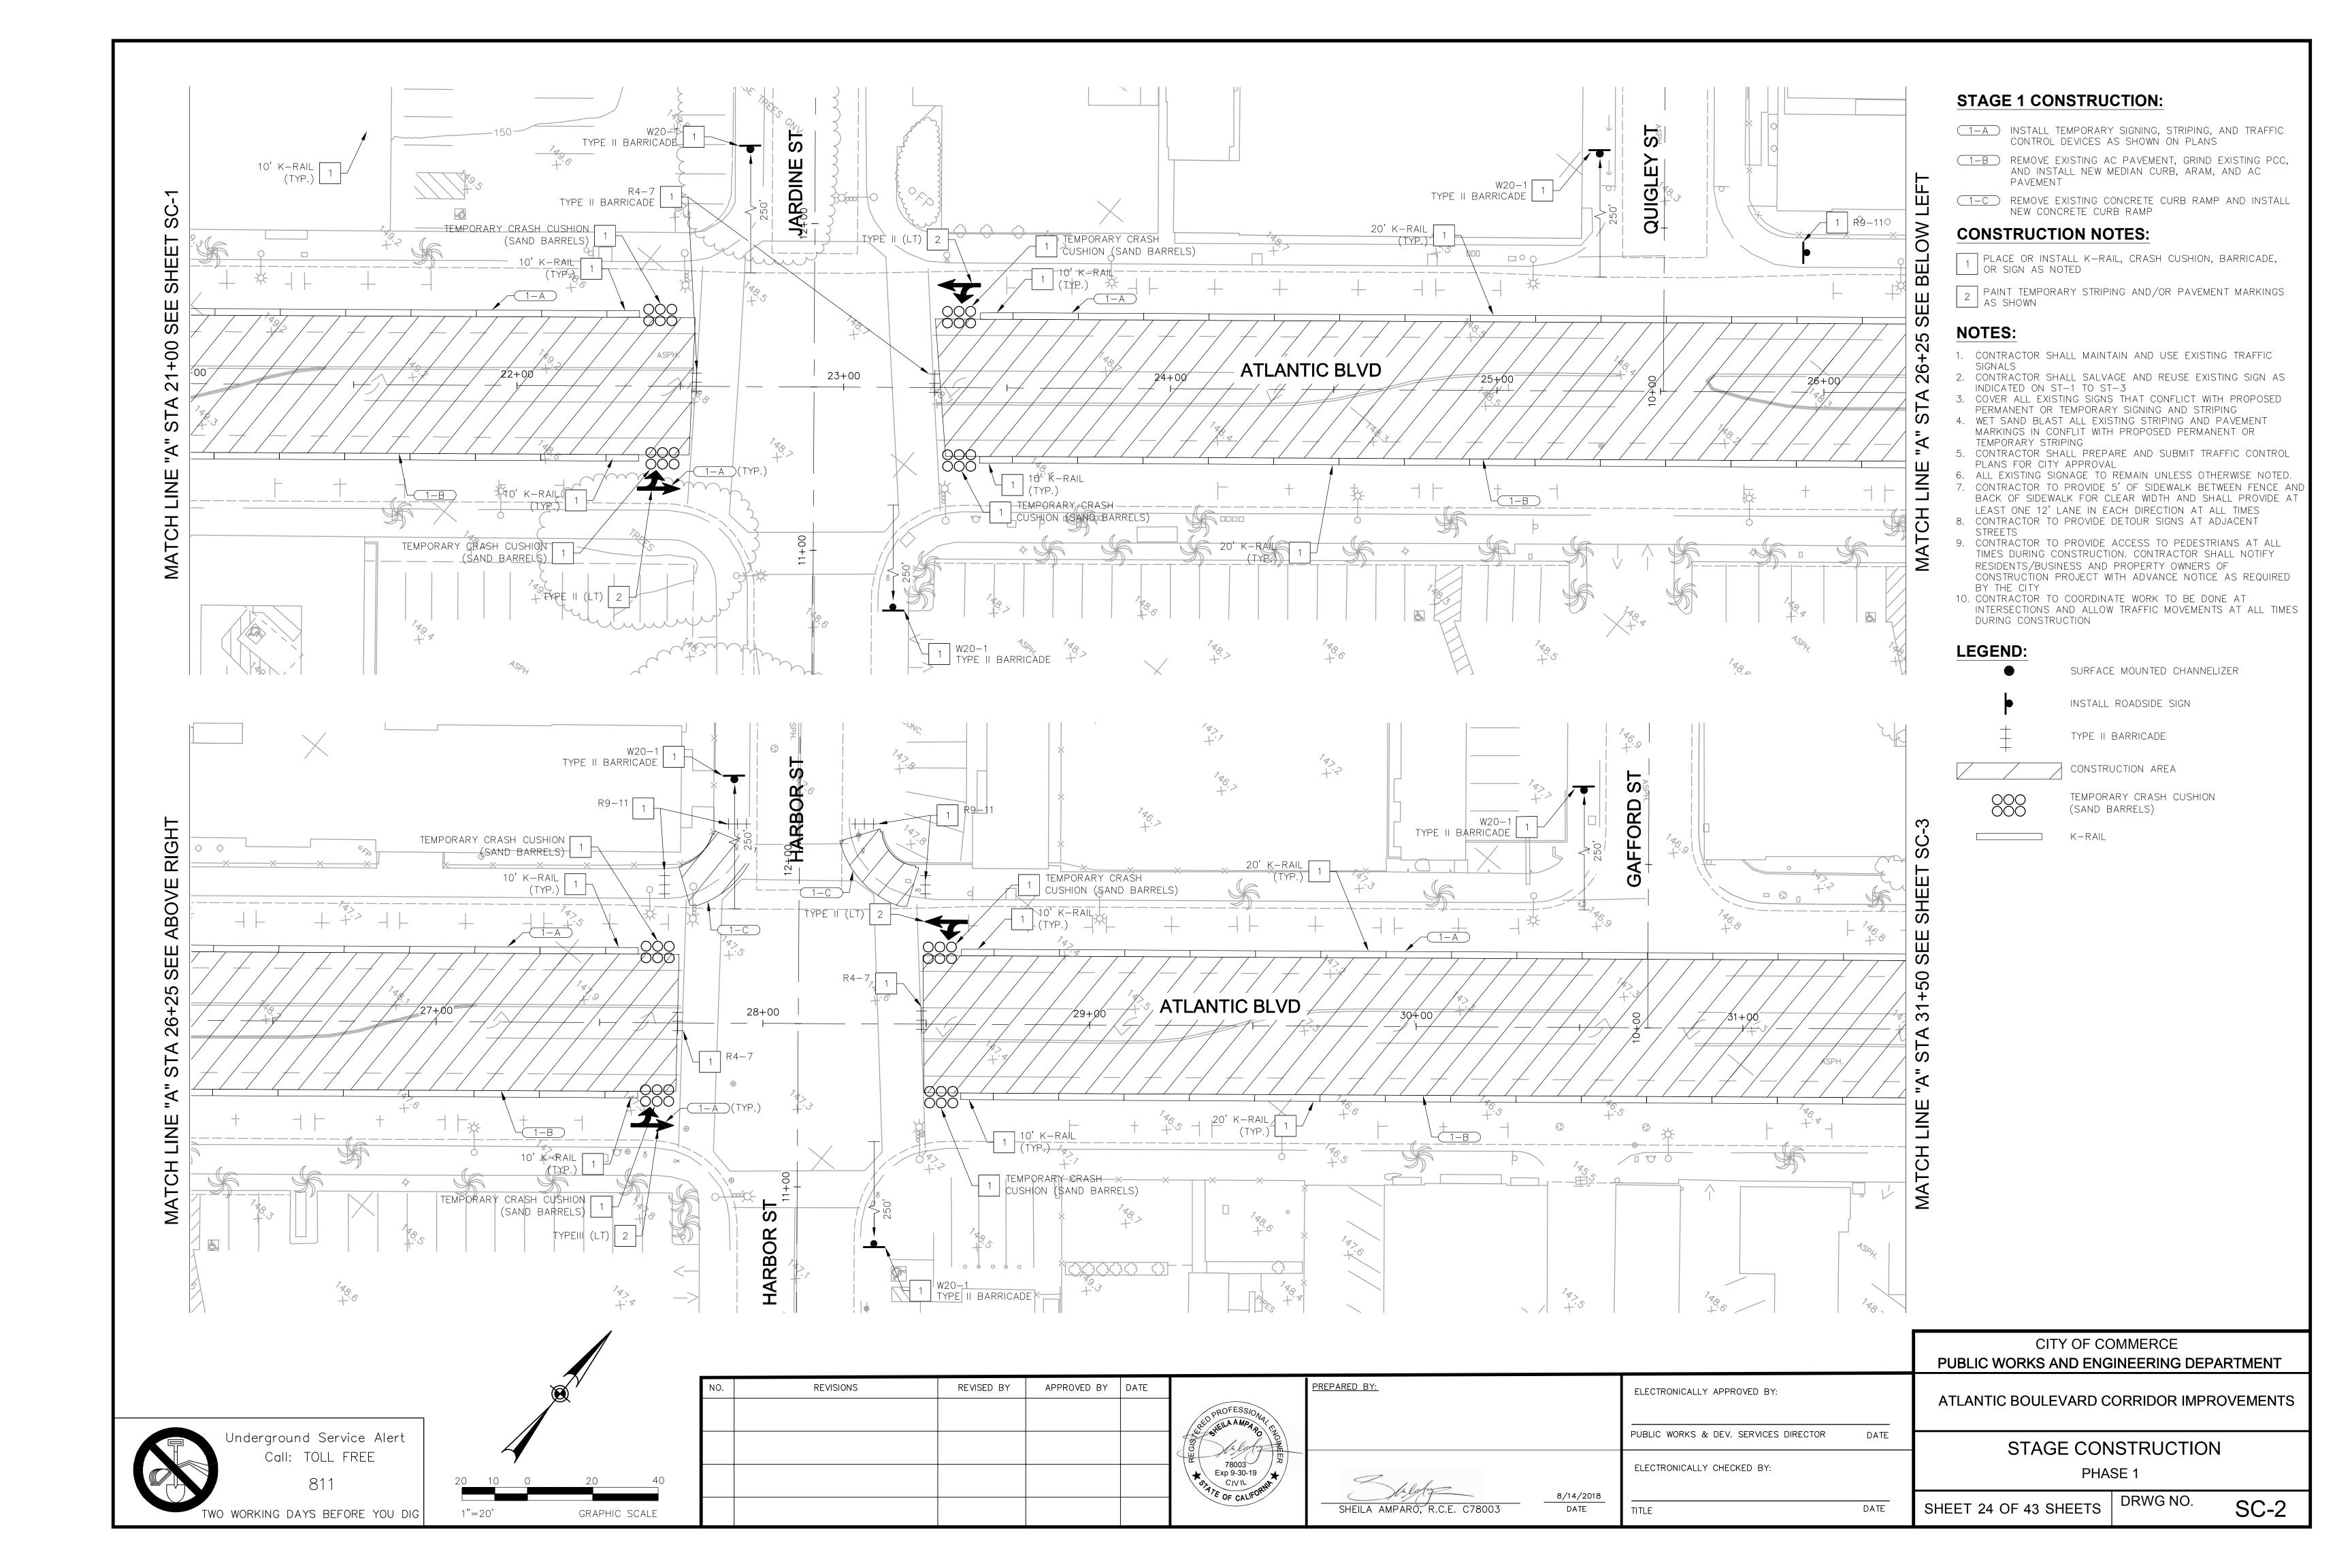


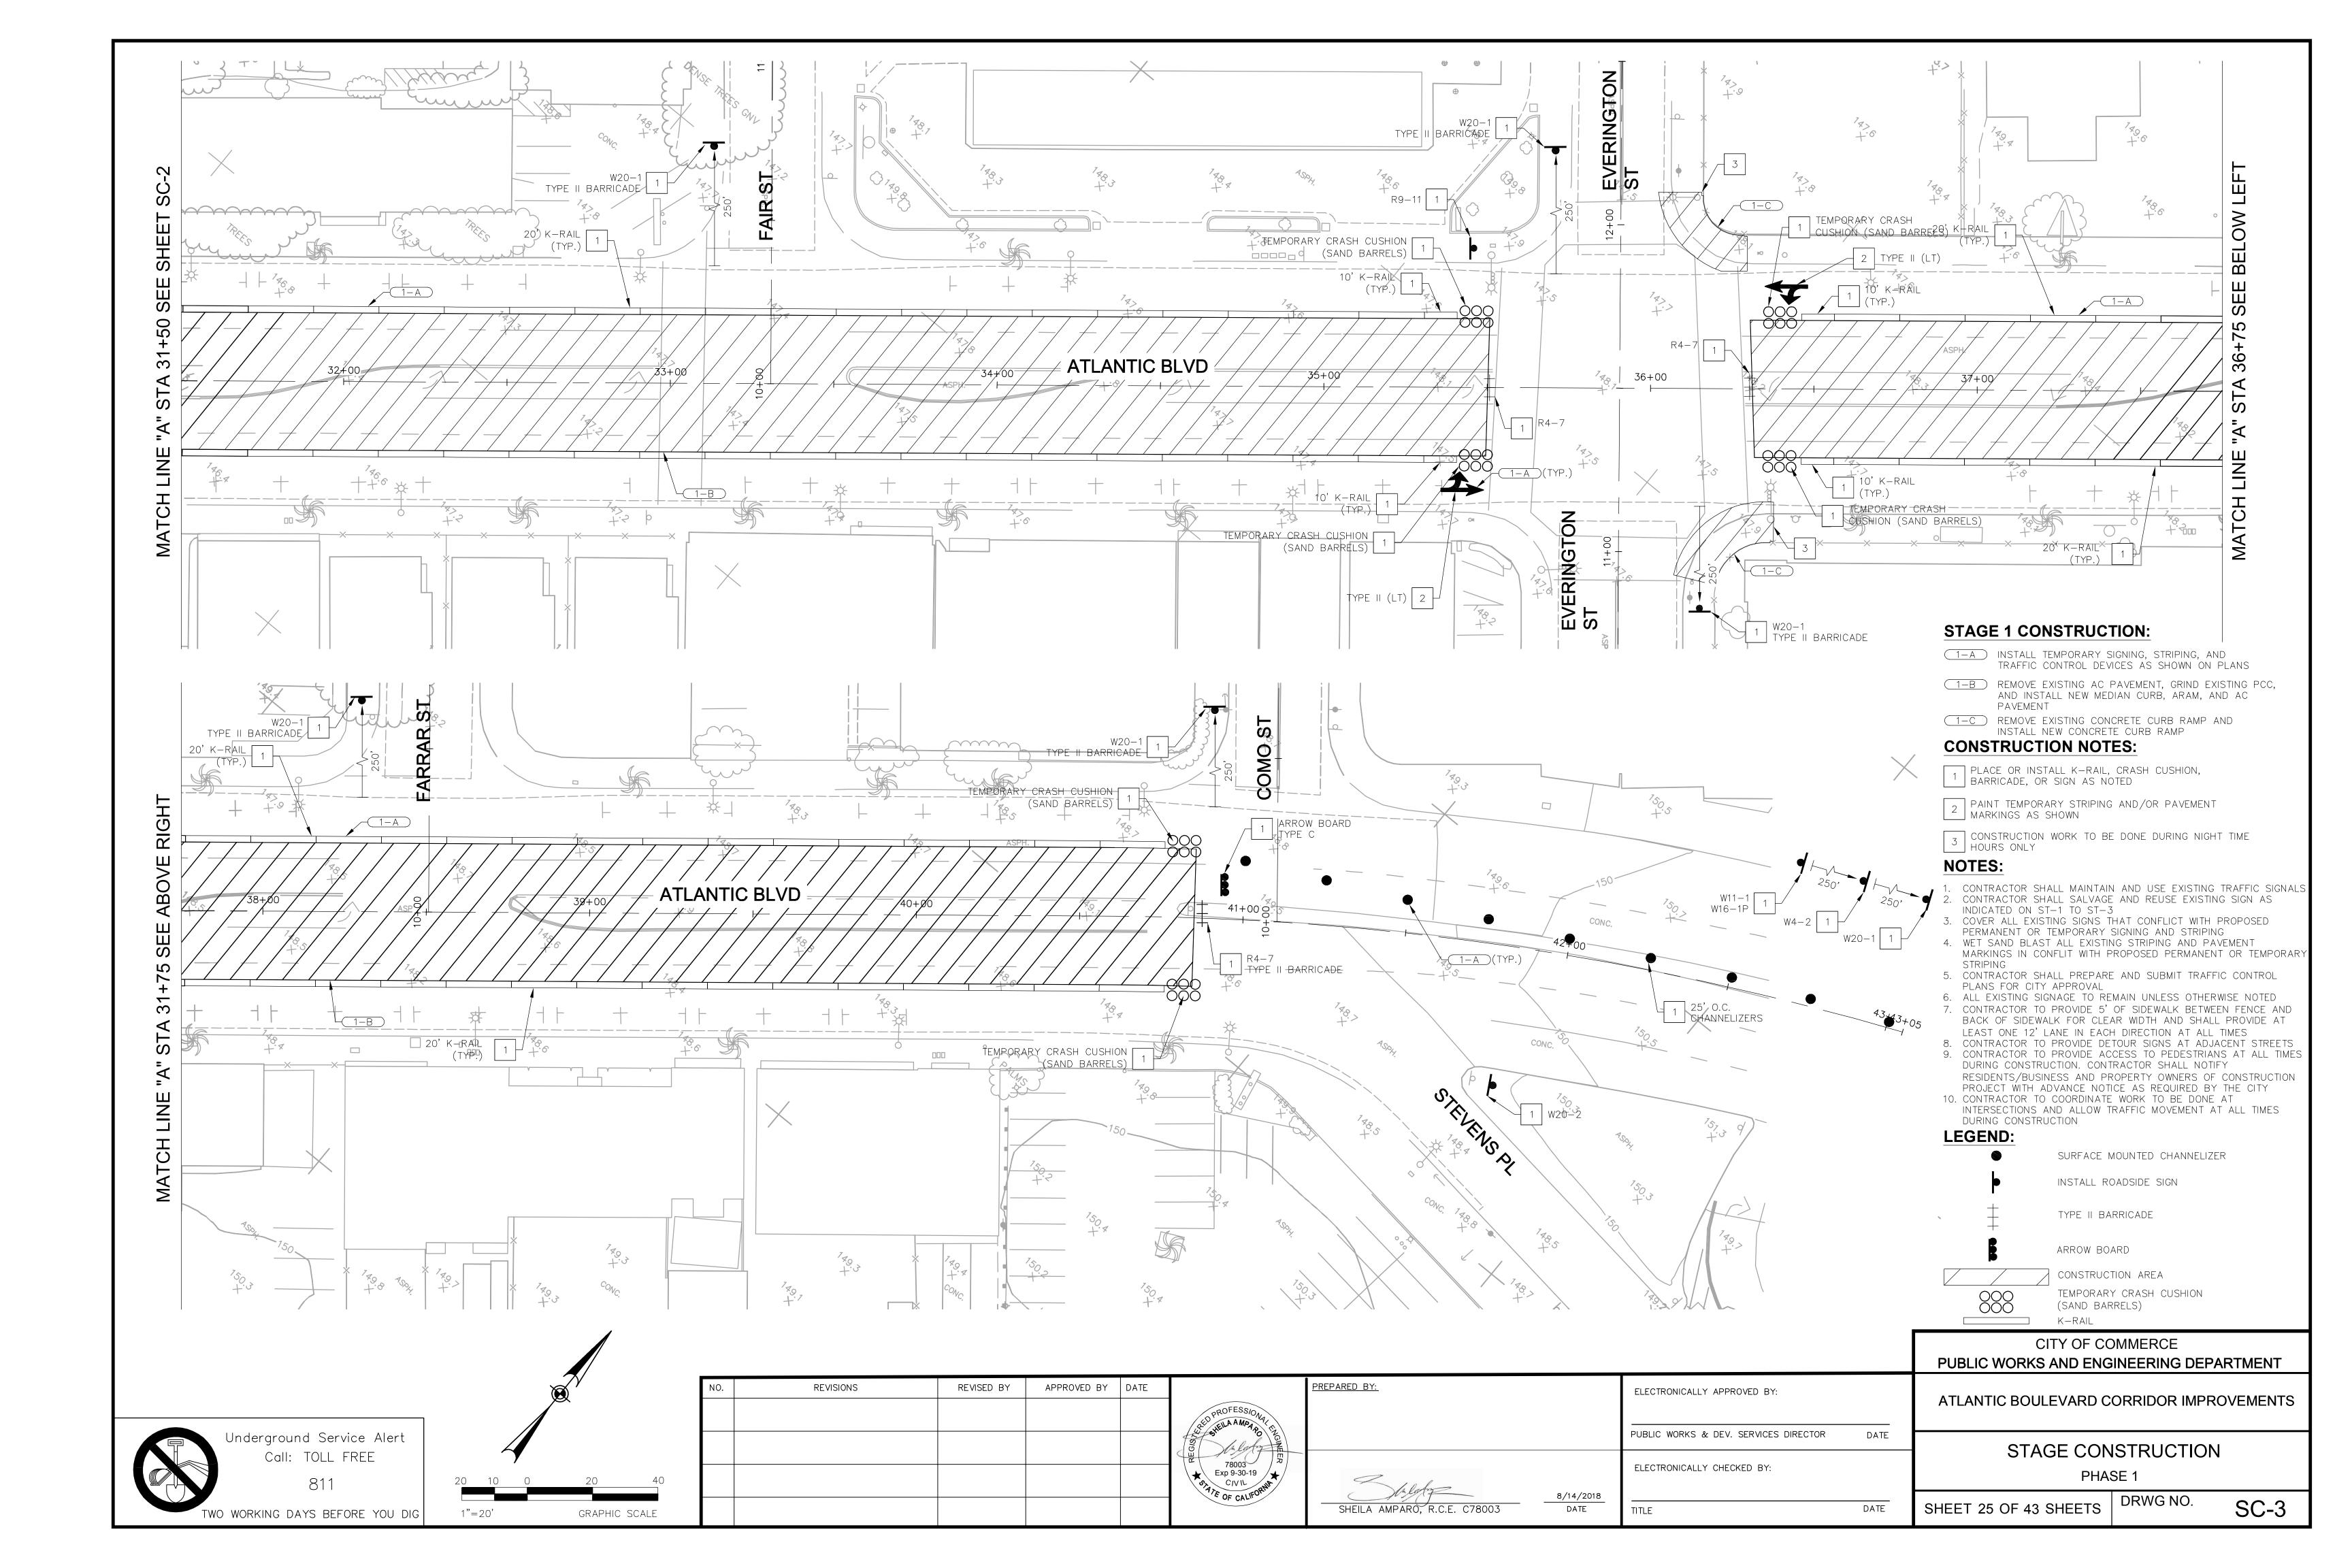


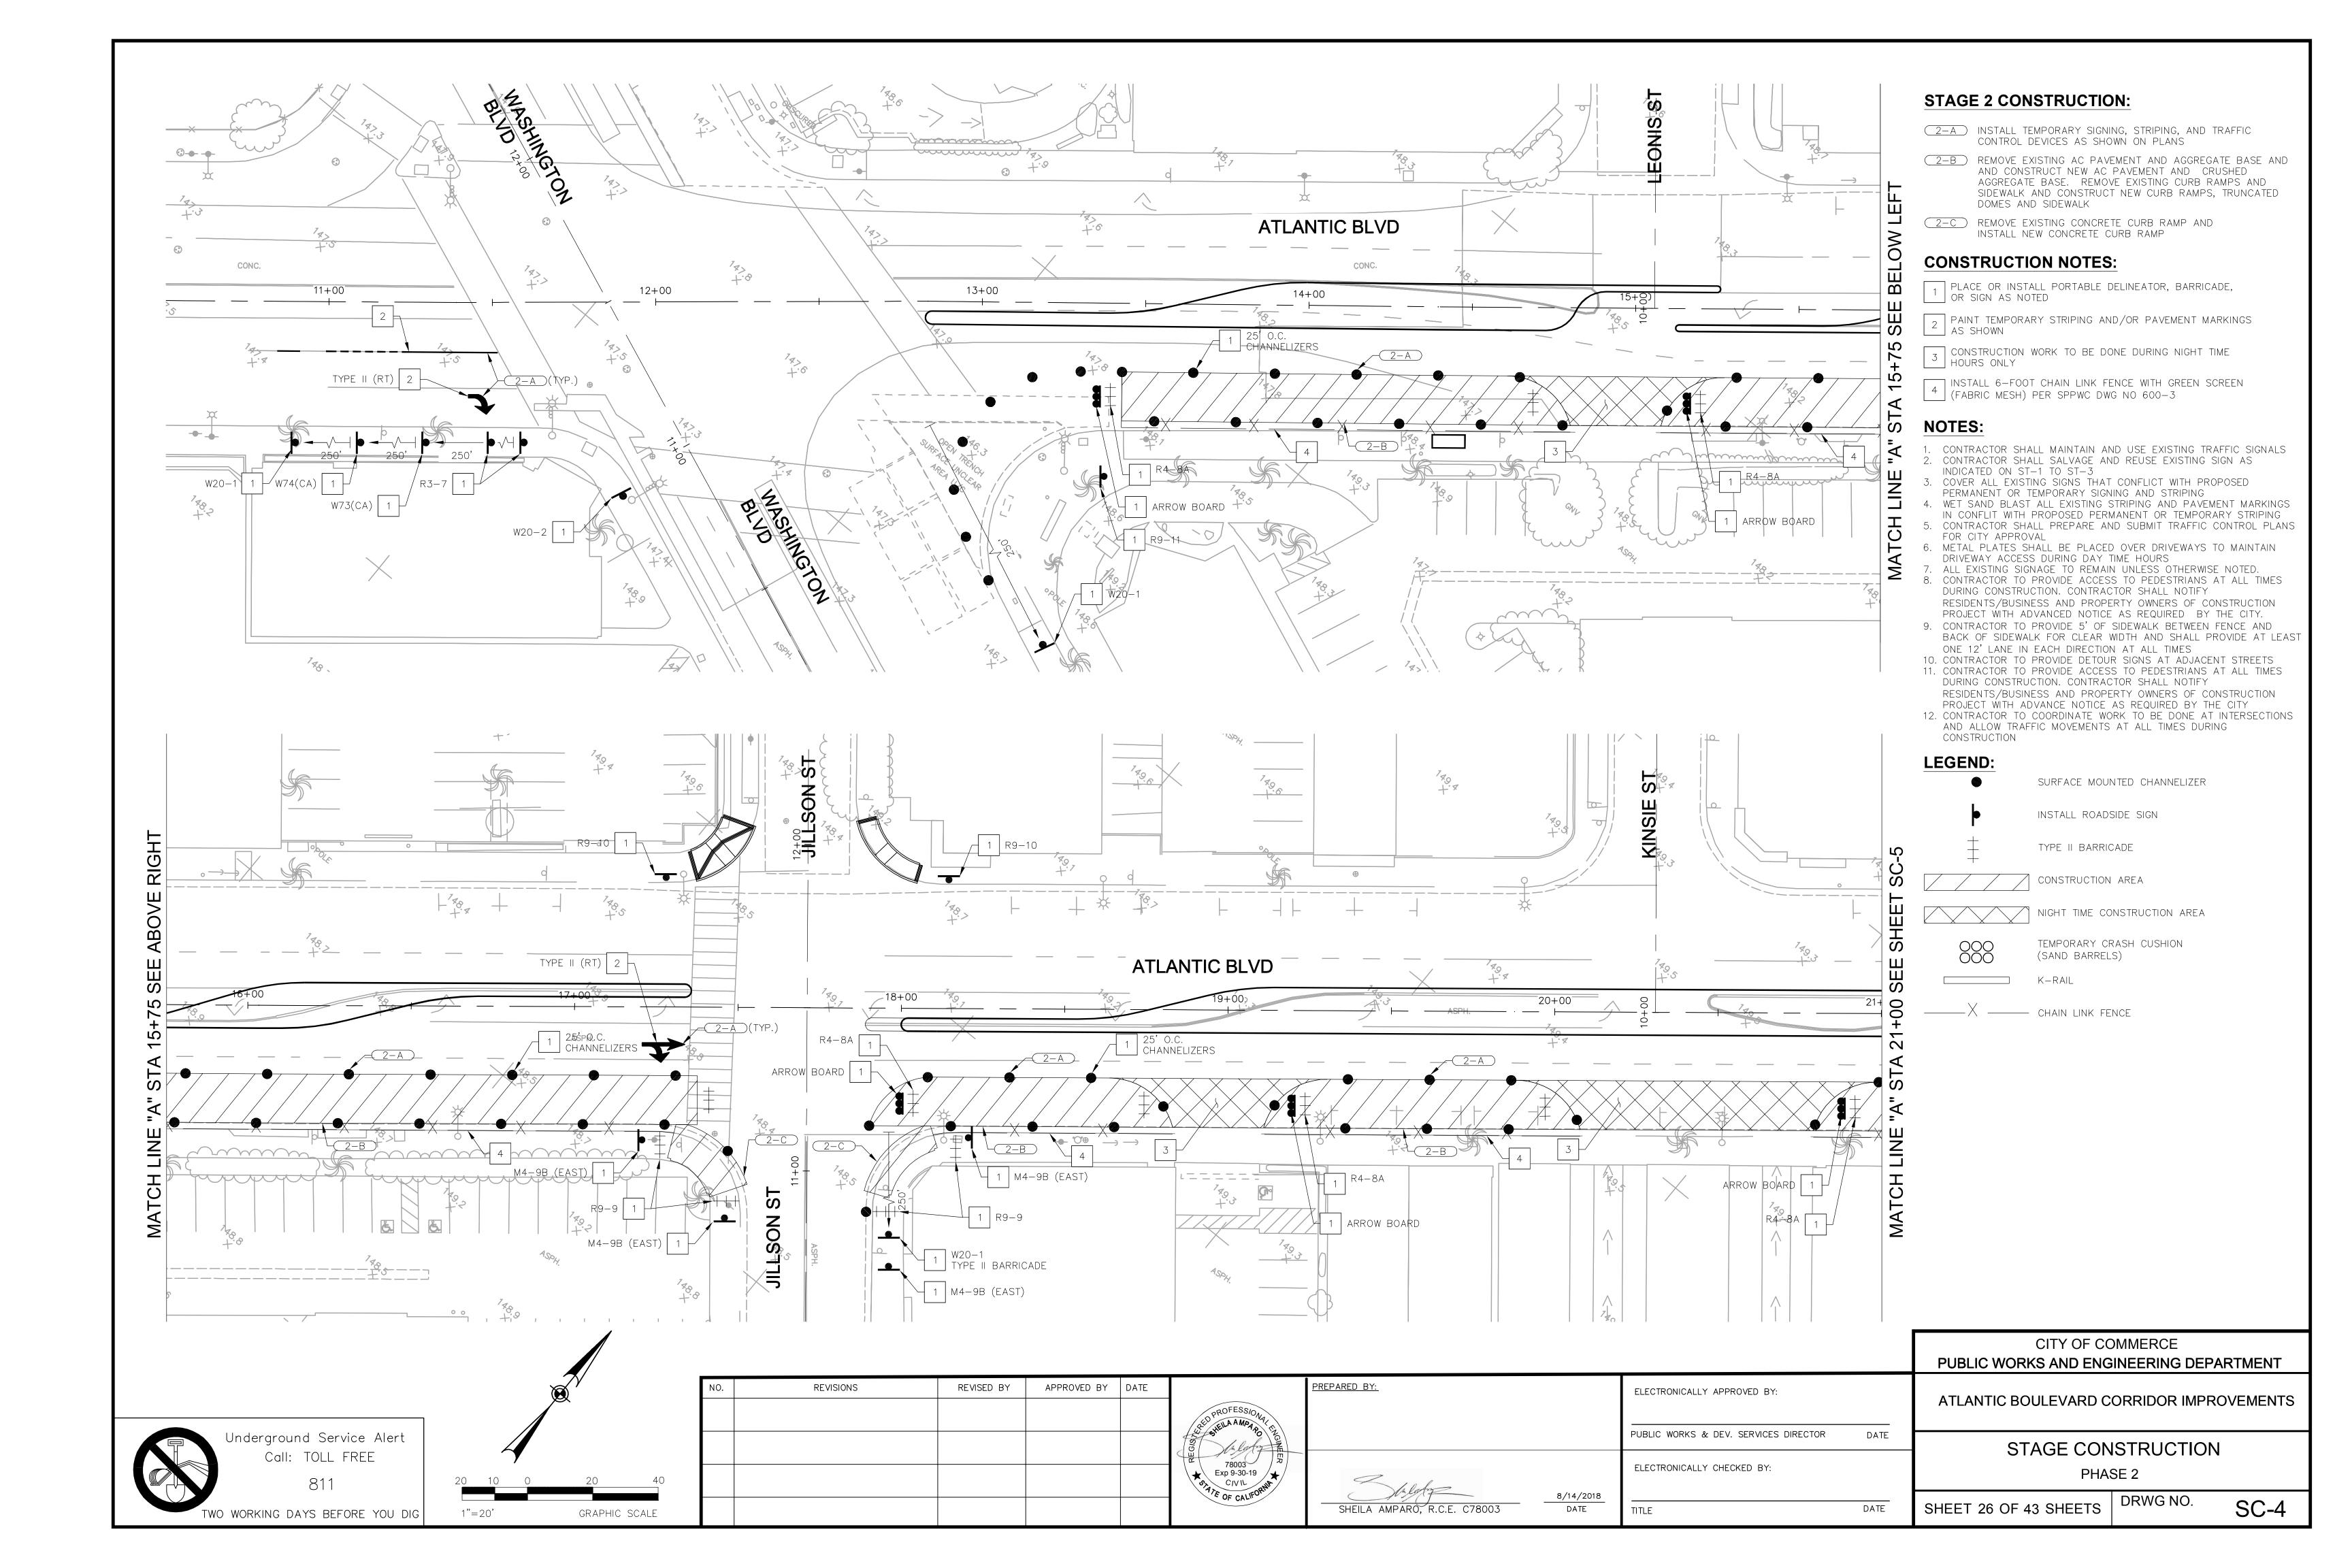


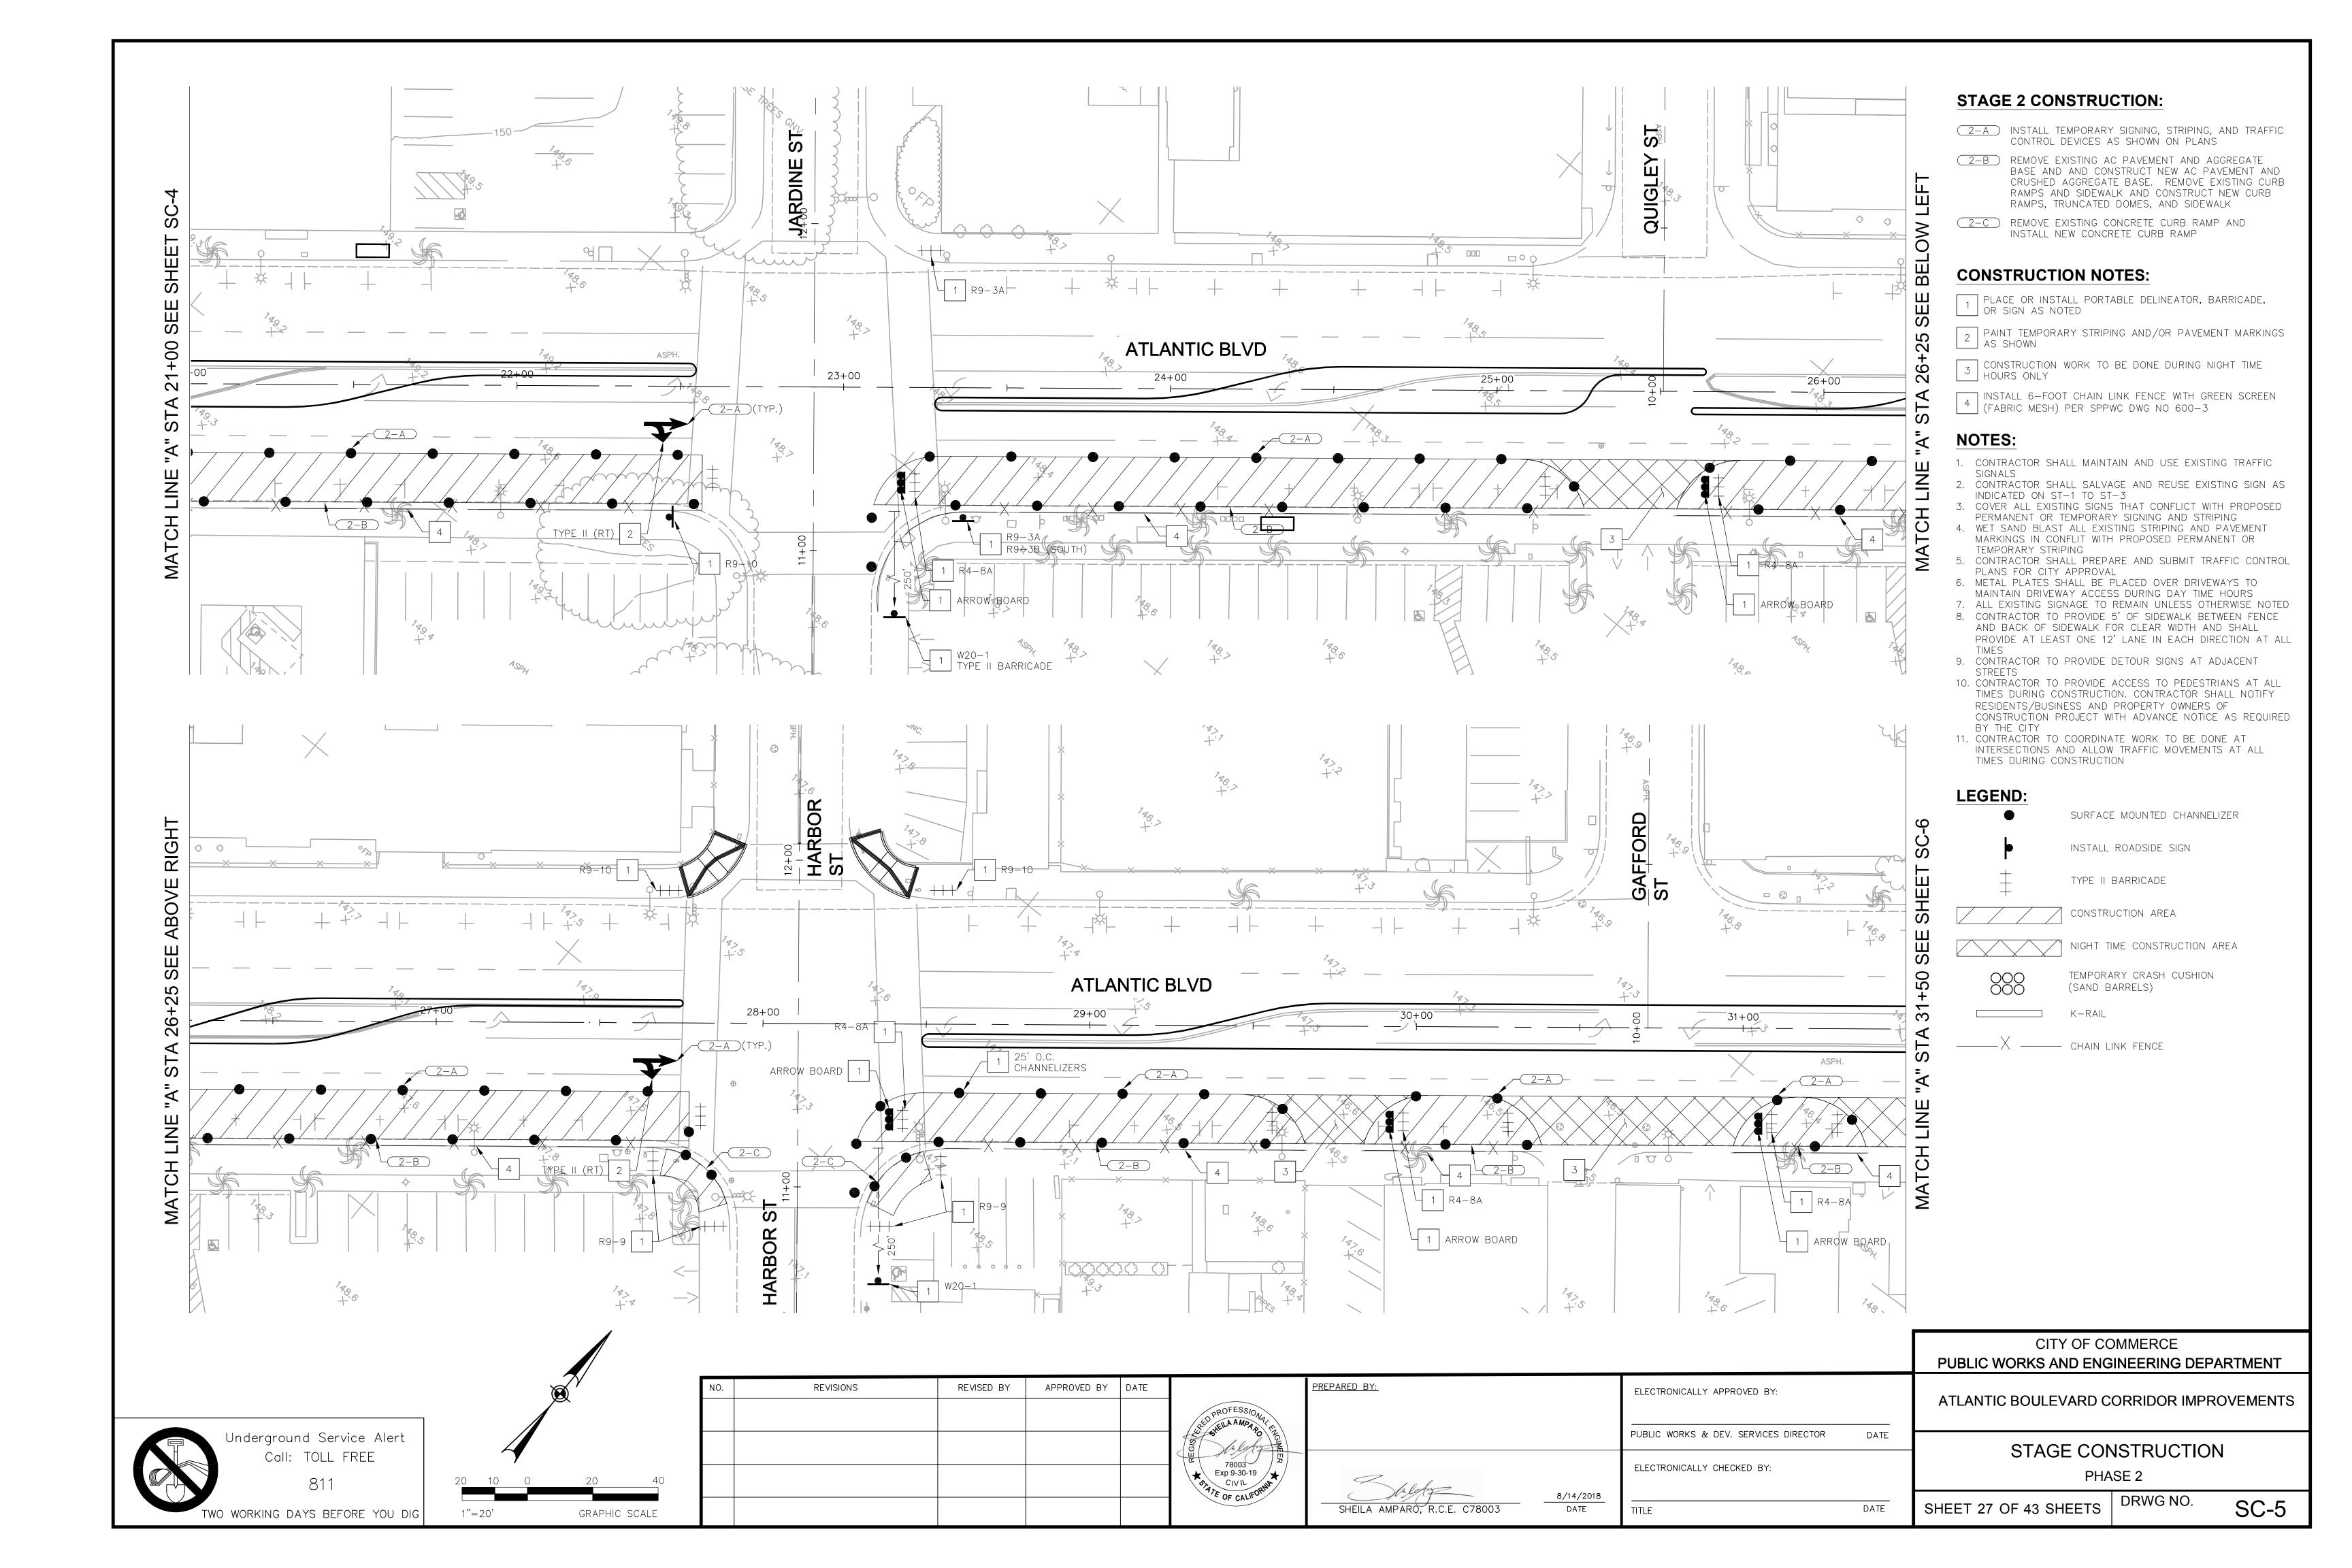


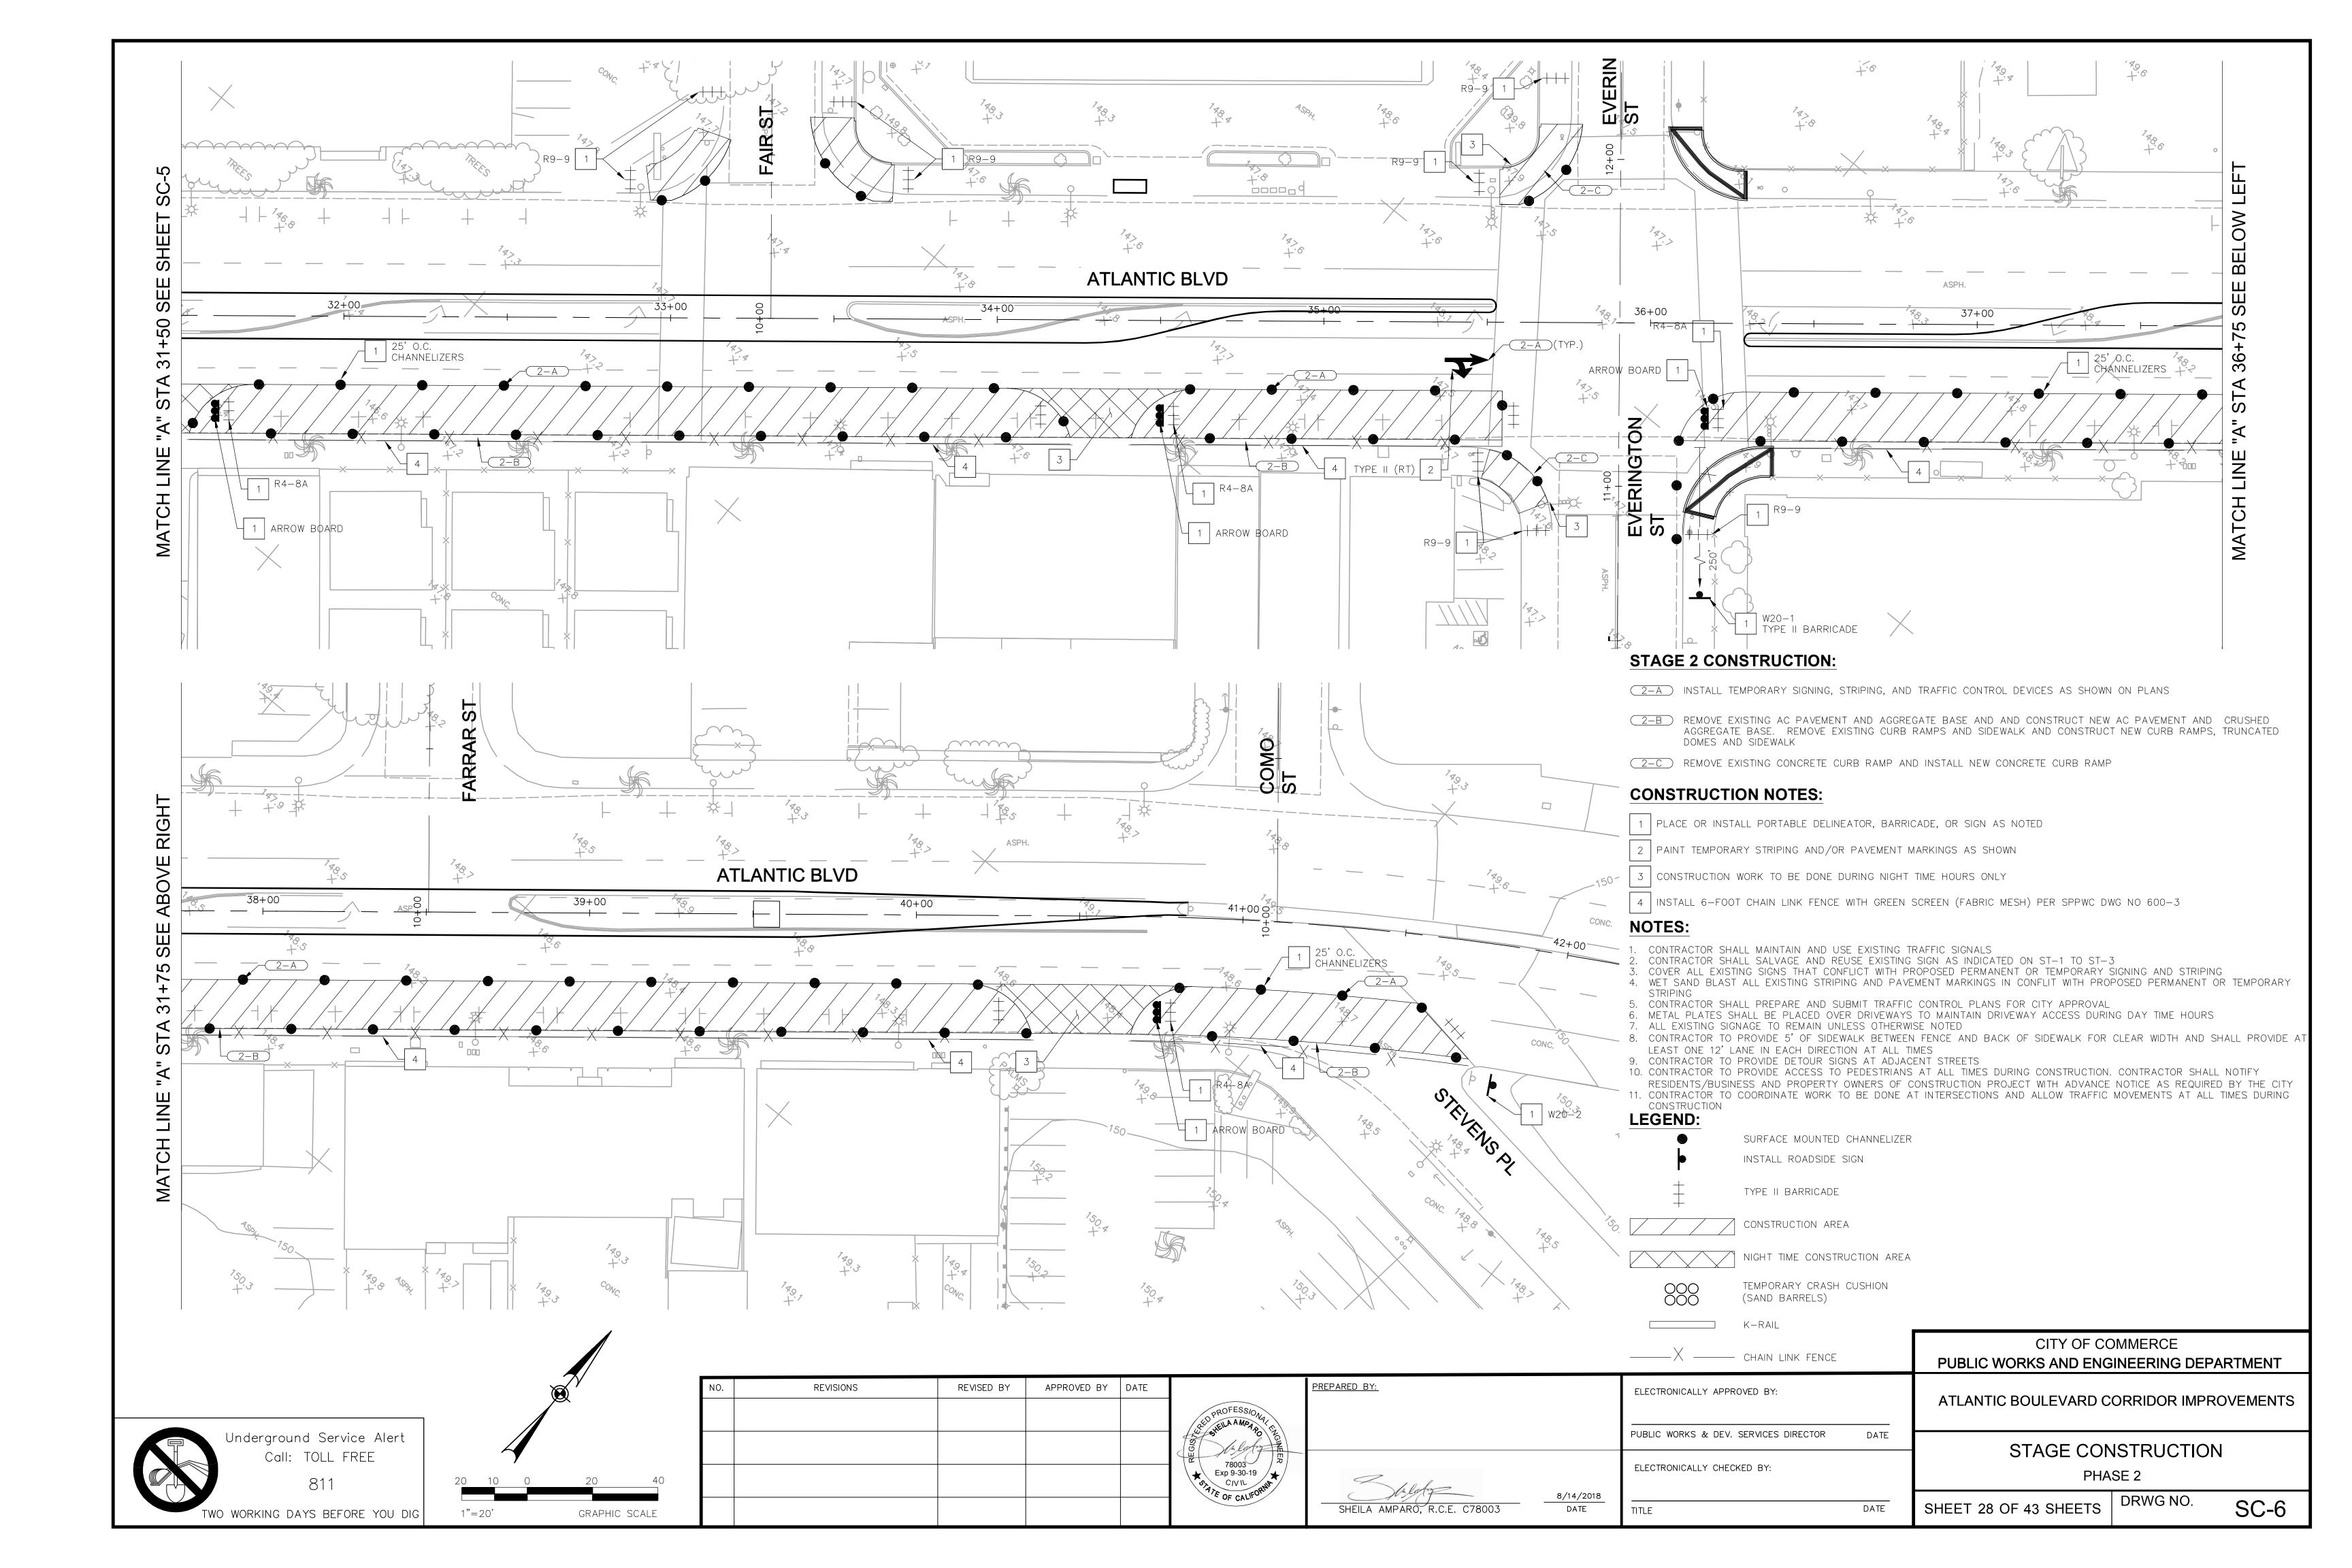


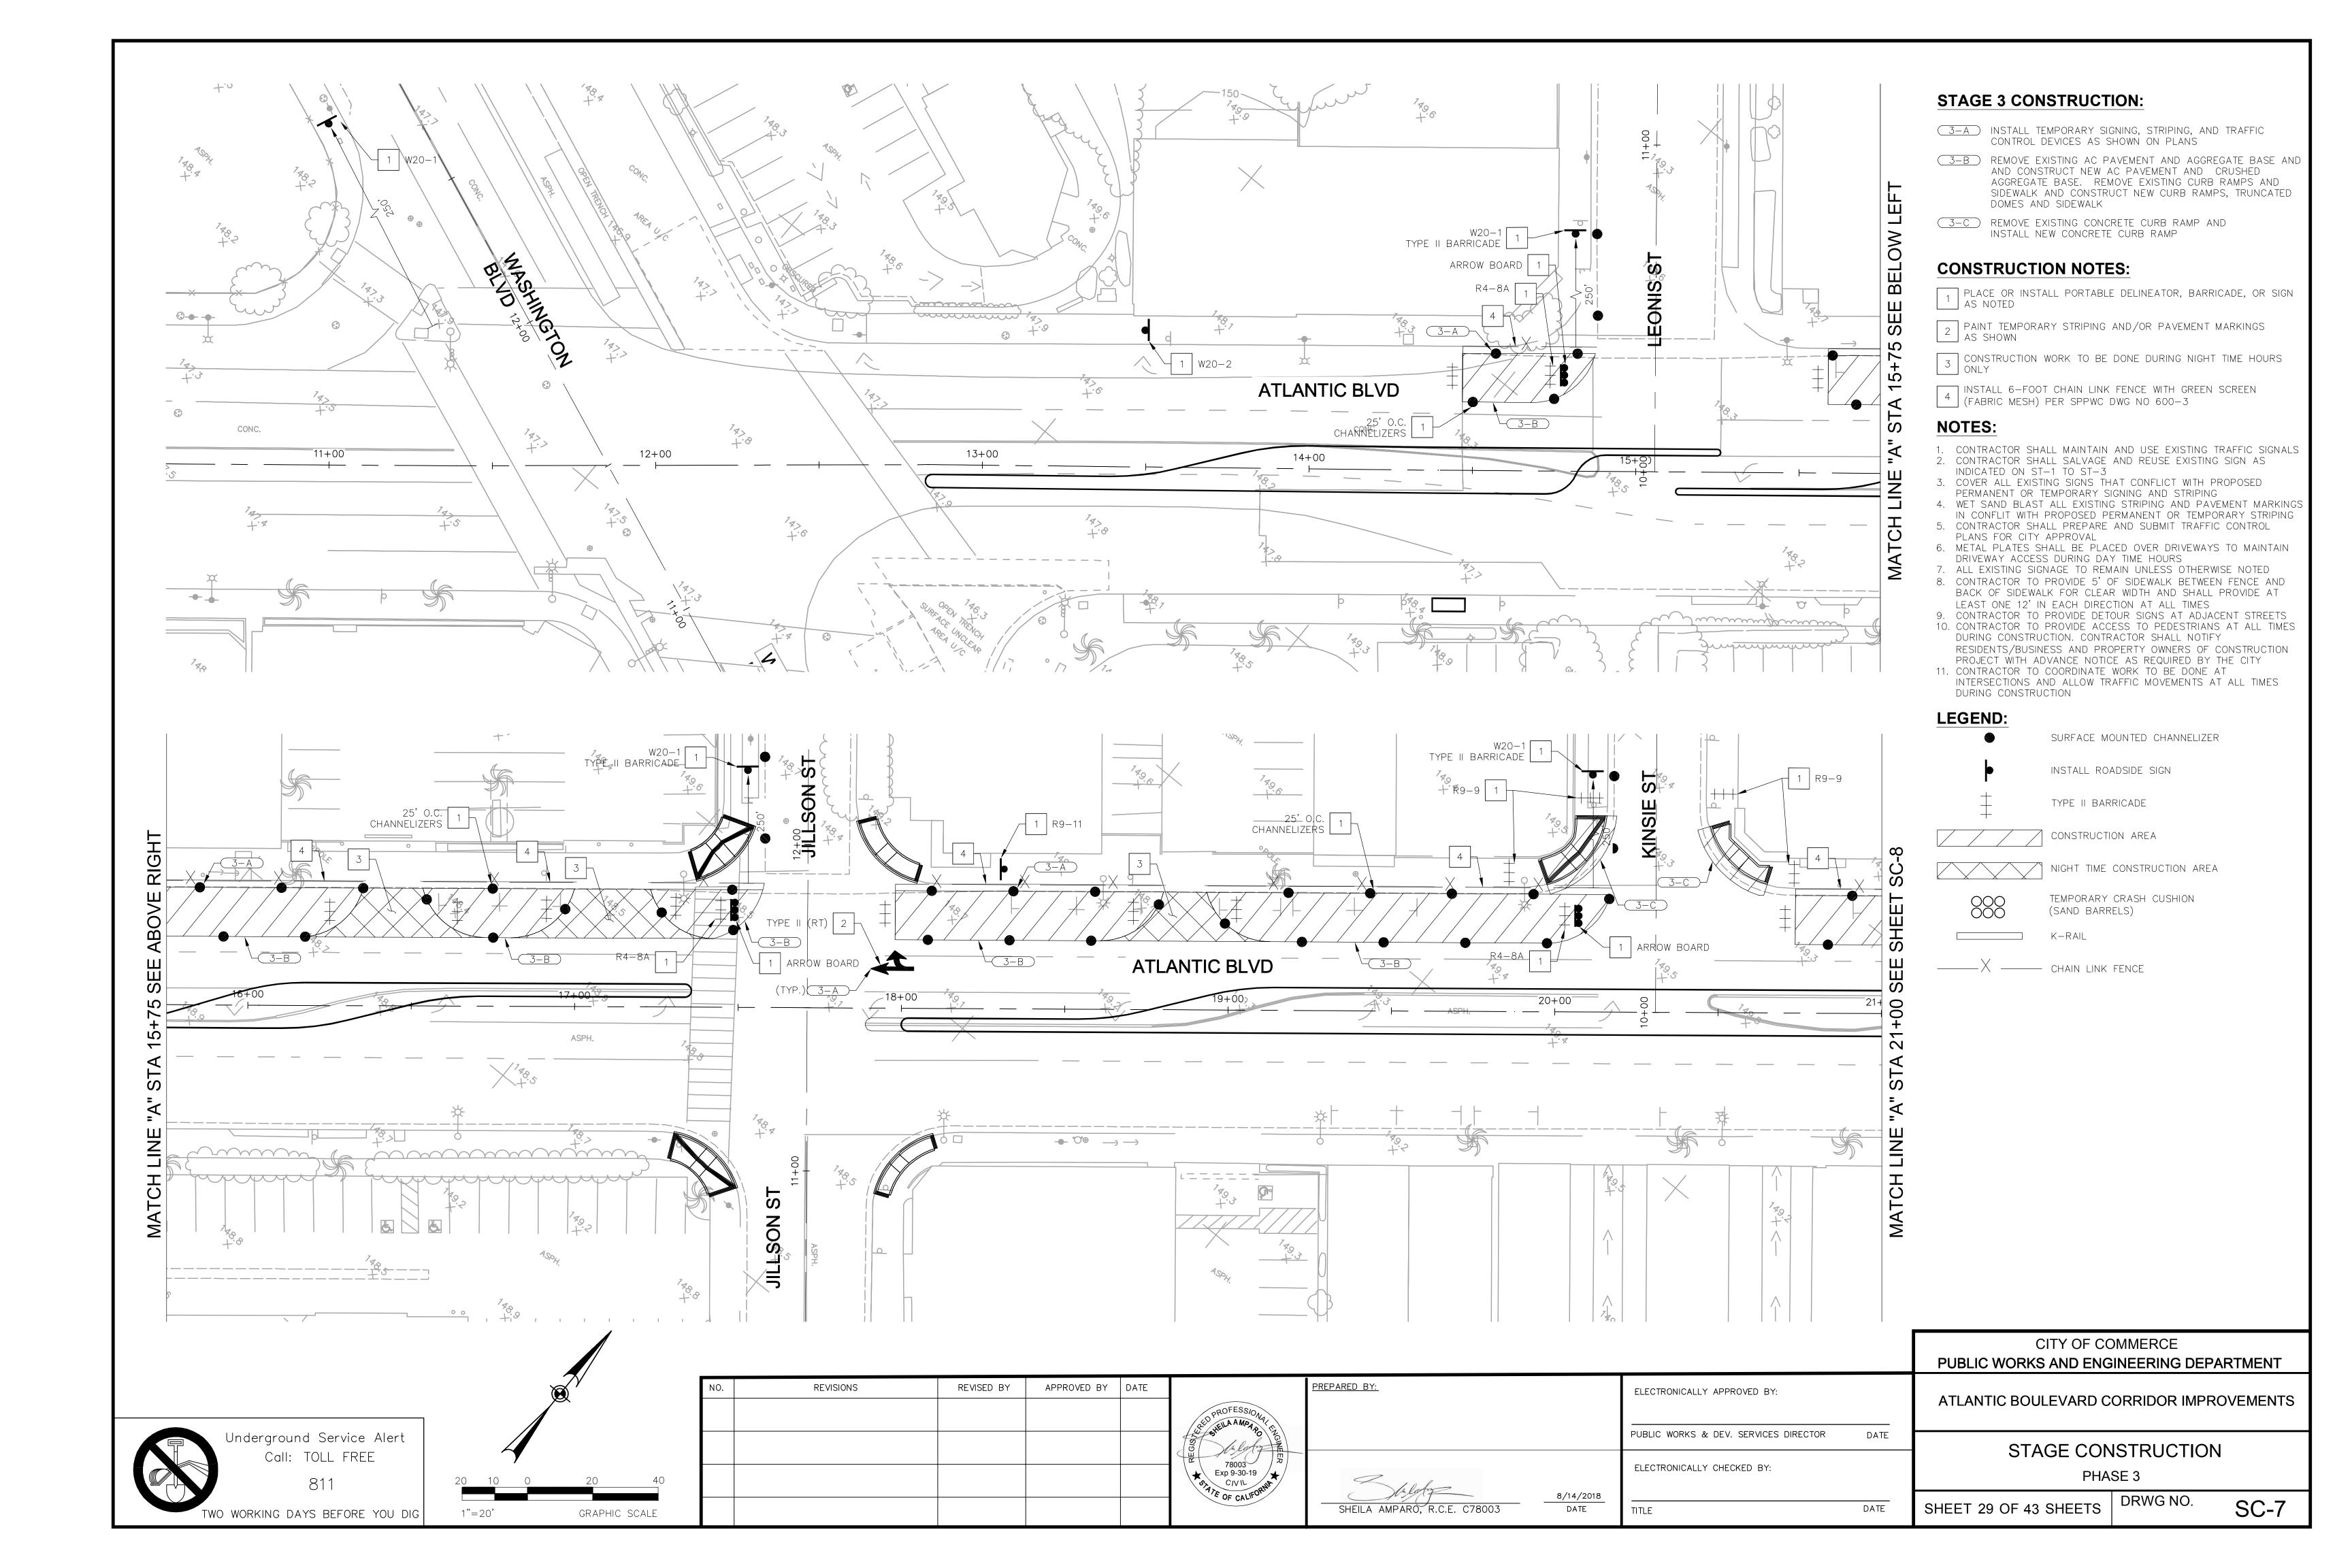


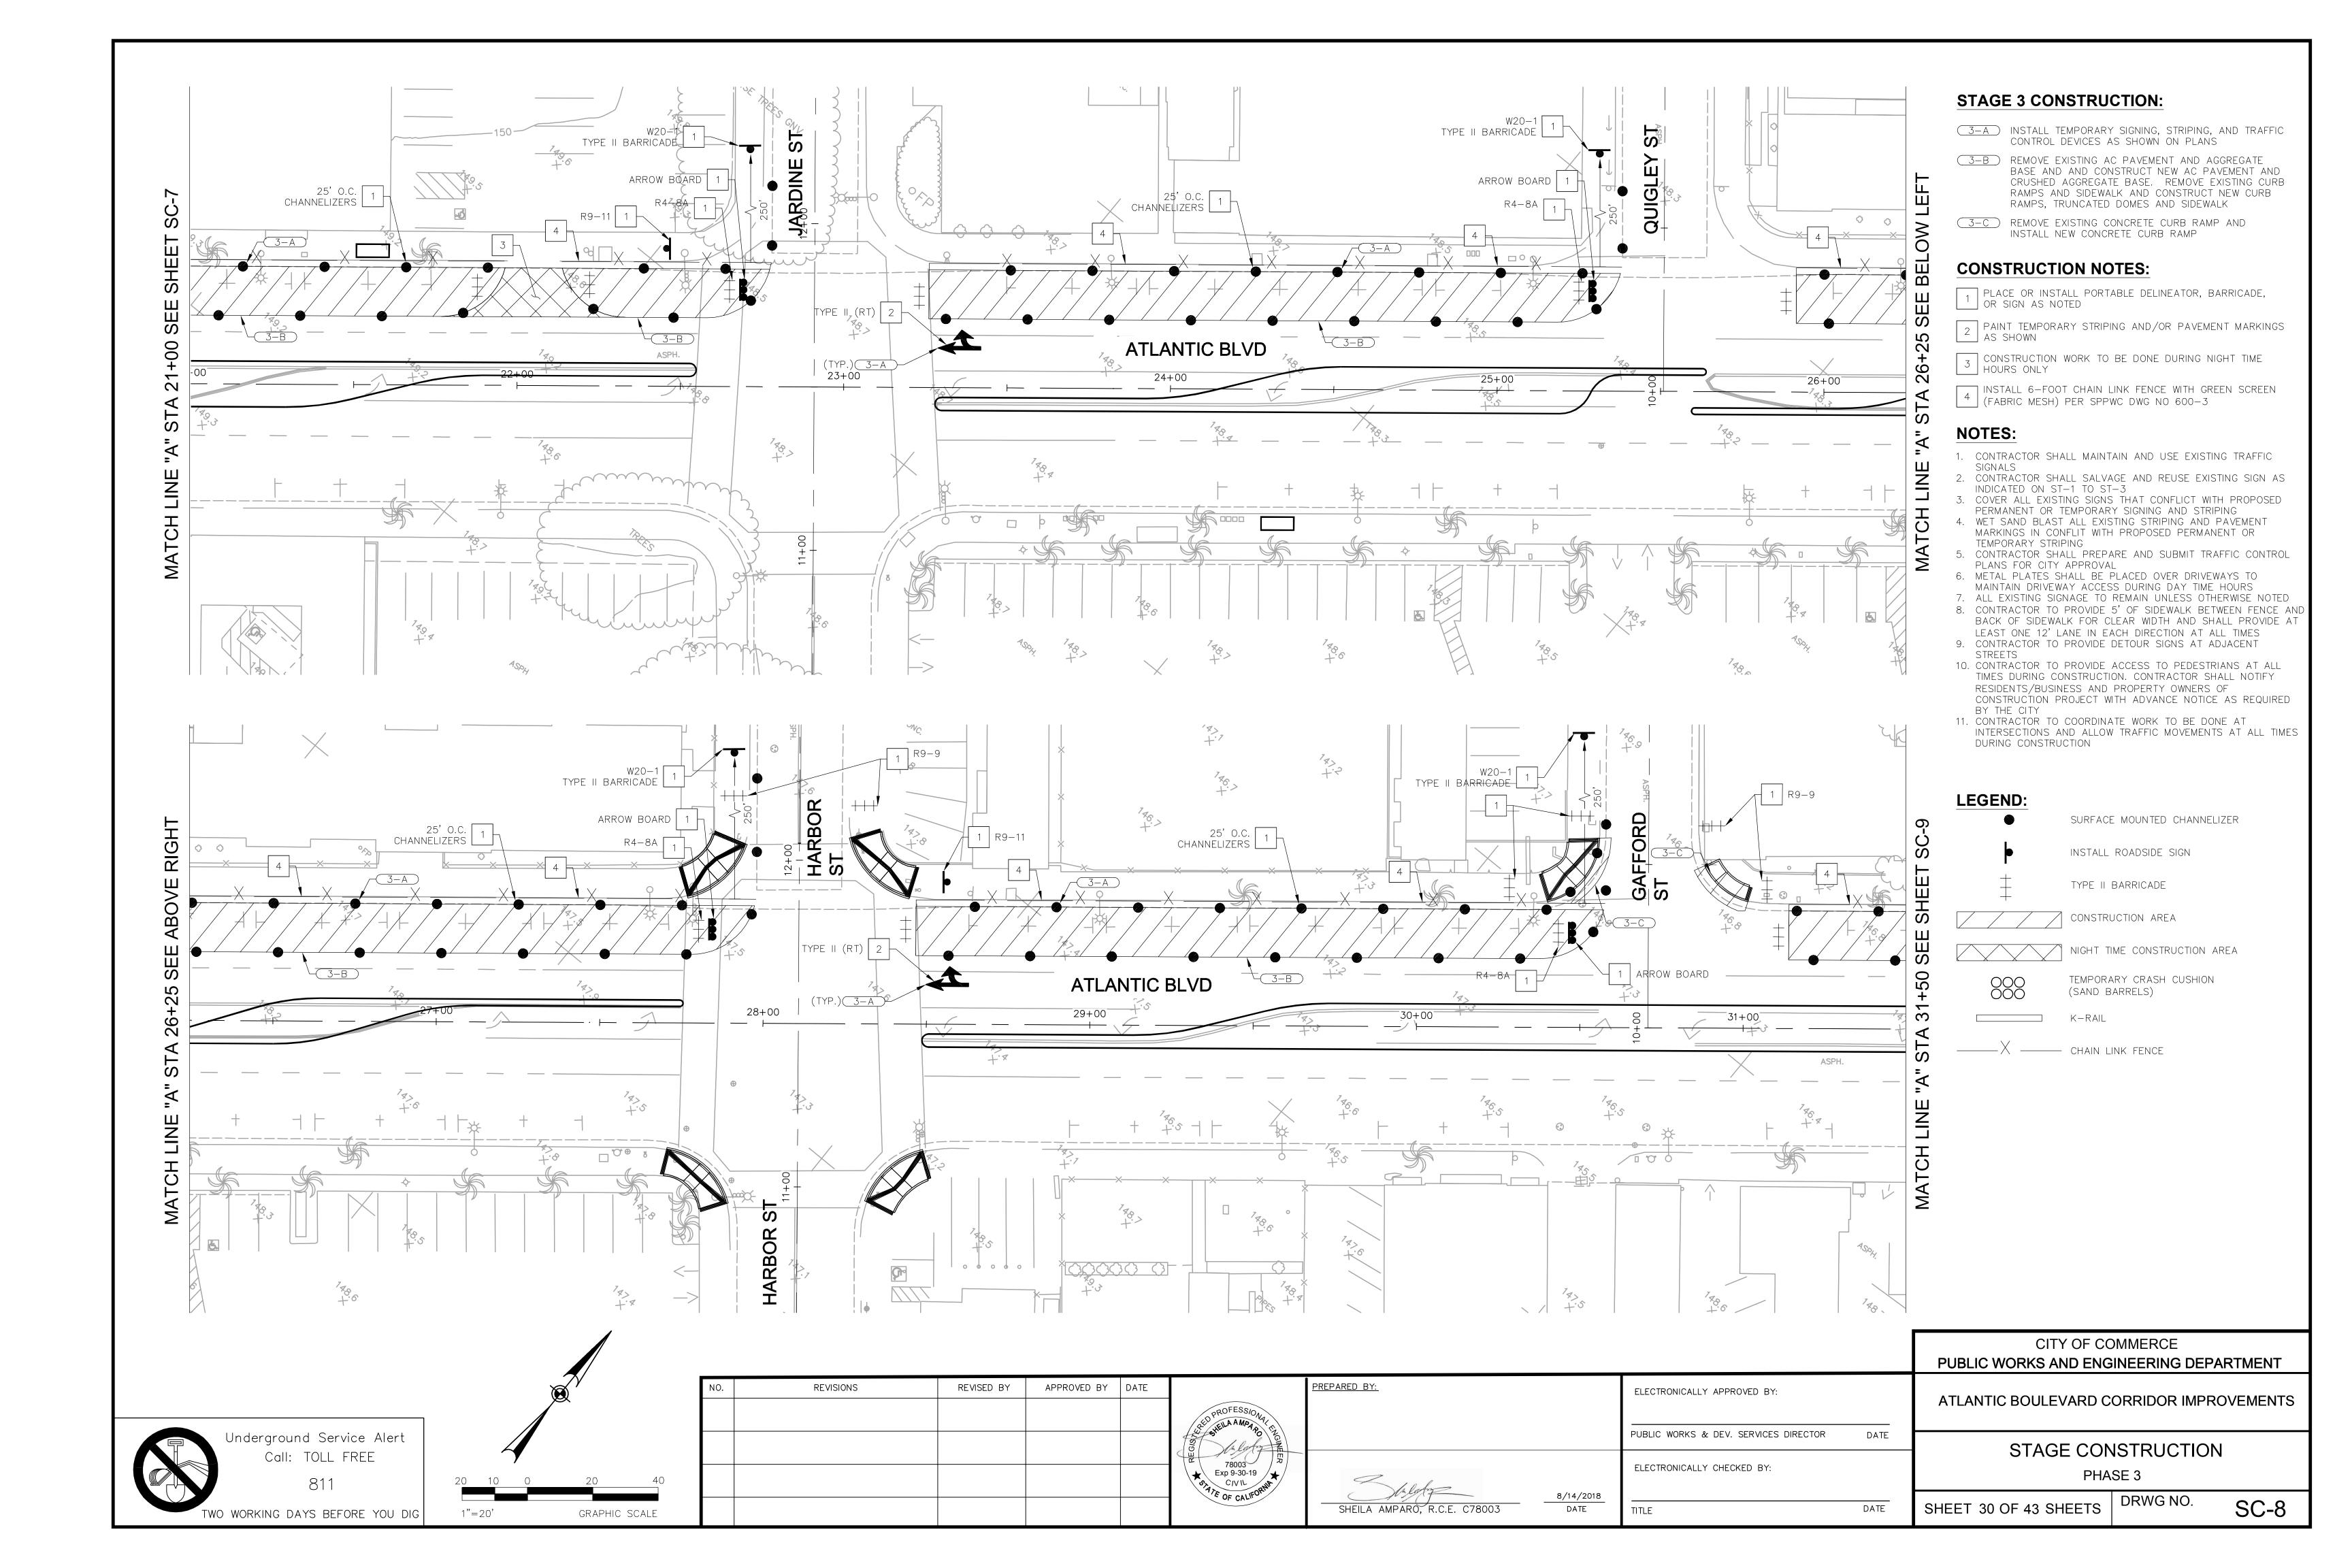

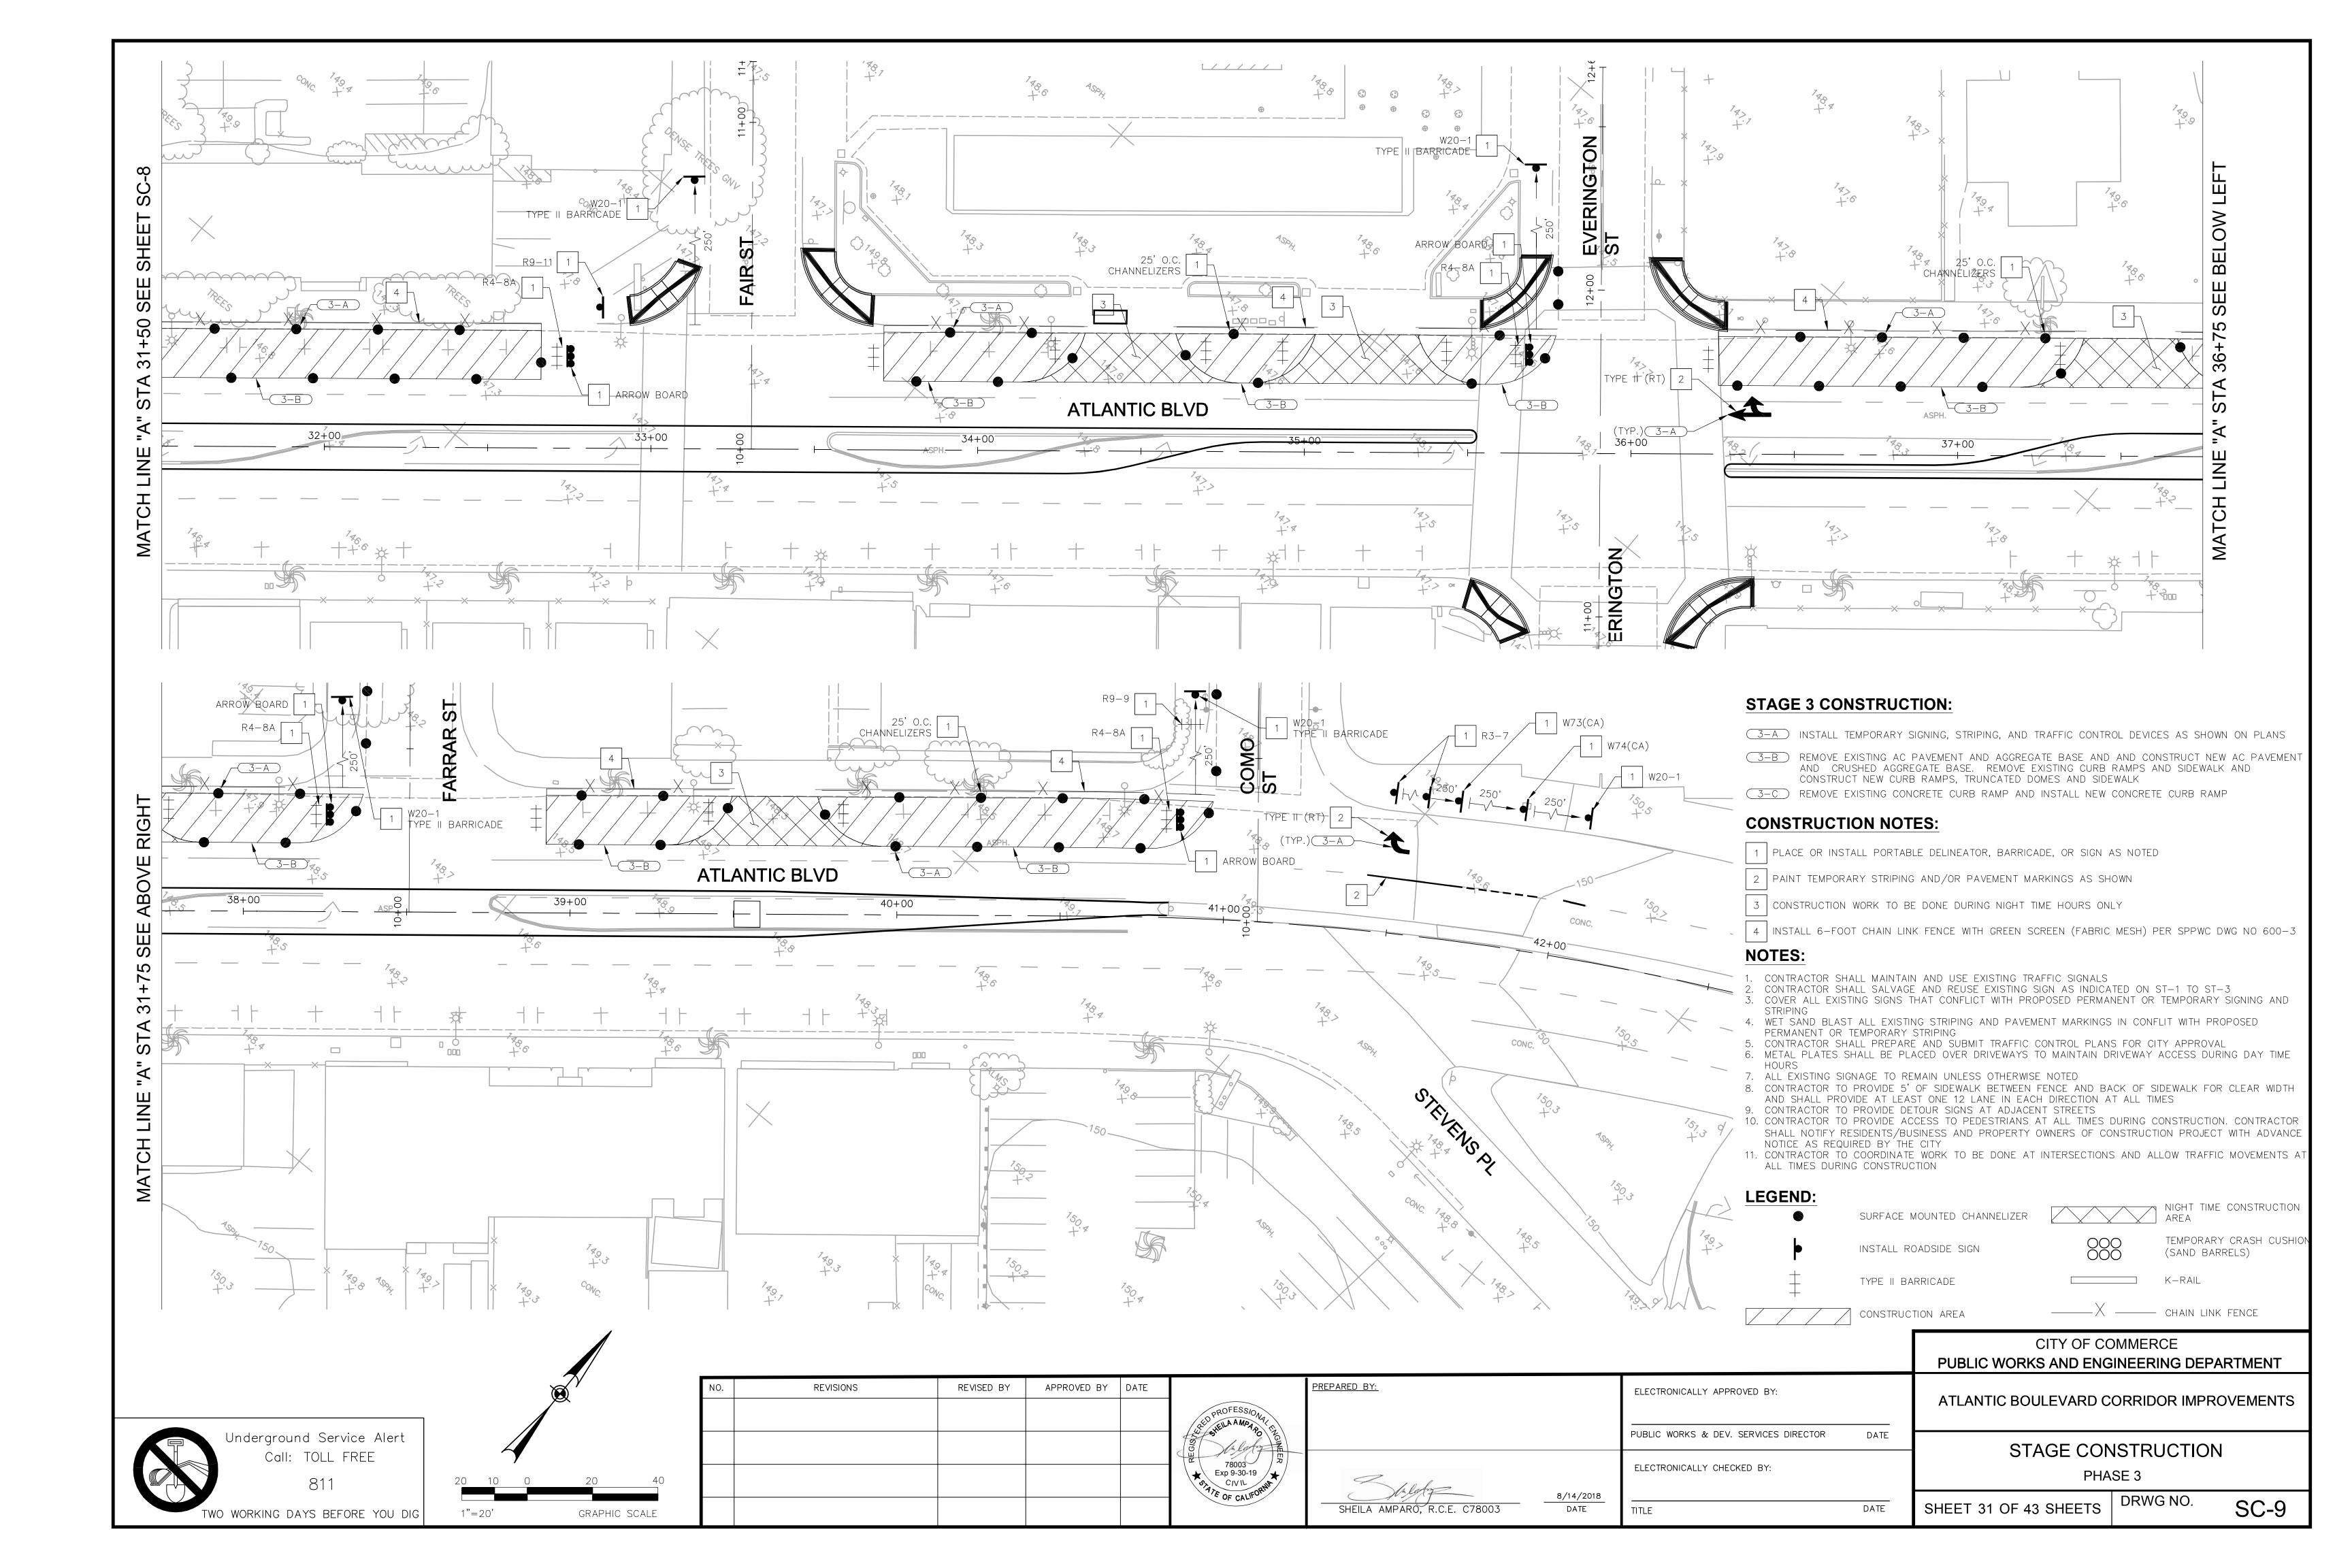

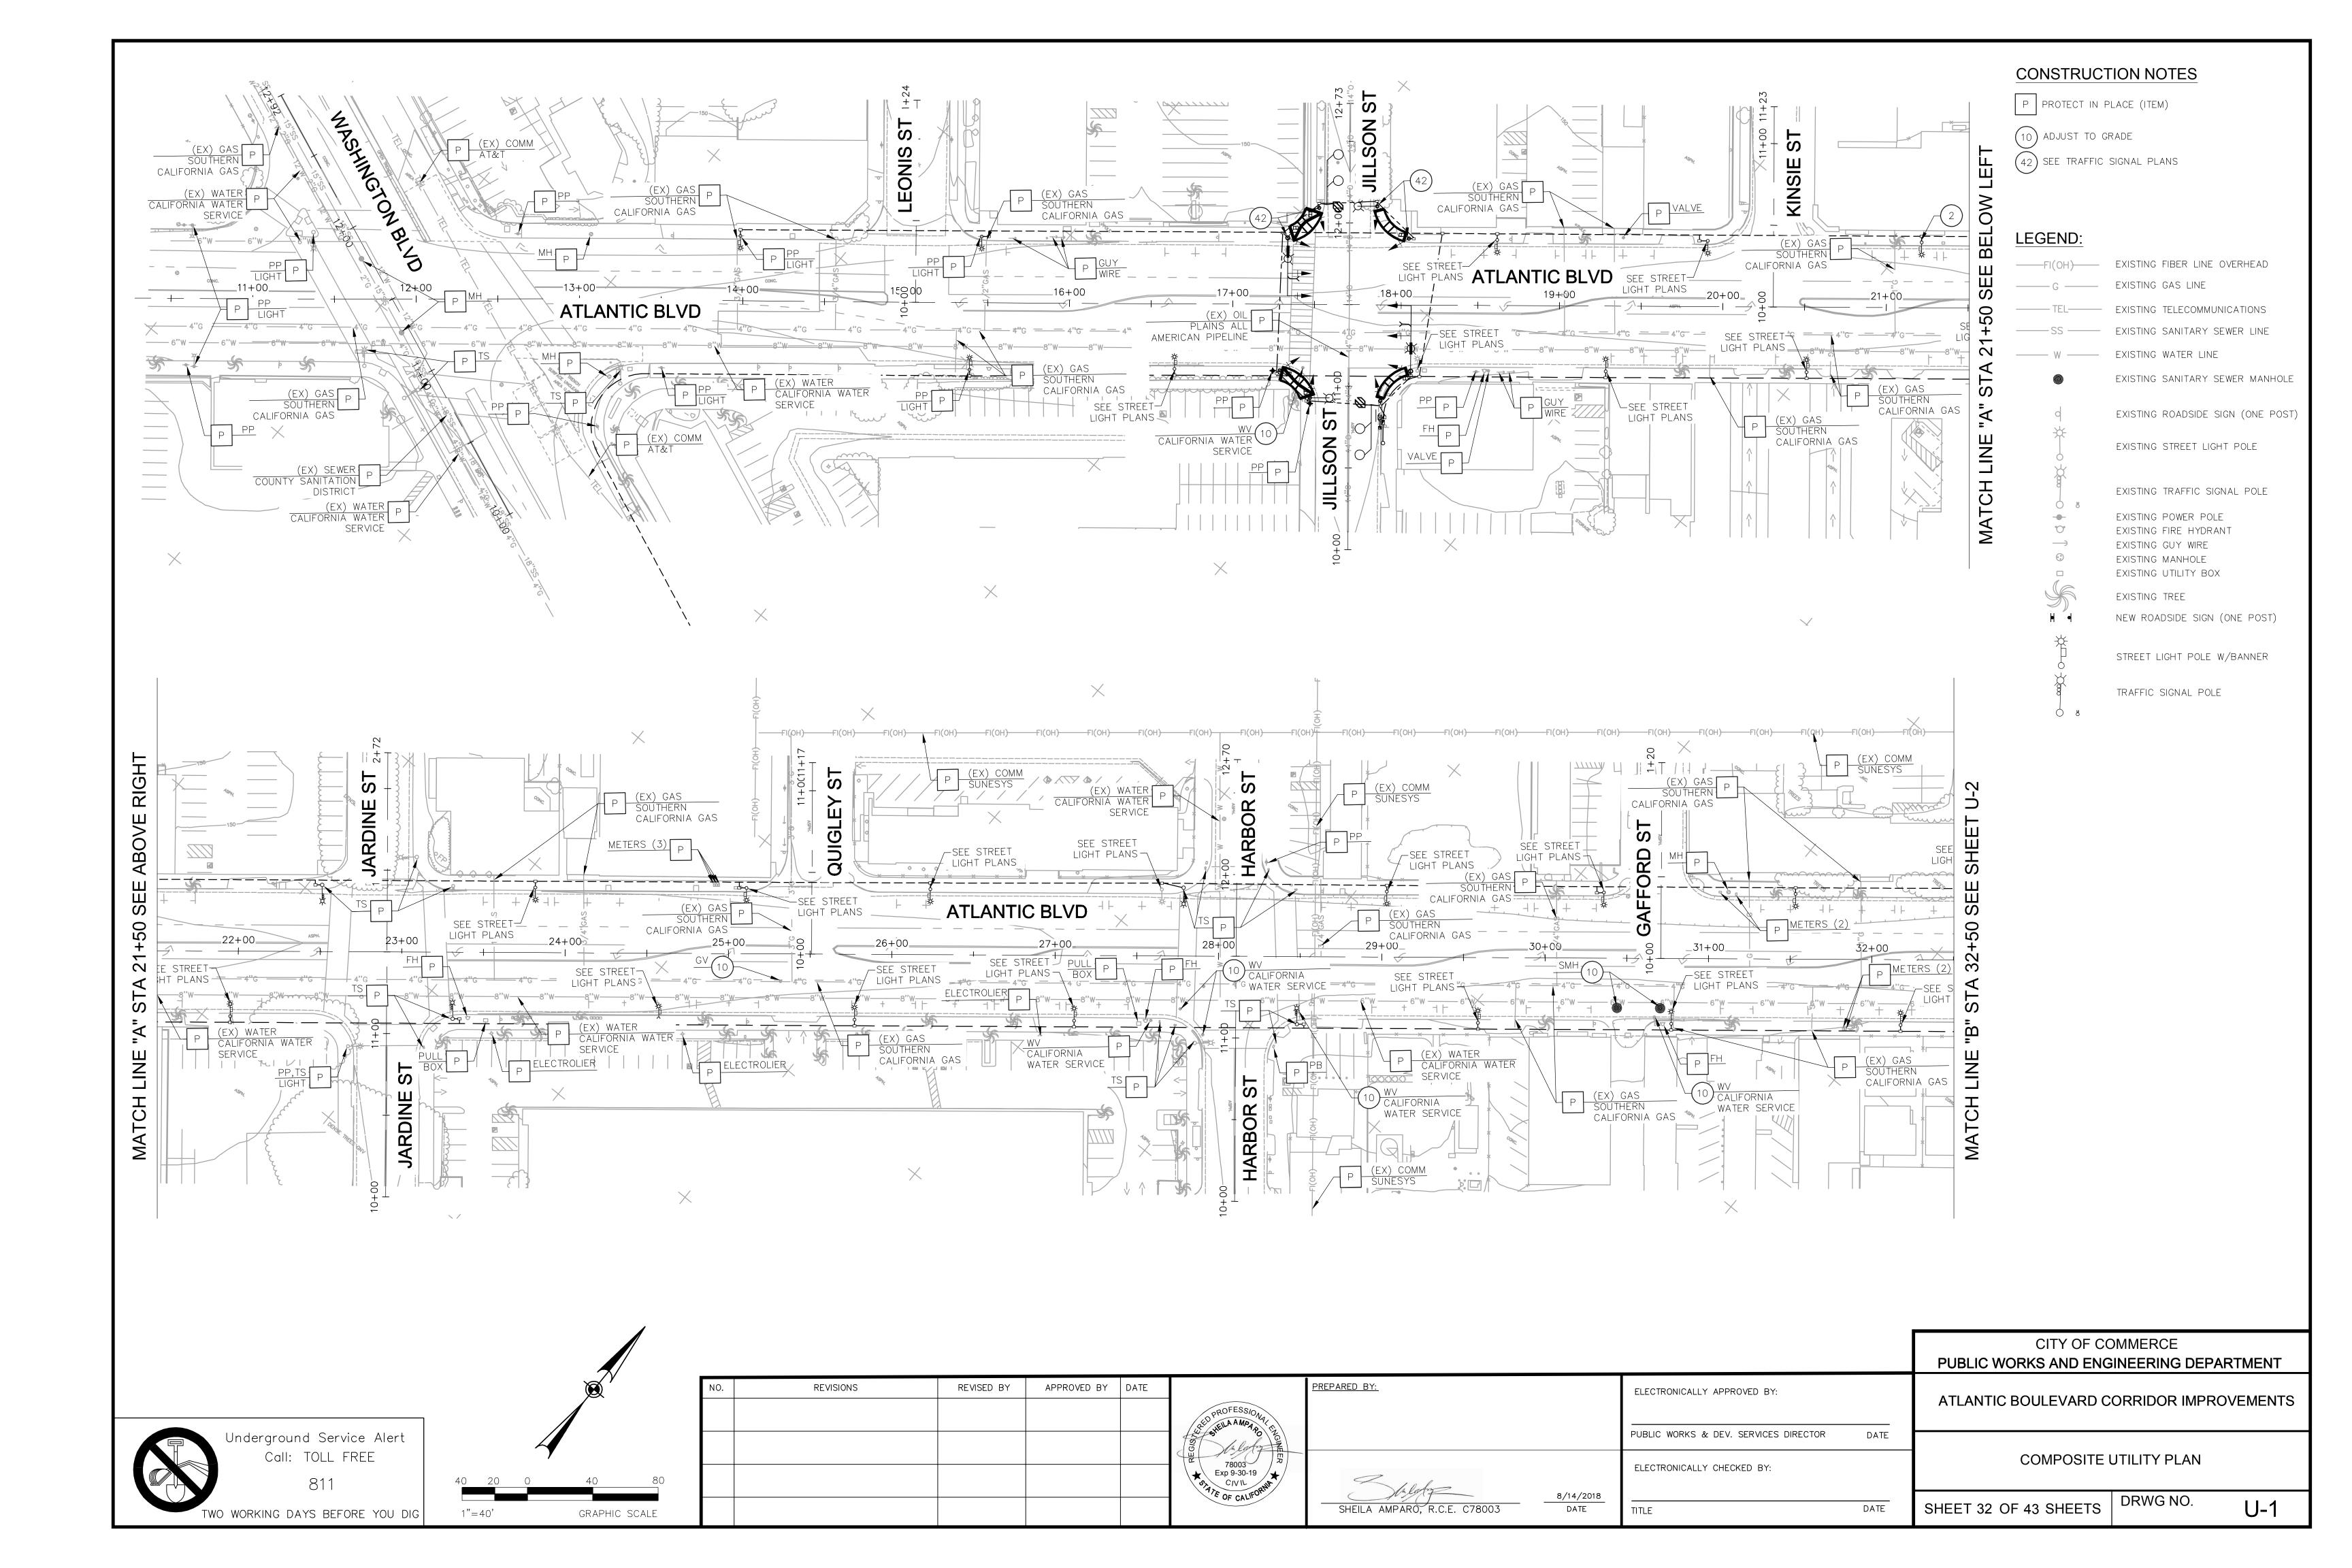

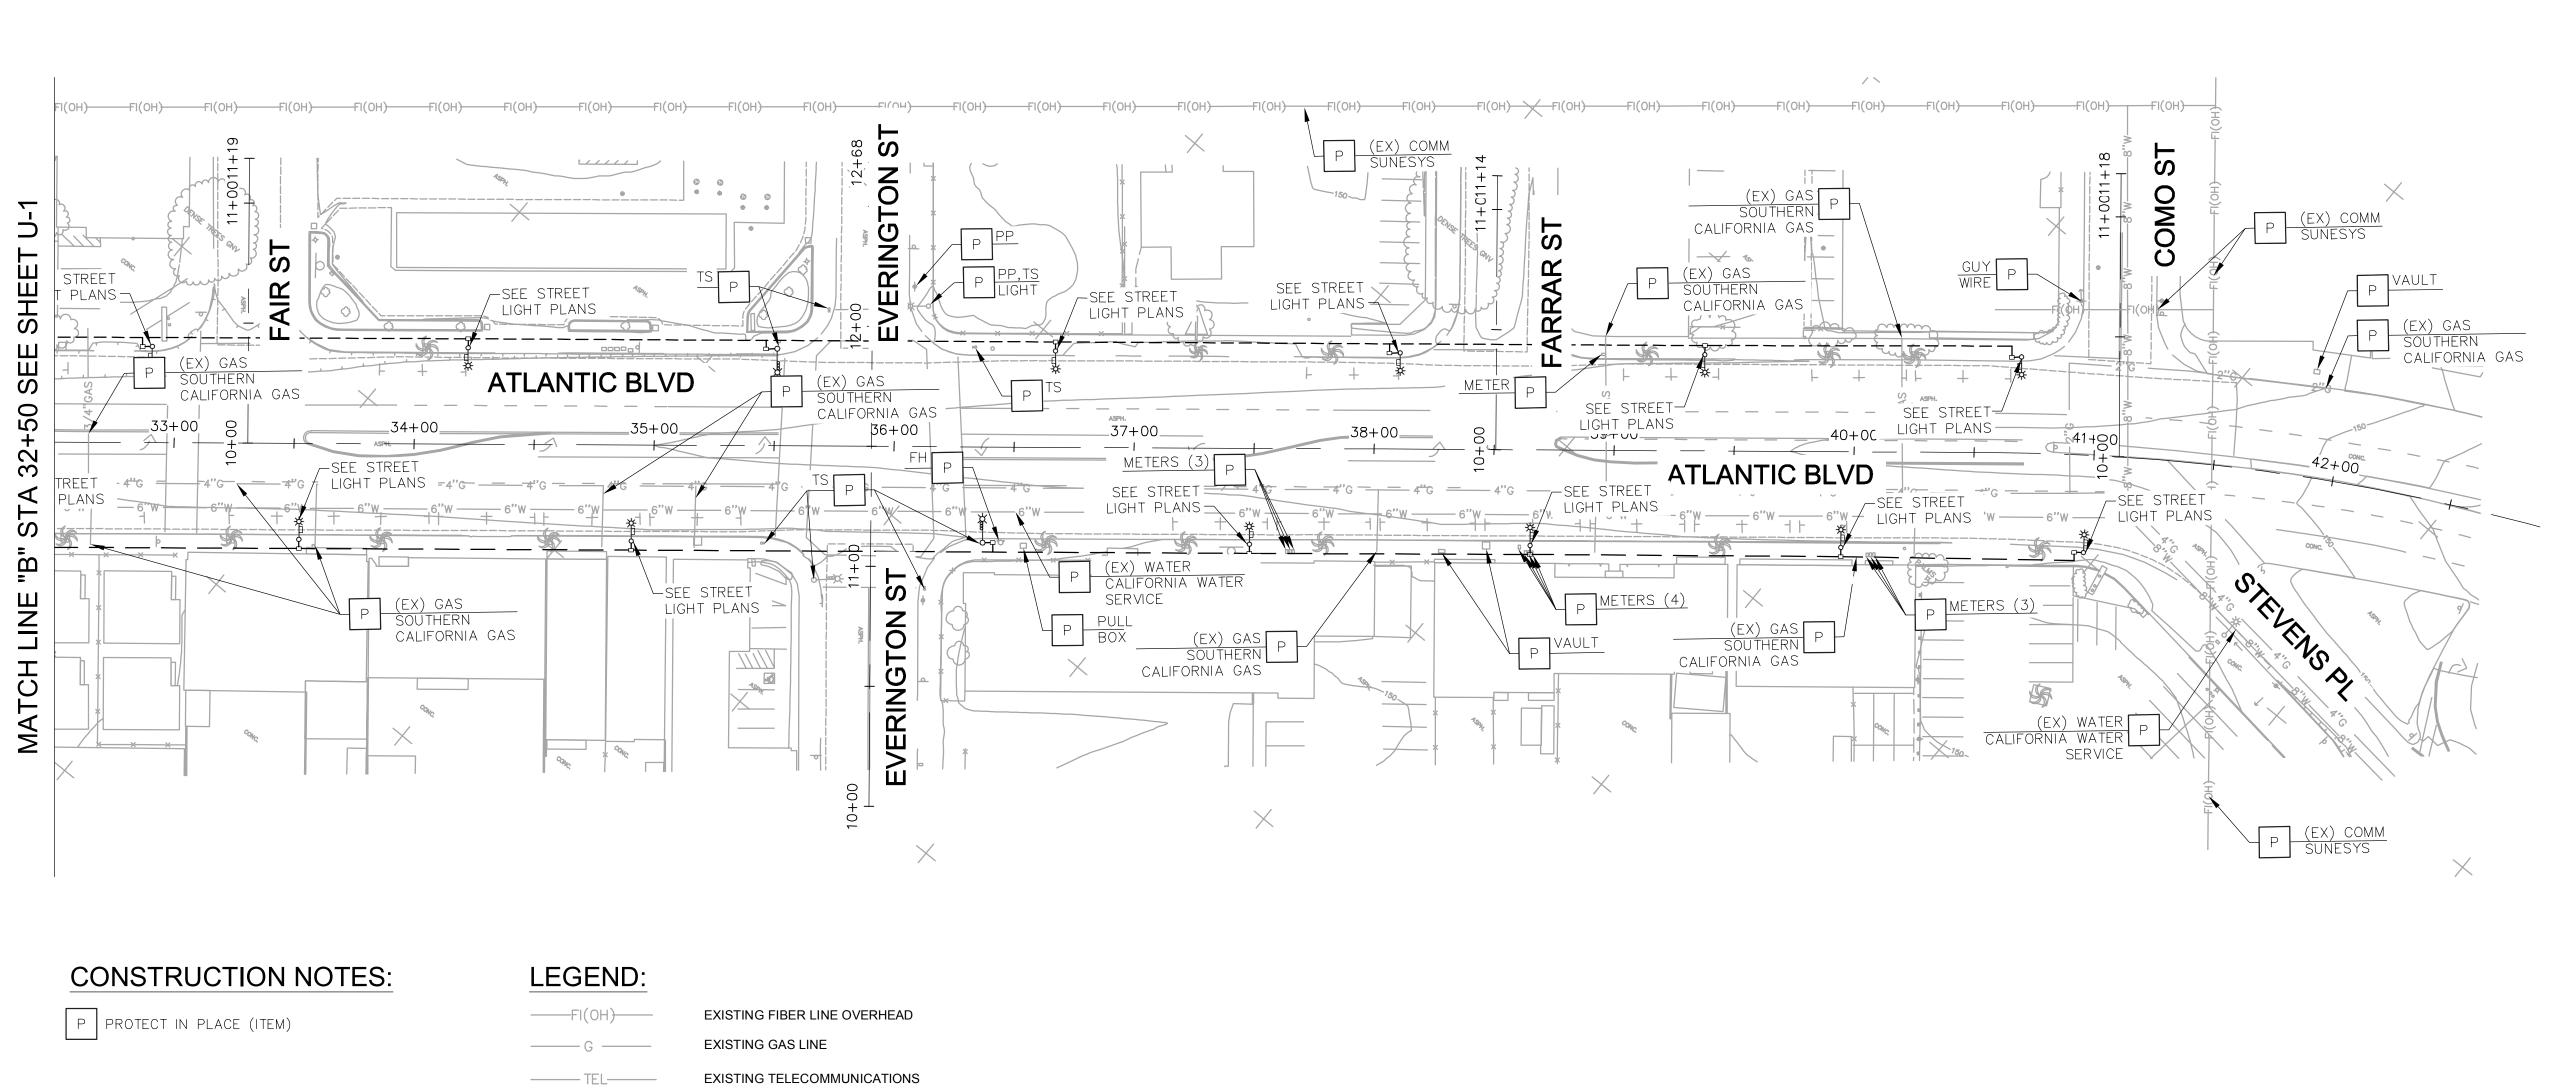

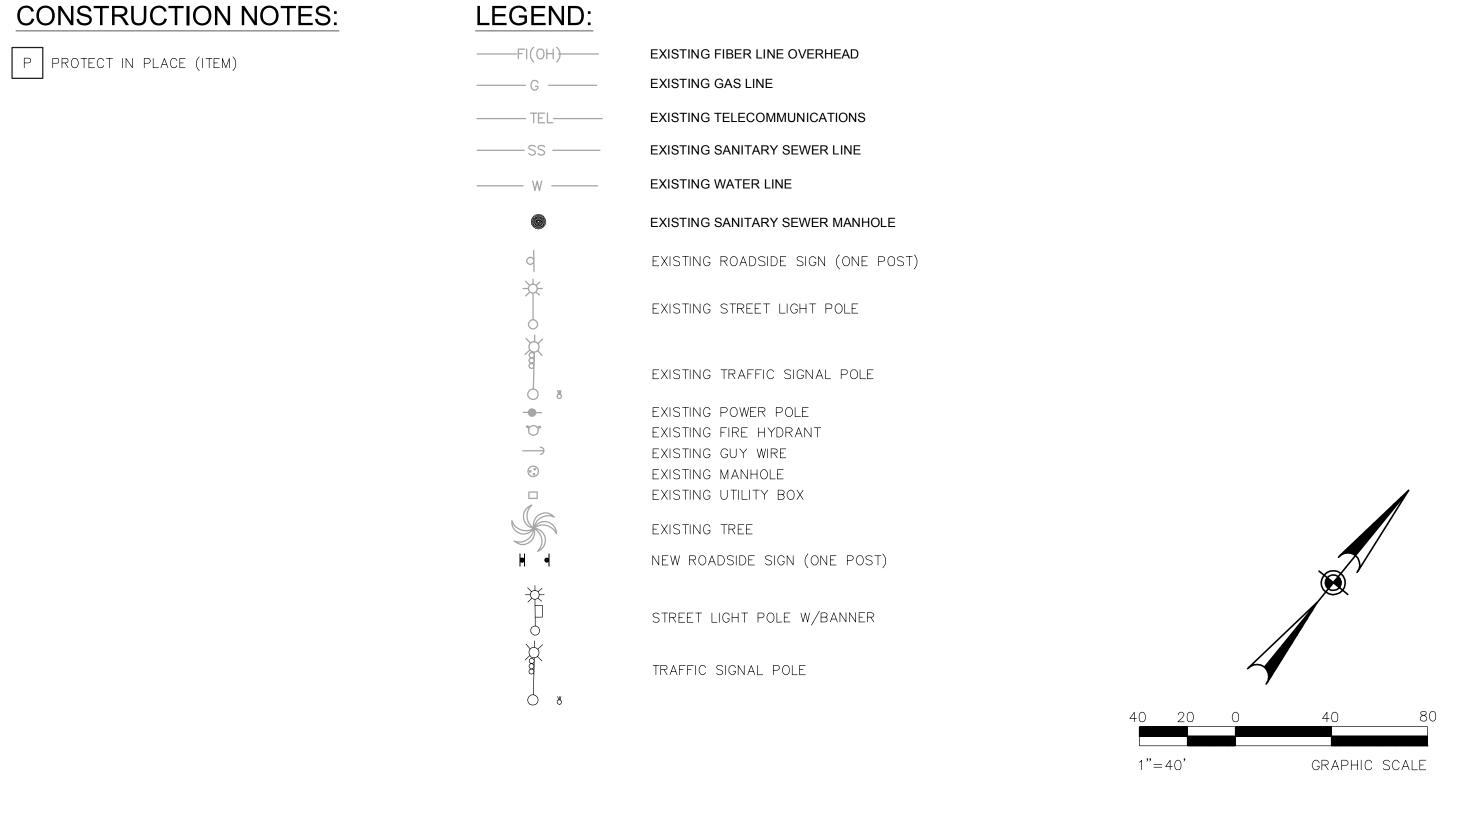

	Underground Service Alert Call: TOLL FREE 811
TWO	WORKING DAYS BEFORE YOU DIG

REVISIONS	REVISED BY	APPROVED BY	DATE	
				PROFESSION AMPA
				The July
				78003 Exp 9-30-19 C/V IL OF CALIF
				OF CAL

PROFESSION A A MP	
PROFESSIONAL THE PROFESSION AND A PORTION OF THE PROPERTY OF T	
78003	
Exp 9-30-19 / /	
OF CALIFORNIA	

1	PREPARED BY:			
	FREPARED DI.		ELECTRONICALLY APPROVED BY:	
ı				
			PUBLIC WORKS & DEV. SERVICES DIRECTOR	DATE
			ELECTRONICALLY CHECKED BY:	
ı	Milaty	8/14/2018		
ı	SHEILA AMPARO, R.C.E. C78003	DATE	TITLE	DATE

PUBLIC	WORKS AND ENGINEERING DEPARTMENT
ATLAN ⁻	TIC BOULEVARD CORRIDOR IMPROVEMENTS

CITY OF COMMERCE

COMPOSITE UTILITY PLAN

U-2

DRWG NO. SHEET 33 OF 43 SHEETS

ATLANTIC BLVD. MEDIANS

WASHINGTON BLVD. TO COMO ST., COMMERCE, CA

NEW MEDIAN LANDSCAPE IMPROVEMENTS 14 SEPTEMBER 2018

GENERAL NOTES -

SCOPE OF WORK

ALL WORK SHALL COMPLY WITH ALL CITY STANDARDS. THE WORK SHALL INCLUDE ALL LABOR, MATERIALS, EQUIPMENT AND INCIDENTALS NECESSARY FOR THE INSTALLATION OF ALL WORK INDICATED IN THESE PLANS AND THE SPECIFICATIONS. CONTRACTOR SHALL VERIFY SPECIFIC CONDITIONS OF THE WORK TO BE PERFORMED W/ THE INVITATION TO BID.

QUALITY OF MATERIALS

MATERIALS SPECIFIED IN THE PLANS AND SPECIFICATIONS SHALL PREVAIL WHEN OF A HIGHER STANDARD THAN THOSE REQUIRED TO MEET STATE AND LOCAL CODES.

PLAN BACKGROUND

THESE PLANS ARE BASED UPON ELECTRONIC FILE SITE INFORMATION PROVIDED BY OTHERS. CONTRACTOR SHALL VERIFY SITE INFORMATION IN THE FIELD. LOST WEST HAS PREPARED THESE PLANS AND SPECIFICATIONS AS PROJECT LANDSCAPE ARCHITECT. LOST WEST SHALL NOT BE RESPONSIBLE FOR ANY WORK WHICH IS NOT EXPLICITLY DETAILED IN THESE PLANS, AND IS NOT RESPONSIBLE FOR THE WORK OF ANY OTHER COMPANY OR PERSONS PROVIDING SERVICES ON THIS PROJECT EITHER IN THE PAST OR IN THE FUTURE. THE CONTRACTOR SHALL BE SOLELY RESPONSIBLE FOR DETERMINING THE METHOD AND MEANS OF CONSTRUCTION.

CHANGES TO PLANS

THE DESIGNS AND TECHNICAL INFORMATION PRESENTED IN THESE PLANS AND SPECIFICATIONS ARE THE PROPERTY OF LOST WEST. CHANGES WITHOUT THE EXPRESSED WRITTEN CONSENT OF LOST WEST ARE PROHIBITED AND WOULD RELIEVE LOST WEST OF ALL RESPONSIBILITY AS TO EVENTUAL PROJECT OUTCOME.

EXISTING SITE CONDITIONS

CONTRACTOR SHALL BE RESPONSIBLE FOR CONTACTING UNDERGROUND SERVICE ALERT FOR THE MARK-OUT OF UTILITIES PRIOR TO THE COMMENCEMENT OF ANY WORK RELATED TO THESE PLANS.

CONTRACTOR SHALL VERIFY THE LOCATION OF ALL STRUCTURES ABOVE AND BELOW GROUND WITHIN AND ADJACENT TO THE PROJECT SITE PRIOR TO AND DURING THE COURSE OF WORK. CONTRACTOR SHALL INFORM OWNER AND LOST WEST IMMEDIATELY SHOULD DISCREPANCIES BETWEEN THE PLANS AND ACTUAL SITE CONDITIONS BE DISCOVERED WHICH HAVE A NEGATIVE EFFECT ON THE DESIGN OR IT'S IMPLEMENTATION.

JOB-SITE CONDITIONS


CONTRACTOR SHALL MAINTAIN JOB-SITE IN A WEED FREE STATE DURING CONSTRUCTION AND THE MAINTENANCE PERIOD BY USE OF ROUND-UP OR EQUAL NON-SELECTIVE HERBICIDE. CONTRACTOR SHALL KEEP SITE NEAT AND FREE OF CONSTRUCTION DEBRIS AND UNNEEDED EQUIPMENT AT ALL TIMES.

SPECIFICATIONS & STANDARD PLANS

ALL WORK ILLUSTRATED IN THE PUBLIC RIGHT-OF-WAY IN THESE PLANS SHALL BE INSTALLED IN ACCORDANCE WITH THE STANDARD SPECIFICATIONS FOR PUBLIC WORKS CONSTRUCTION, LATEST EDITION, THE STANDARD PLANS FOR PUBLIC WORKS CONSTRUCTION, LATEST EDITION, AND ANY RELEVANT CITY AND REGIONAL STANDARD PLANS OR SPECIFICATIONS, IN ADDITION TO THE INFORMATION PROVIDED IN THE PLANS AND SPECIFICATIONS FOUND HEREIN.

VICINITY MAP -

NOT TO SCALE

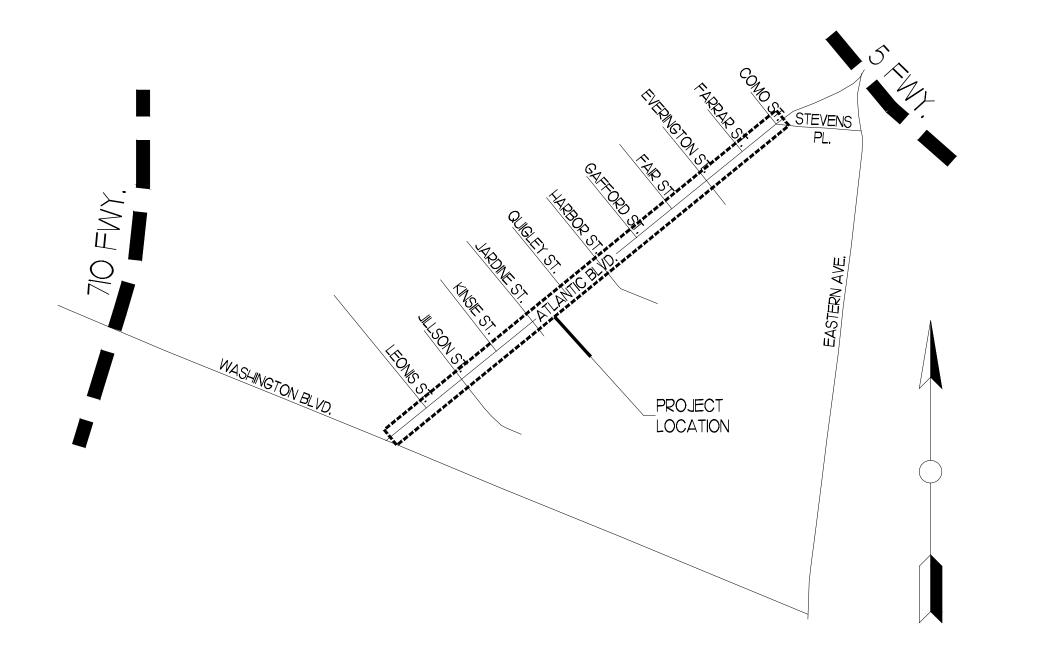

HYDRO-ZONE AREA CALCULATIONS -

HYDROZON	E INFORMATION TABLE			
HYDRO- ZONE	VALVE NO.'S	IRRIGATION METHOD	HYDROZONE AREA	% OF LANDSCAPE AREA
I - LOW	A2,4, B2,4,5, C2,3,4, Dl,3,6,7, E3,4,5	DRIP	9,145 SF	69%

DRIP & BUBBLER | 4,110 SF | 31%

LANDSCAPE SHEET INDEX


2 - MOD | Al,3, Bl,3, Cl, D2,4,5,8, El,2

SHEET NO. SHEET NAME LANDSCAPE TITLE SHEET LOI OF 10 LO2 - LO4 OF 10 PLANTING PLANS & DETAILS LO5 - LO7 OF 10 IRRIGATION PLANS & DETAILS LO8 - LIO OF 10 LIGHTING PLANS & DETAILS

Underground Service Alert Call: TOLL FREE TWO WORKING DAYS BEFORE YOU DIG



NO.	REVISIONS	REV. BY	APP. B	Y DATE	PLAN DATE:
					09/14/18
					PLOTTING HISTORY: 07/10/18 - Version 1 09/06/18 - Version 2 09/14/18 - Version 3
					PROJECT FILE NO NAME: 1812 - Atlantic Blvd. Medians

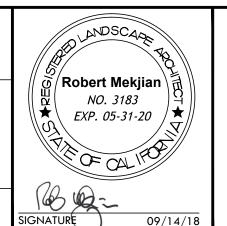

OST WEST A CALIFORNIA CORPORATION LANDSCAPE ARCHITECTURE GARDENS ♥ PARKS ♥ CITIES PO BOX 4548 Carlsbad, CA 92018 5208 Townsend Ave. Los Angeles, CA 90041

TEL: (760) 434-5790 OR (323) 258-8214

	ELECT	RONICALL	-Y	APPRO	OVED	BY:	
-	PUBLIC	WORKS	&	DEV.	SER'	VICES	DIRE
	ELECT	RONICALL	_Y	CHEC	KED	BY:	

CITY OF COMMERCE PUBLIC WORKS AND ENGINEERING DEPARTMENT ATLANTIC BOULEVARD CORRIDOR IMPROVEMENTS


LANDSCAPE TITLE SHEET


L-01


DRWG NO.


SHEET 01 OF 10 SHEETS


DATE

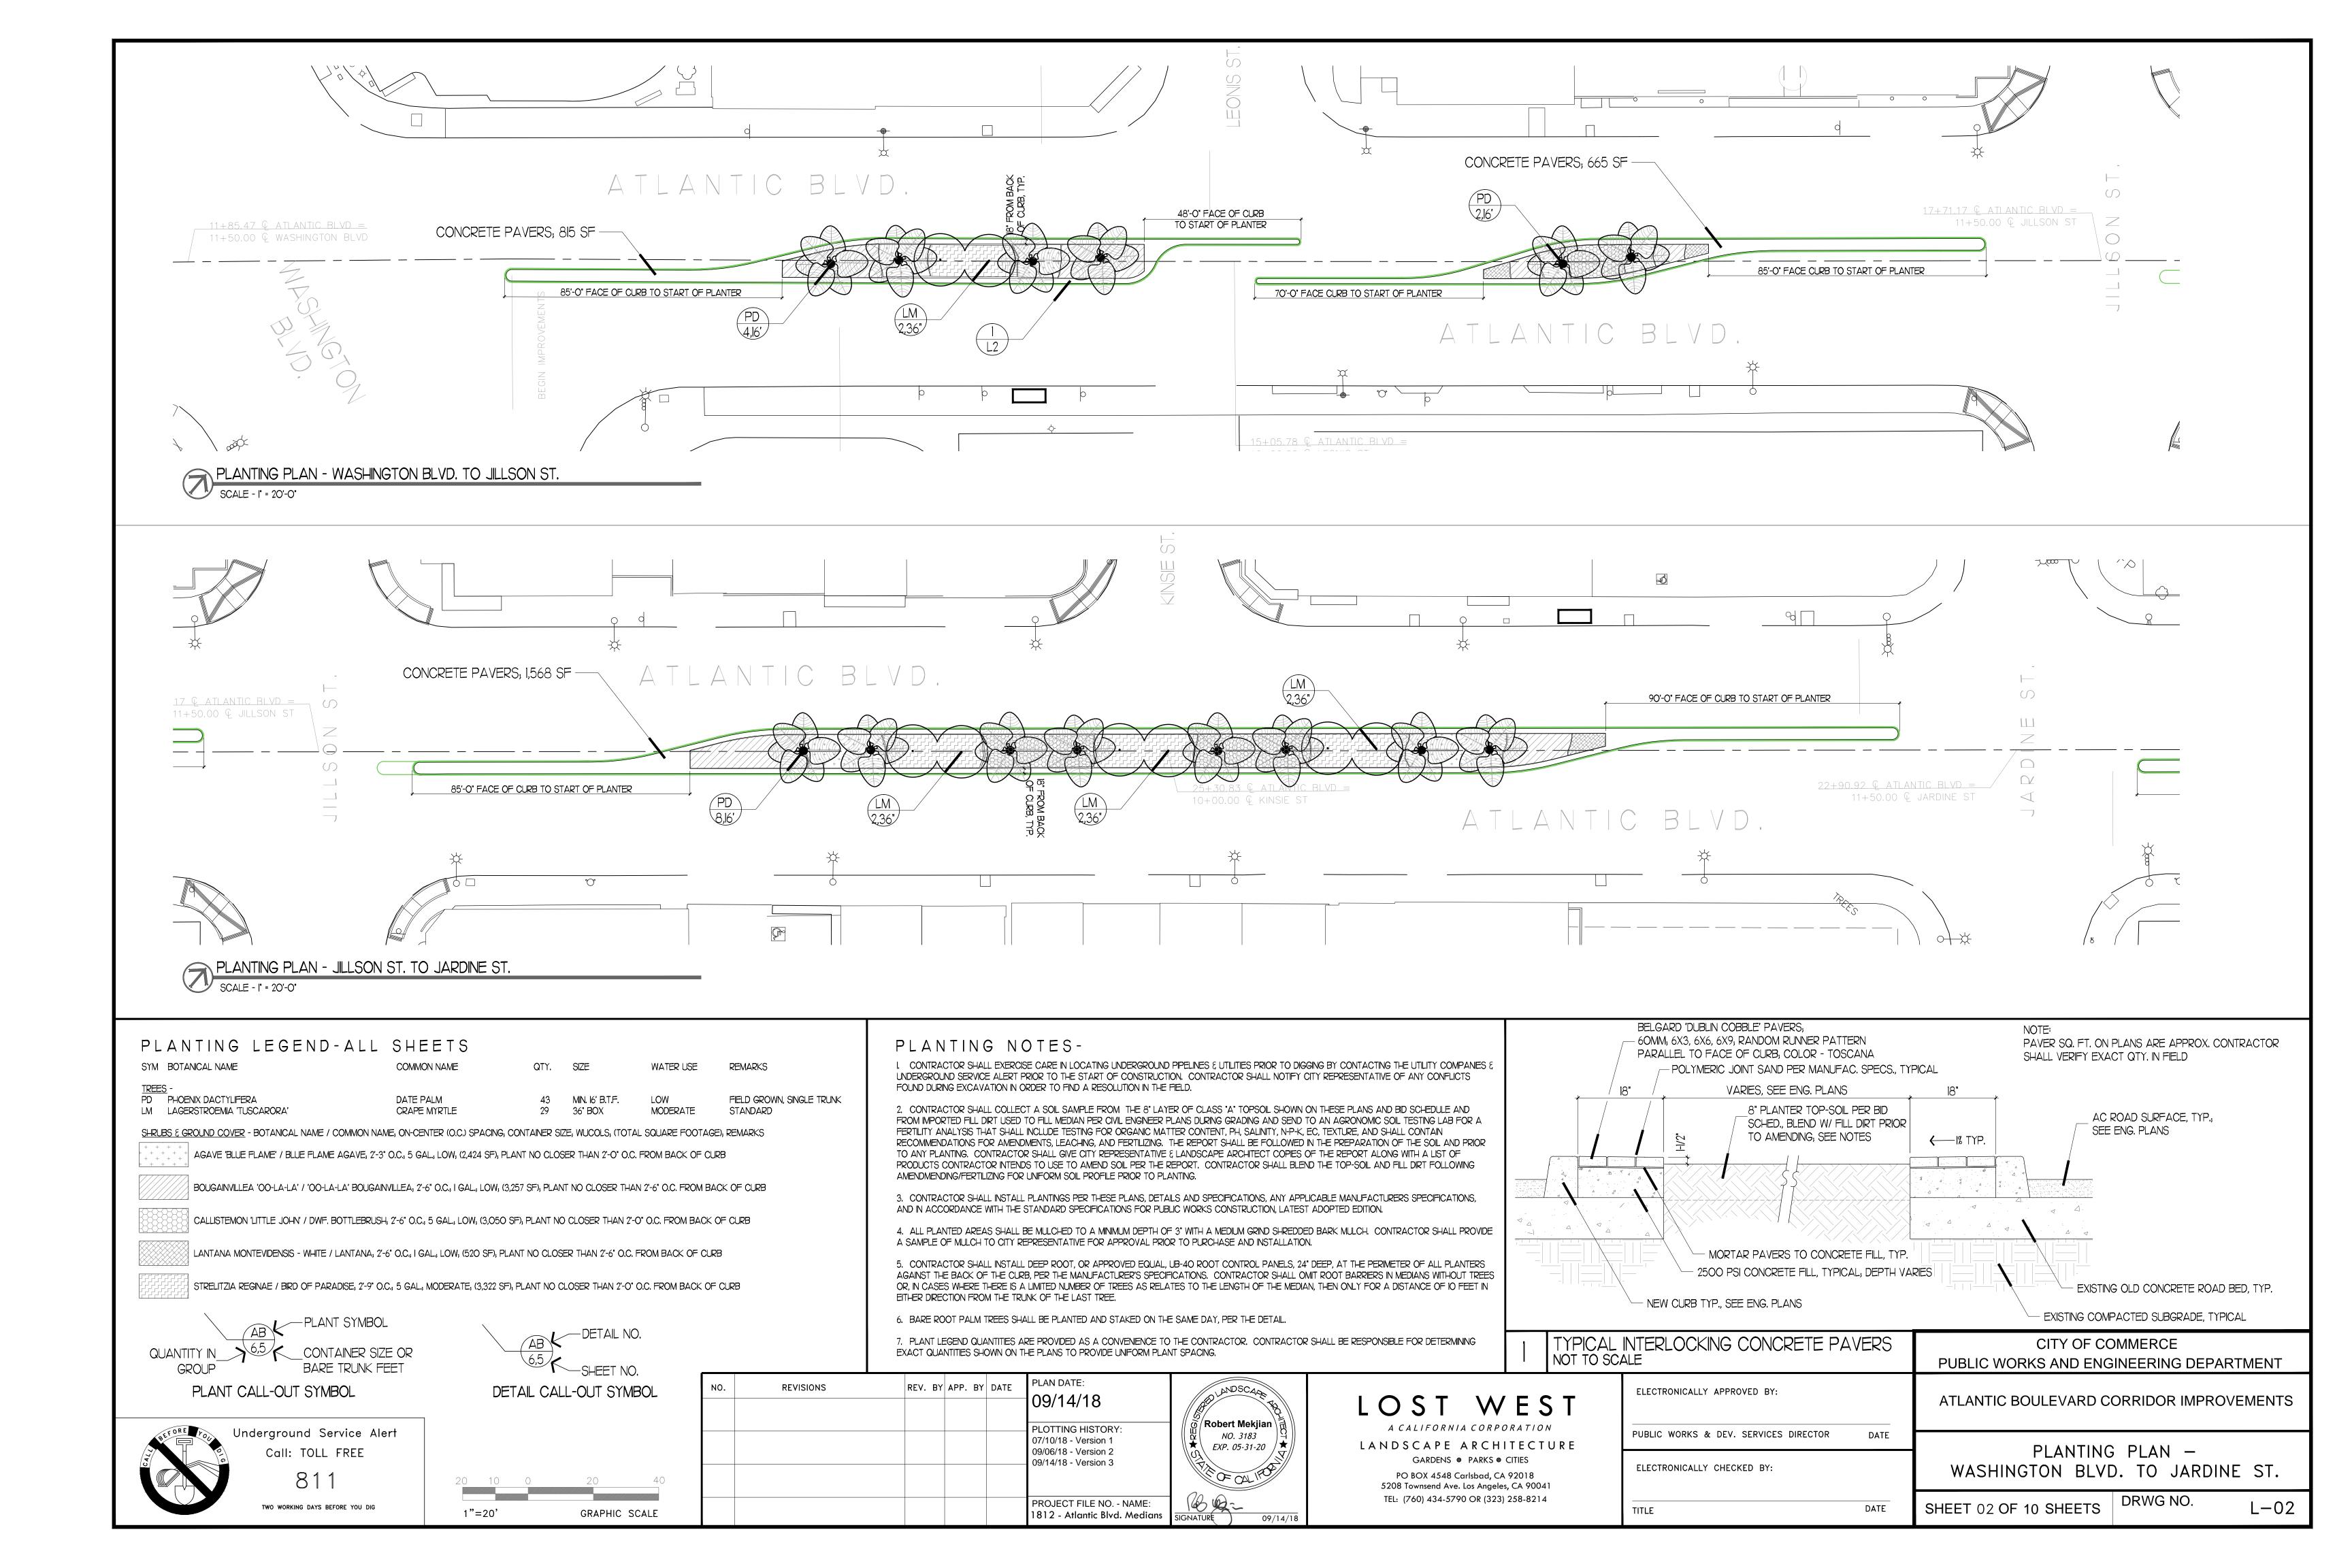


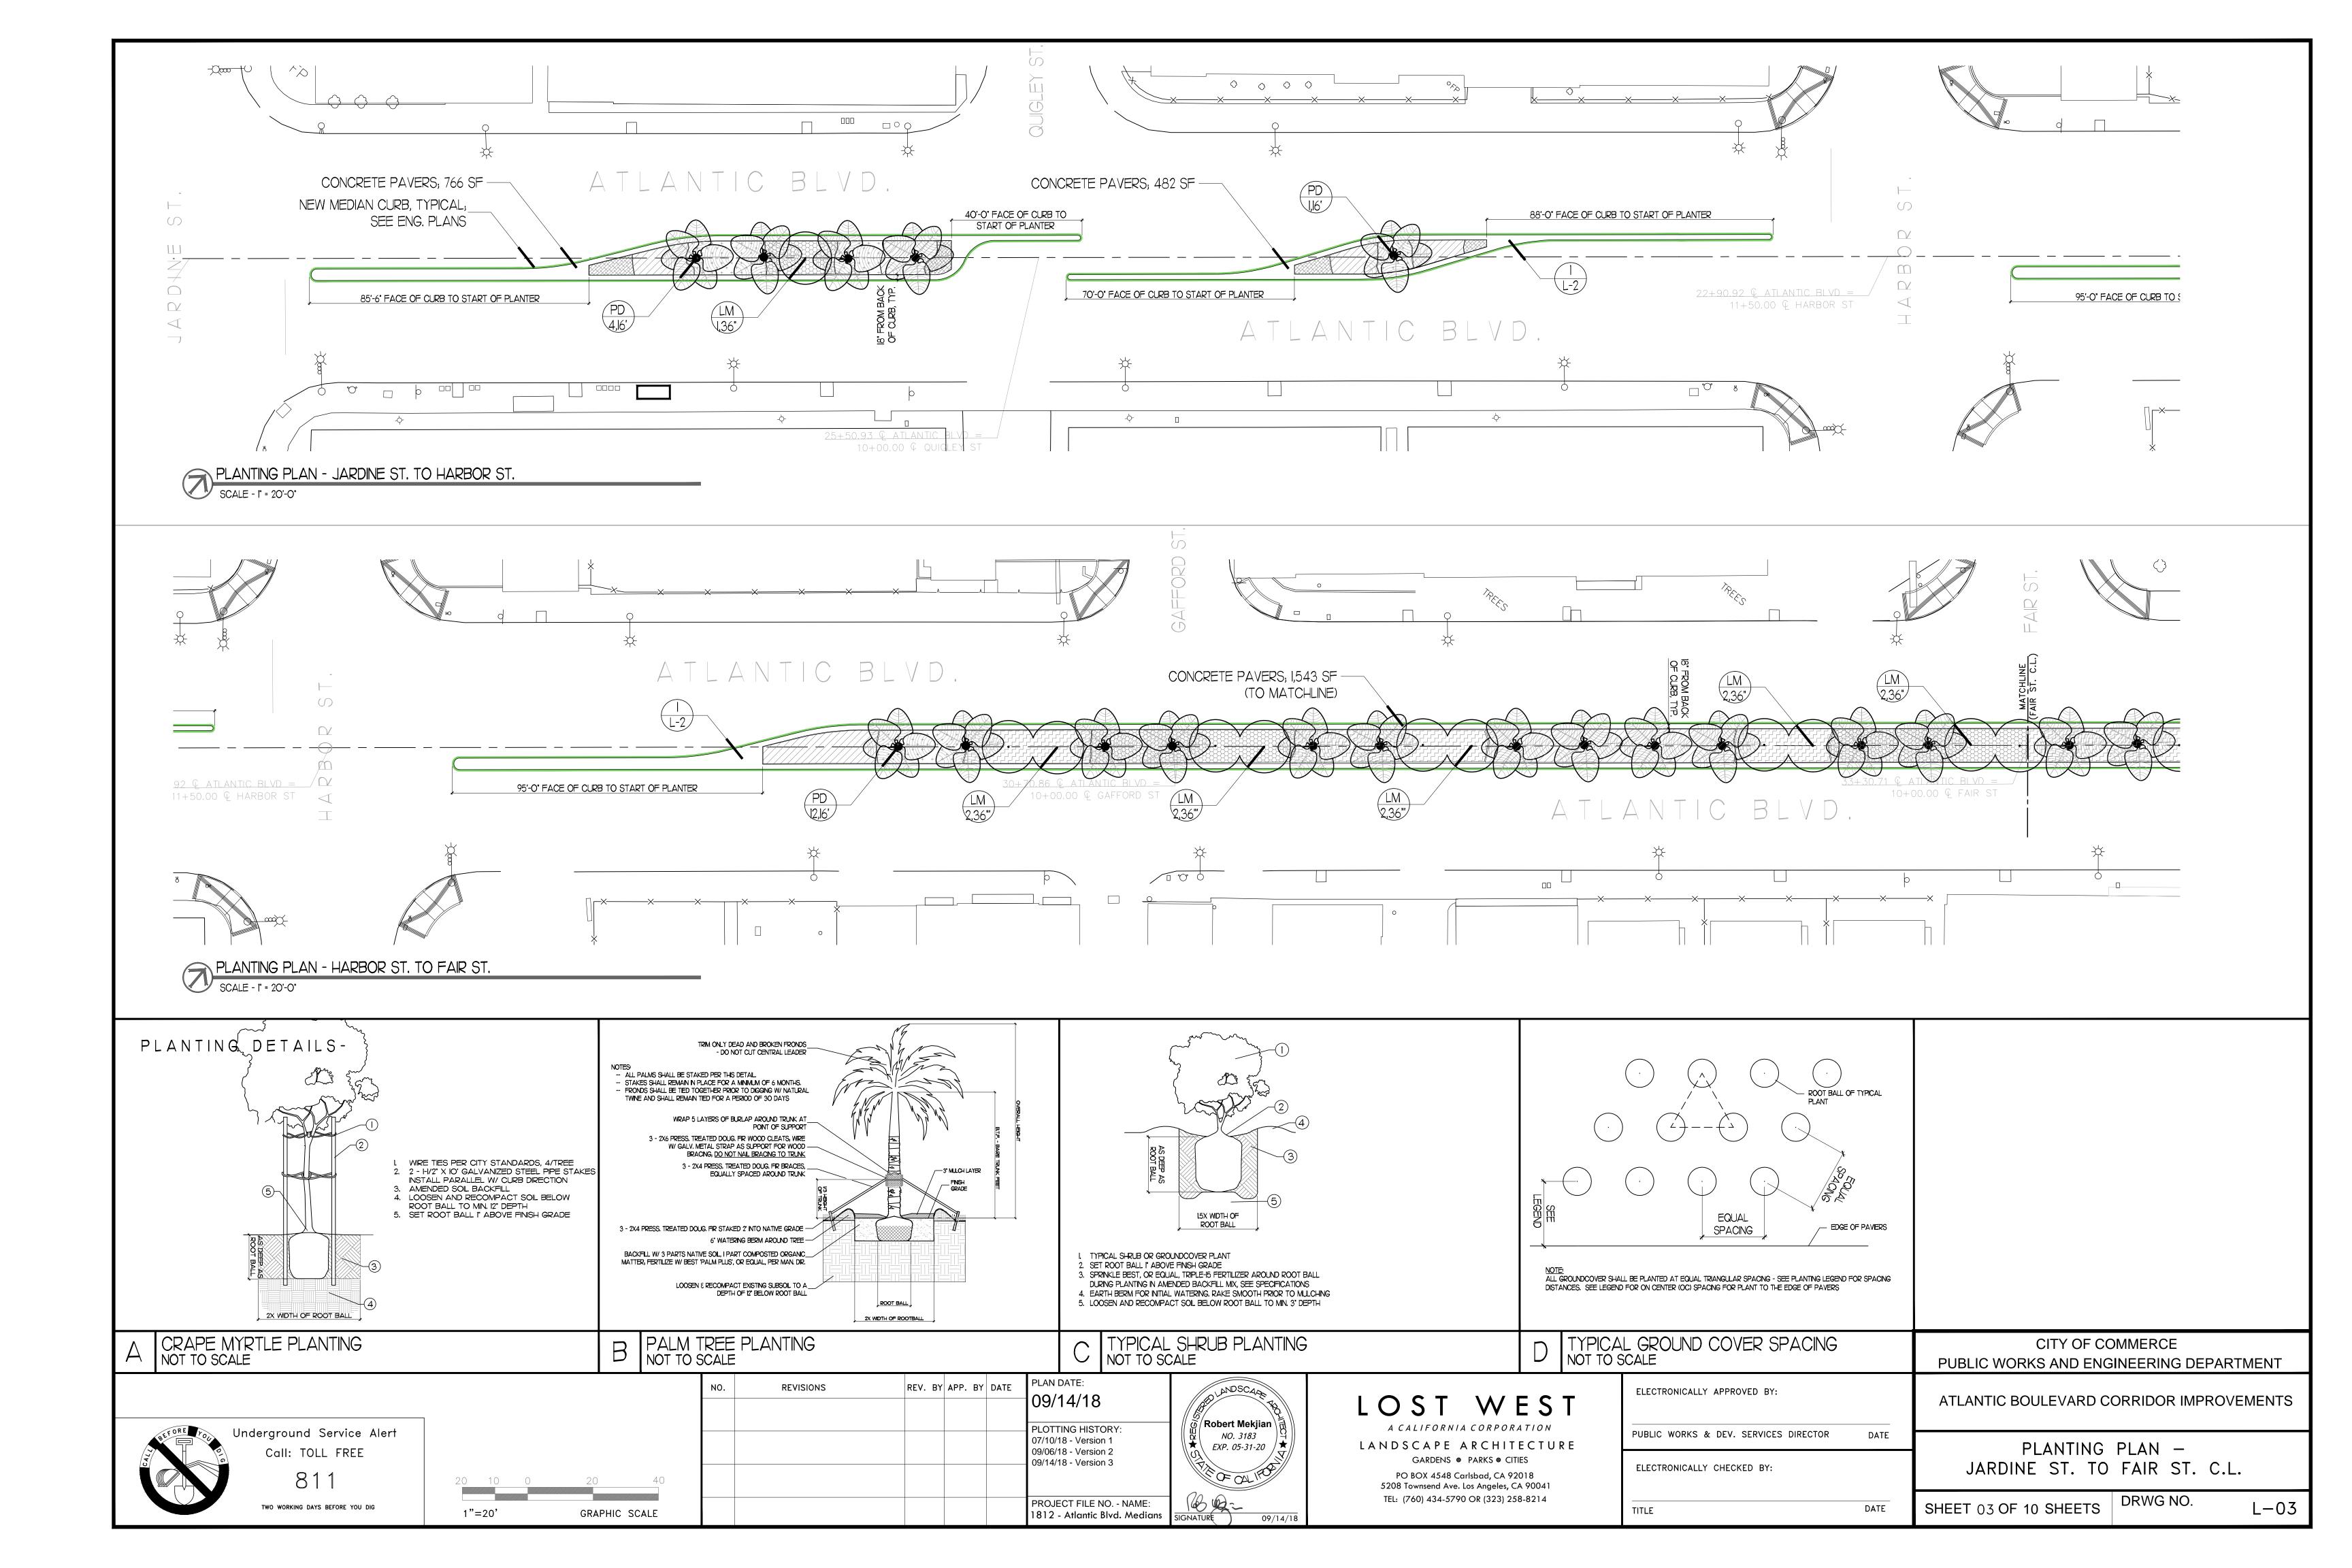


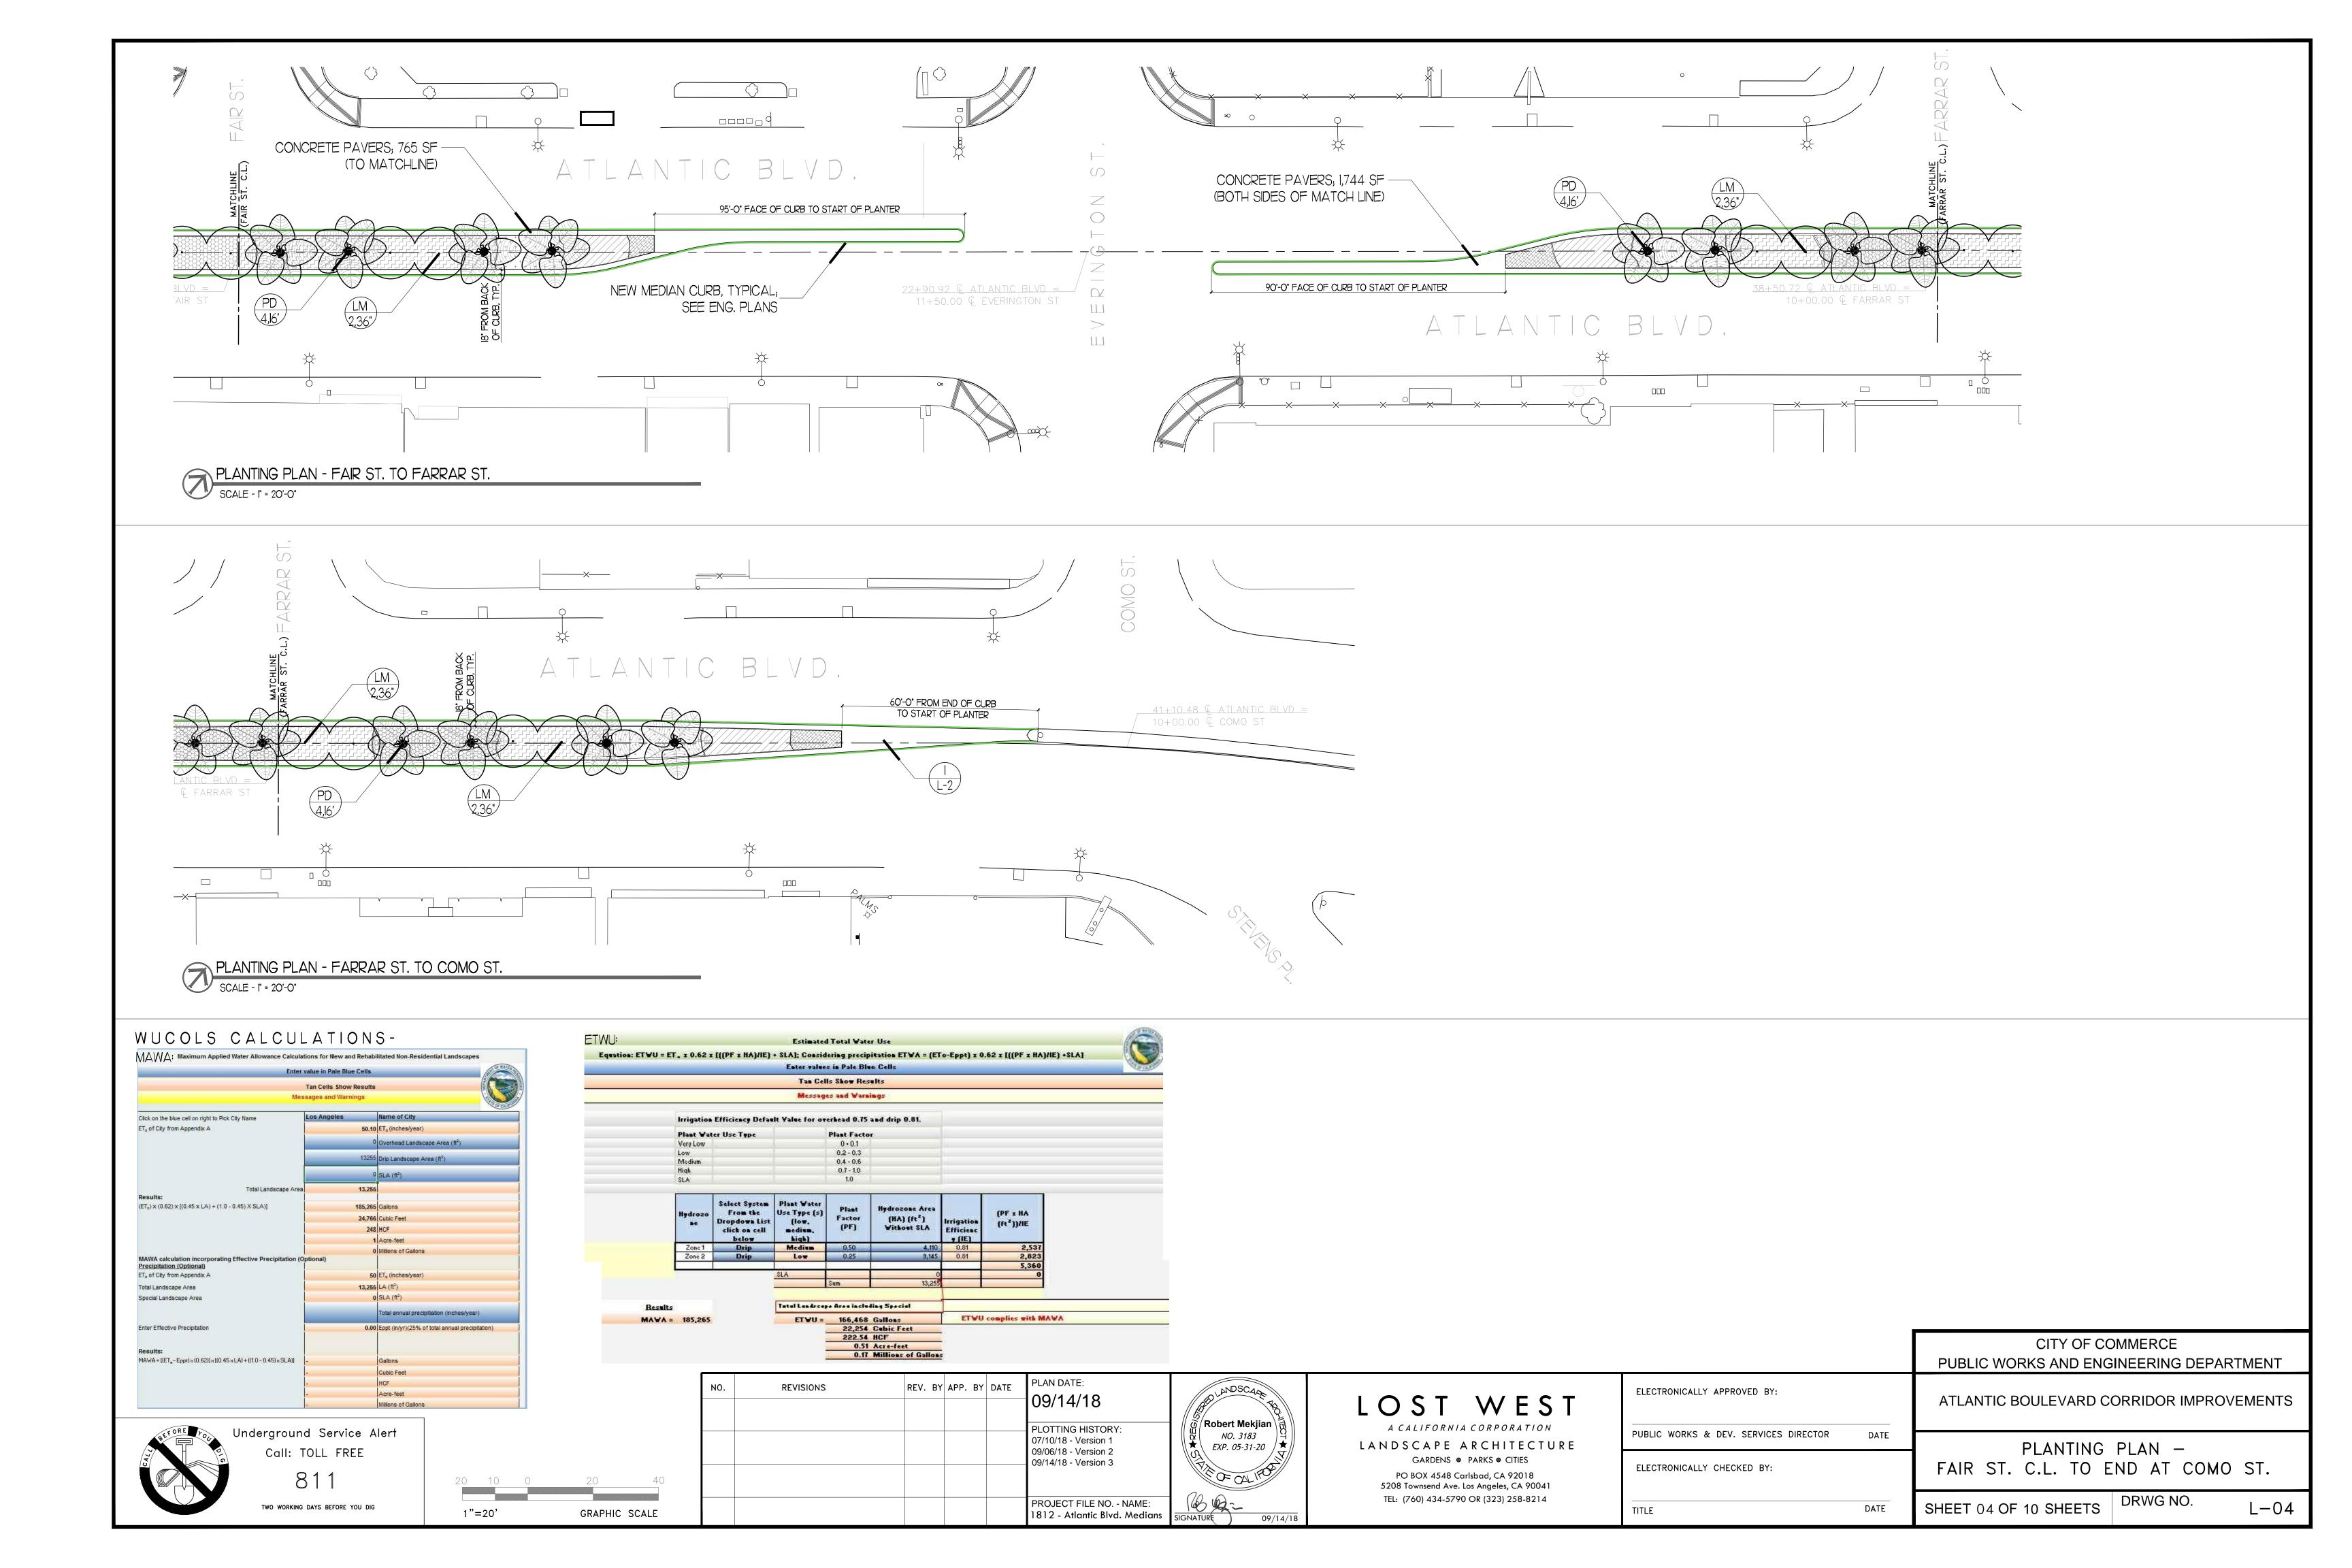


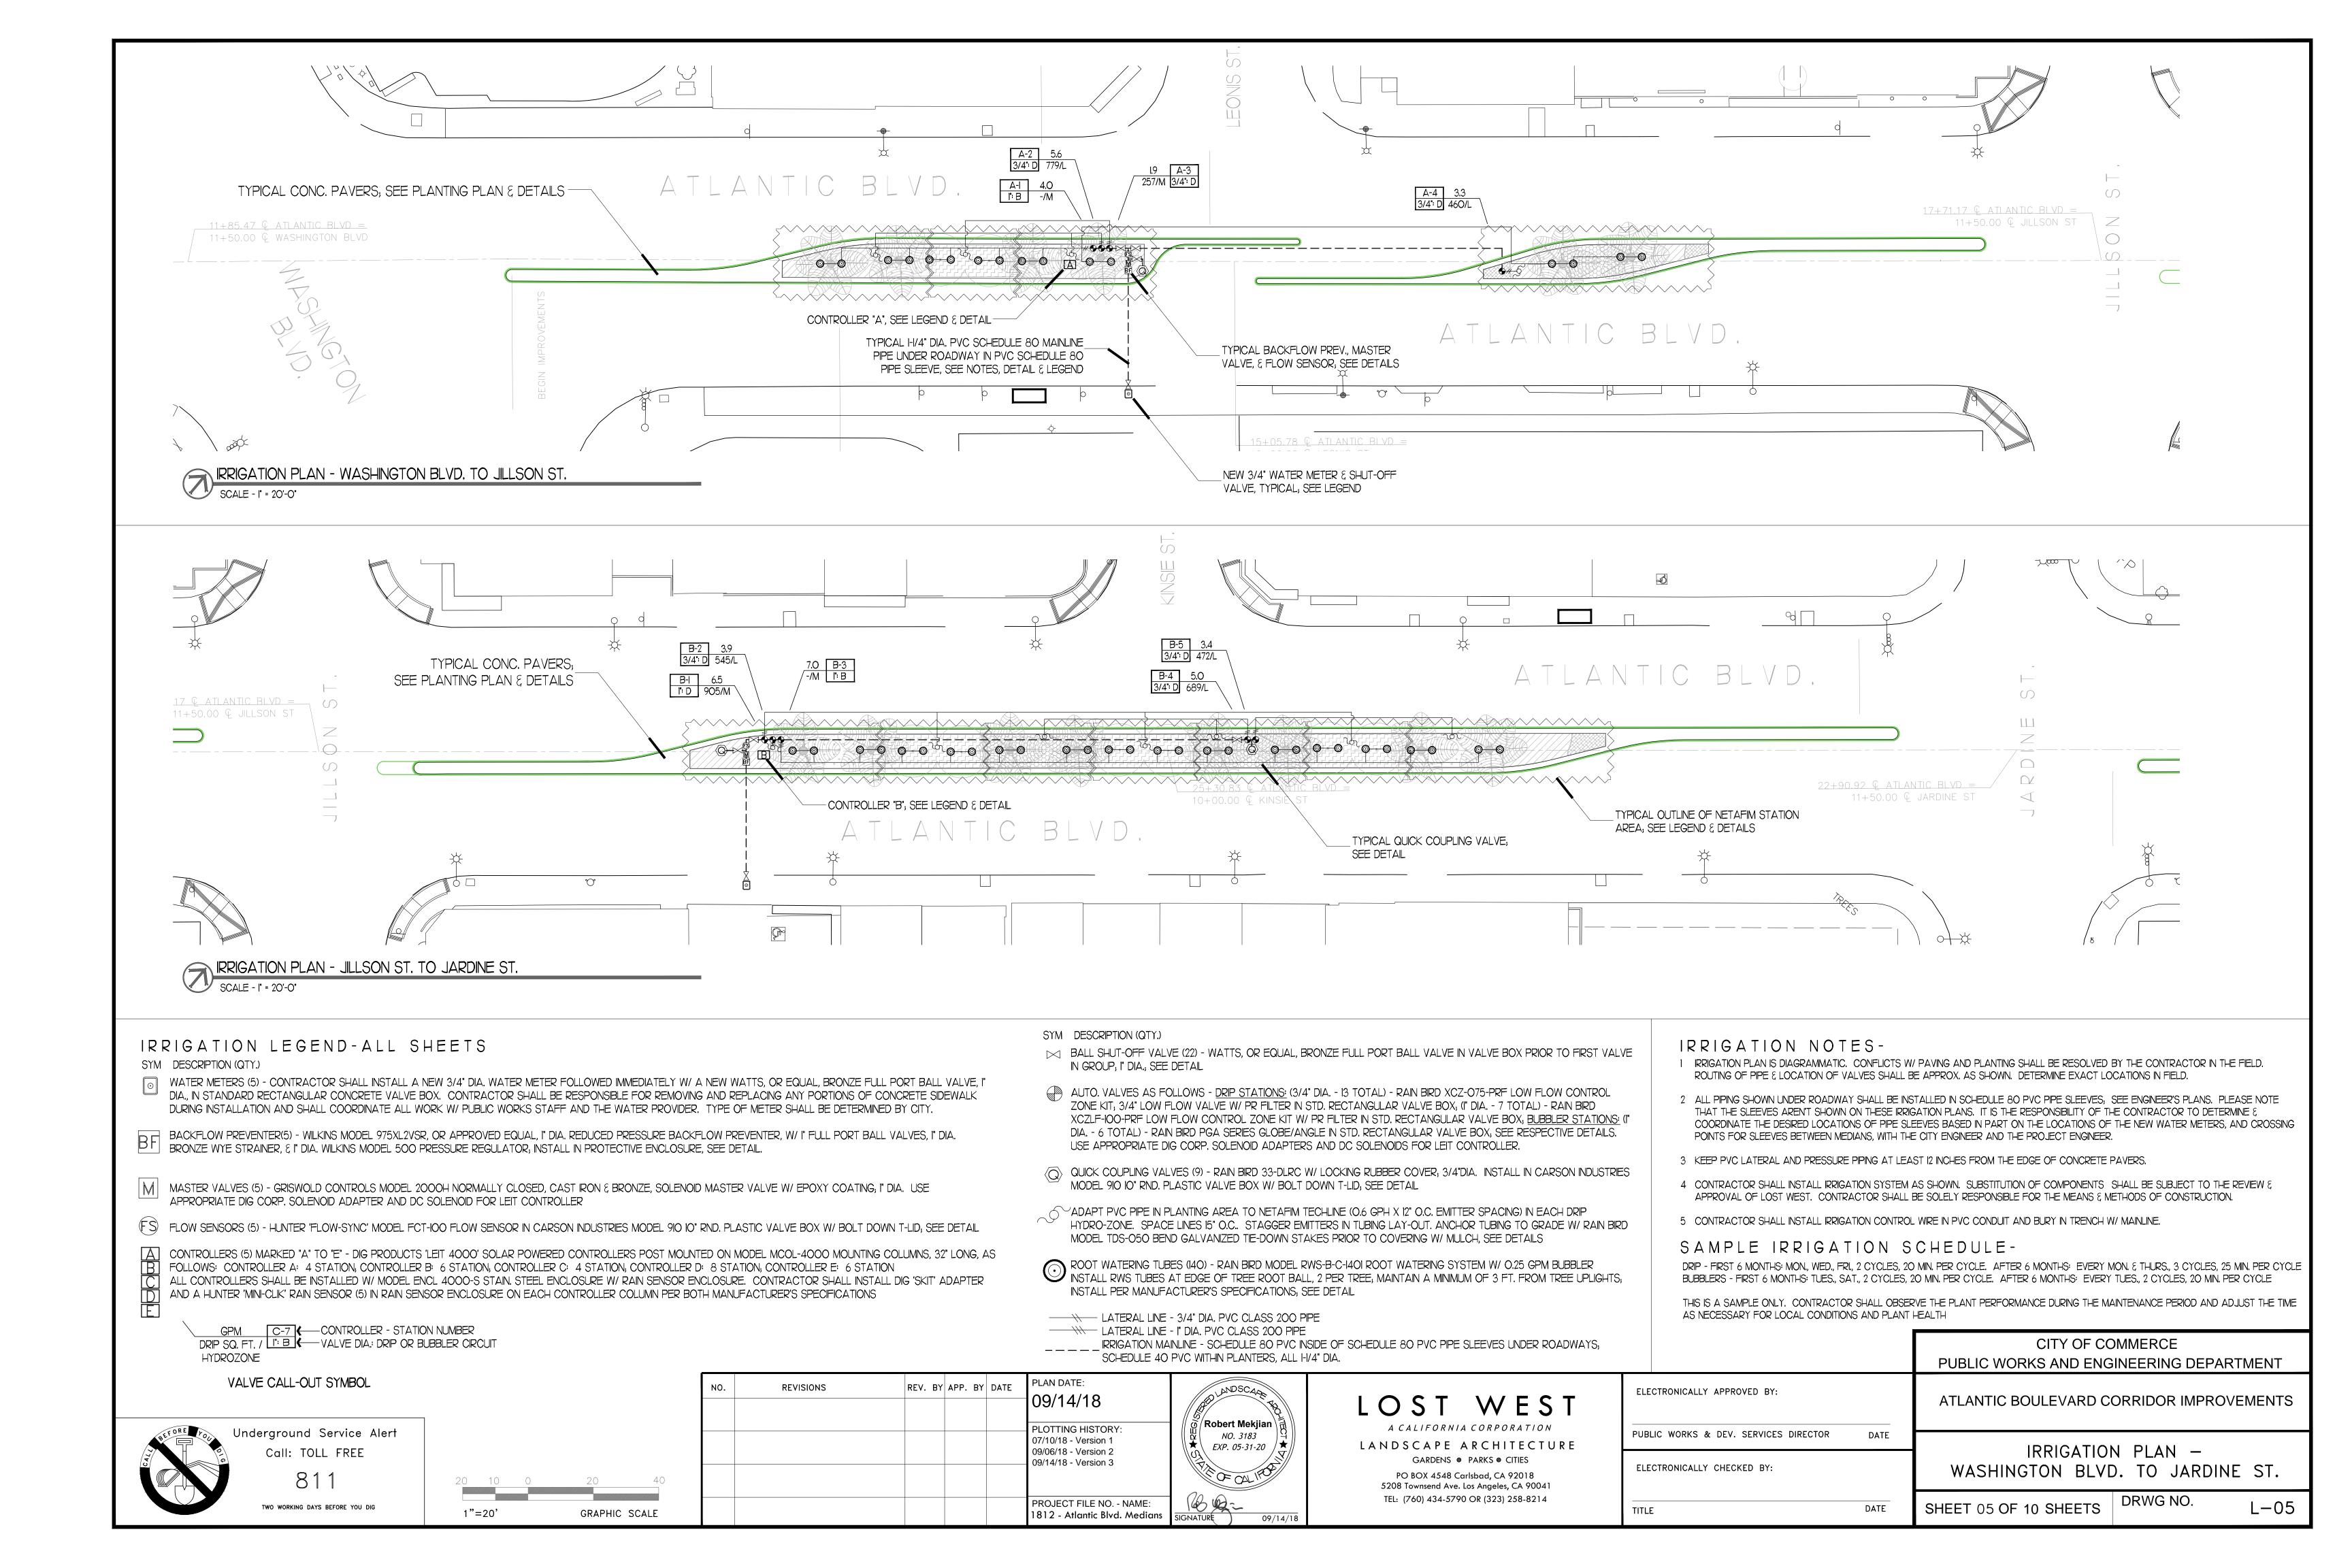


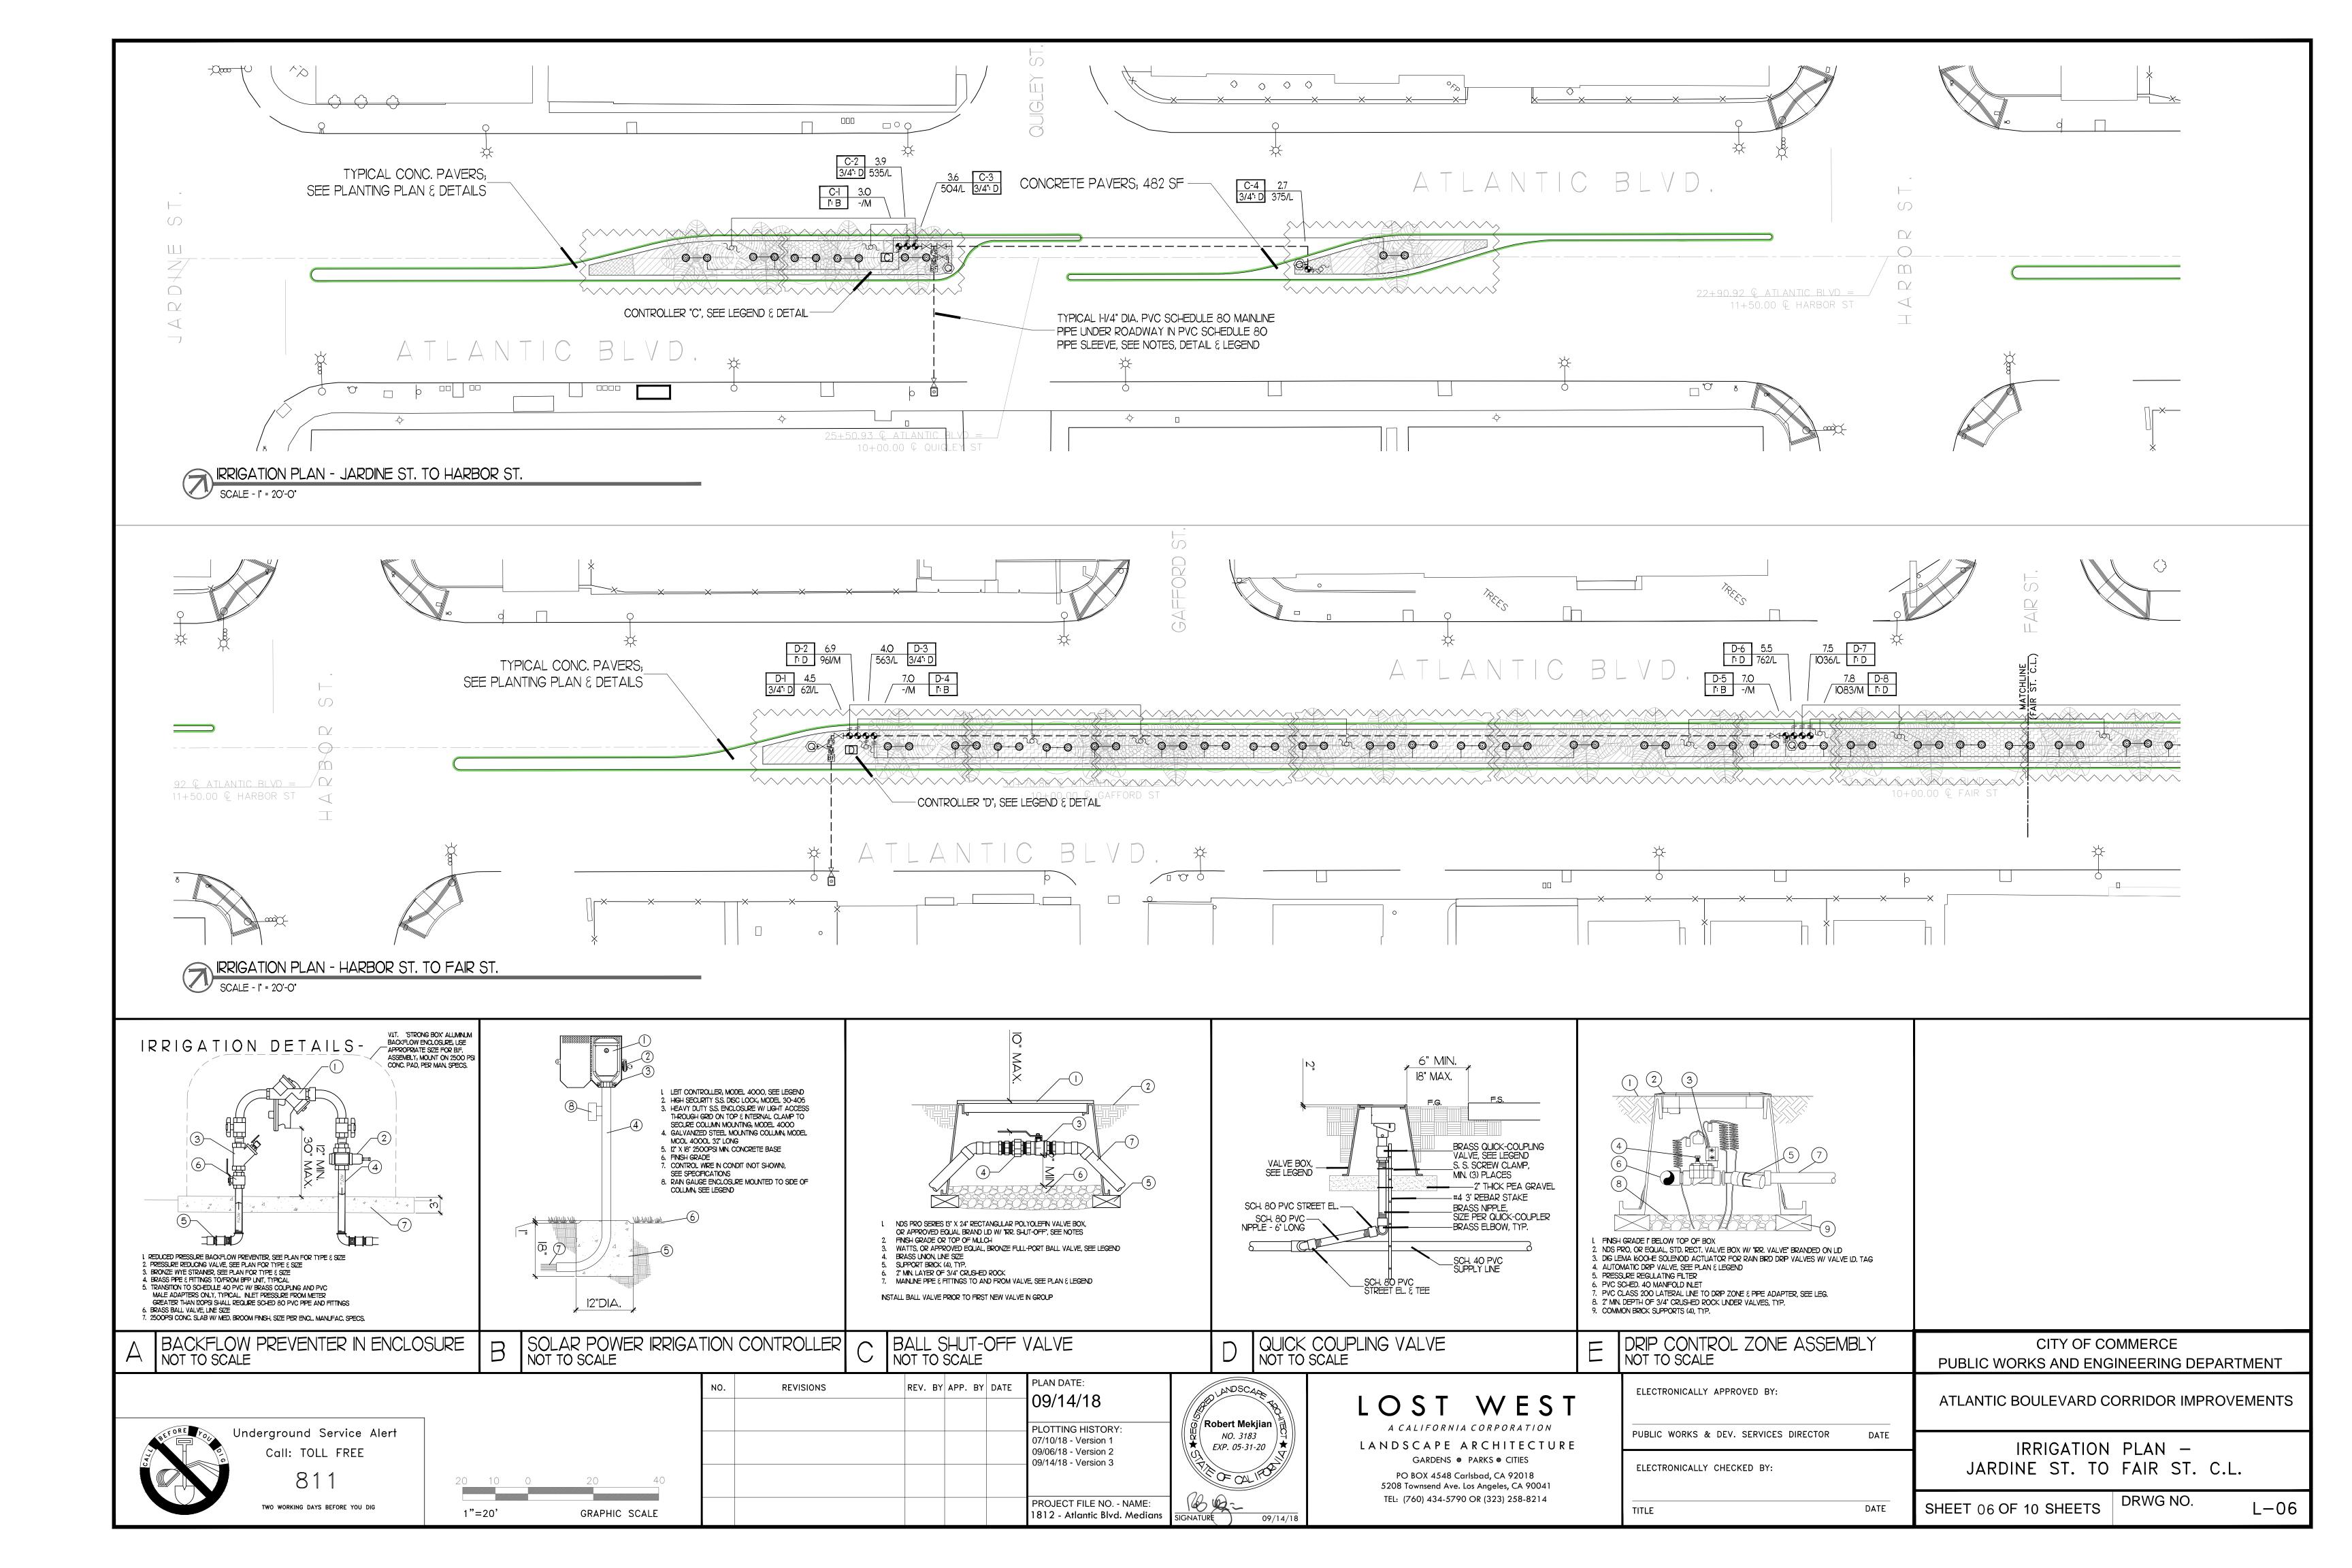

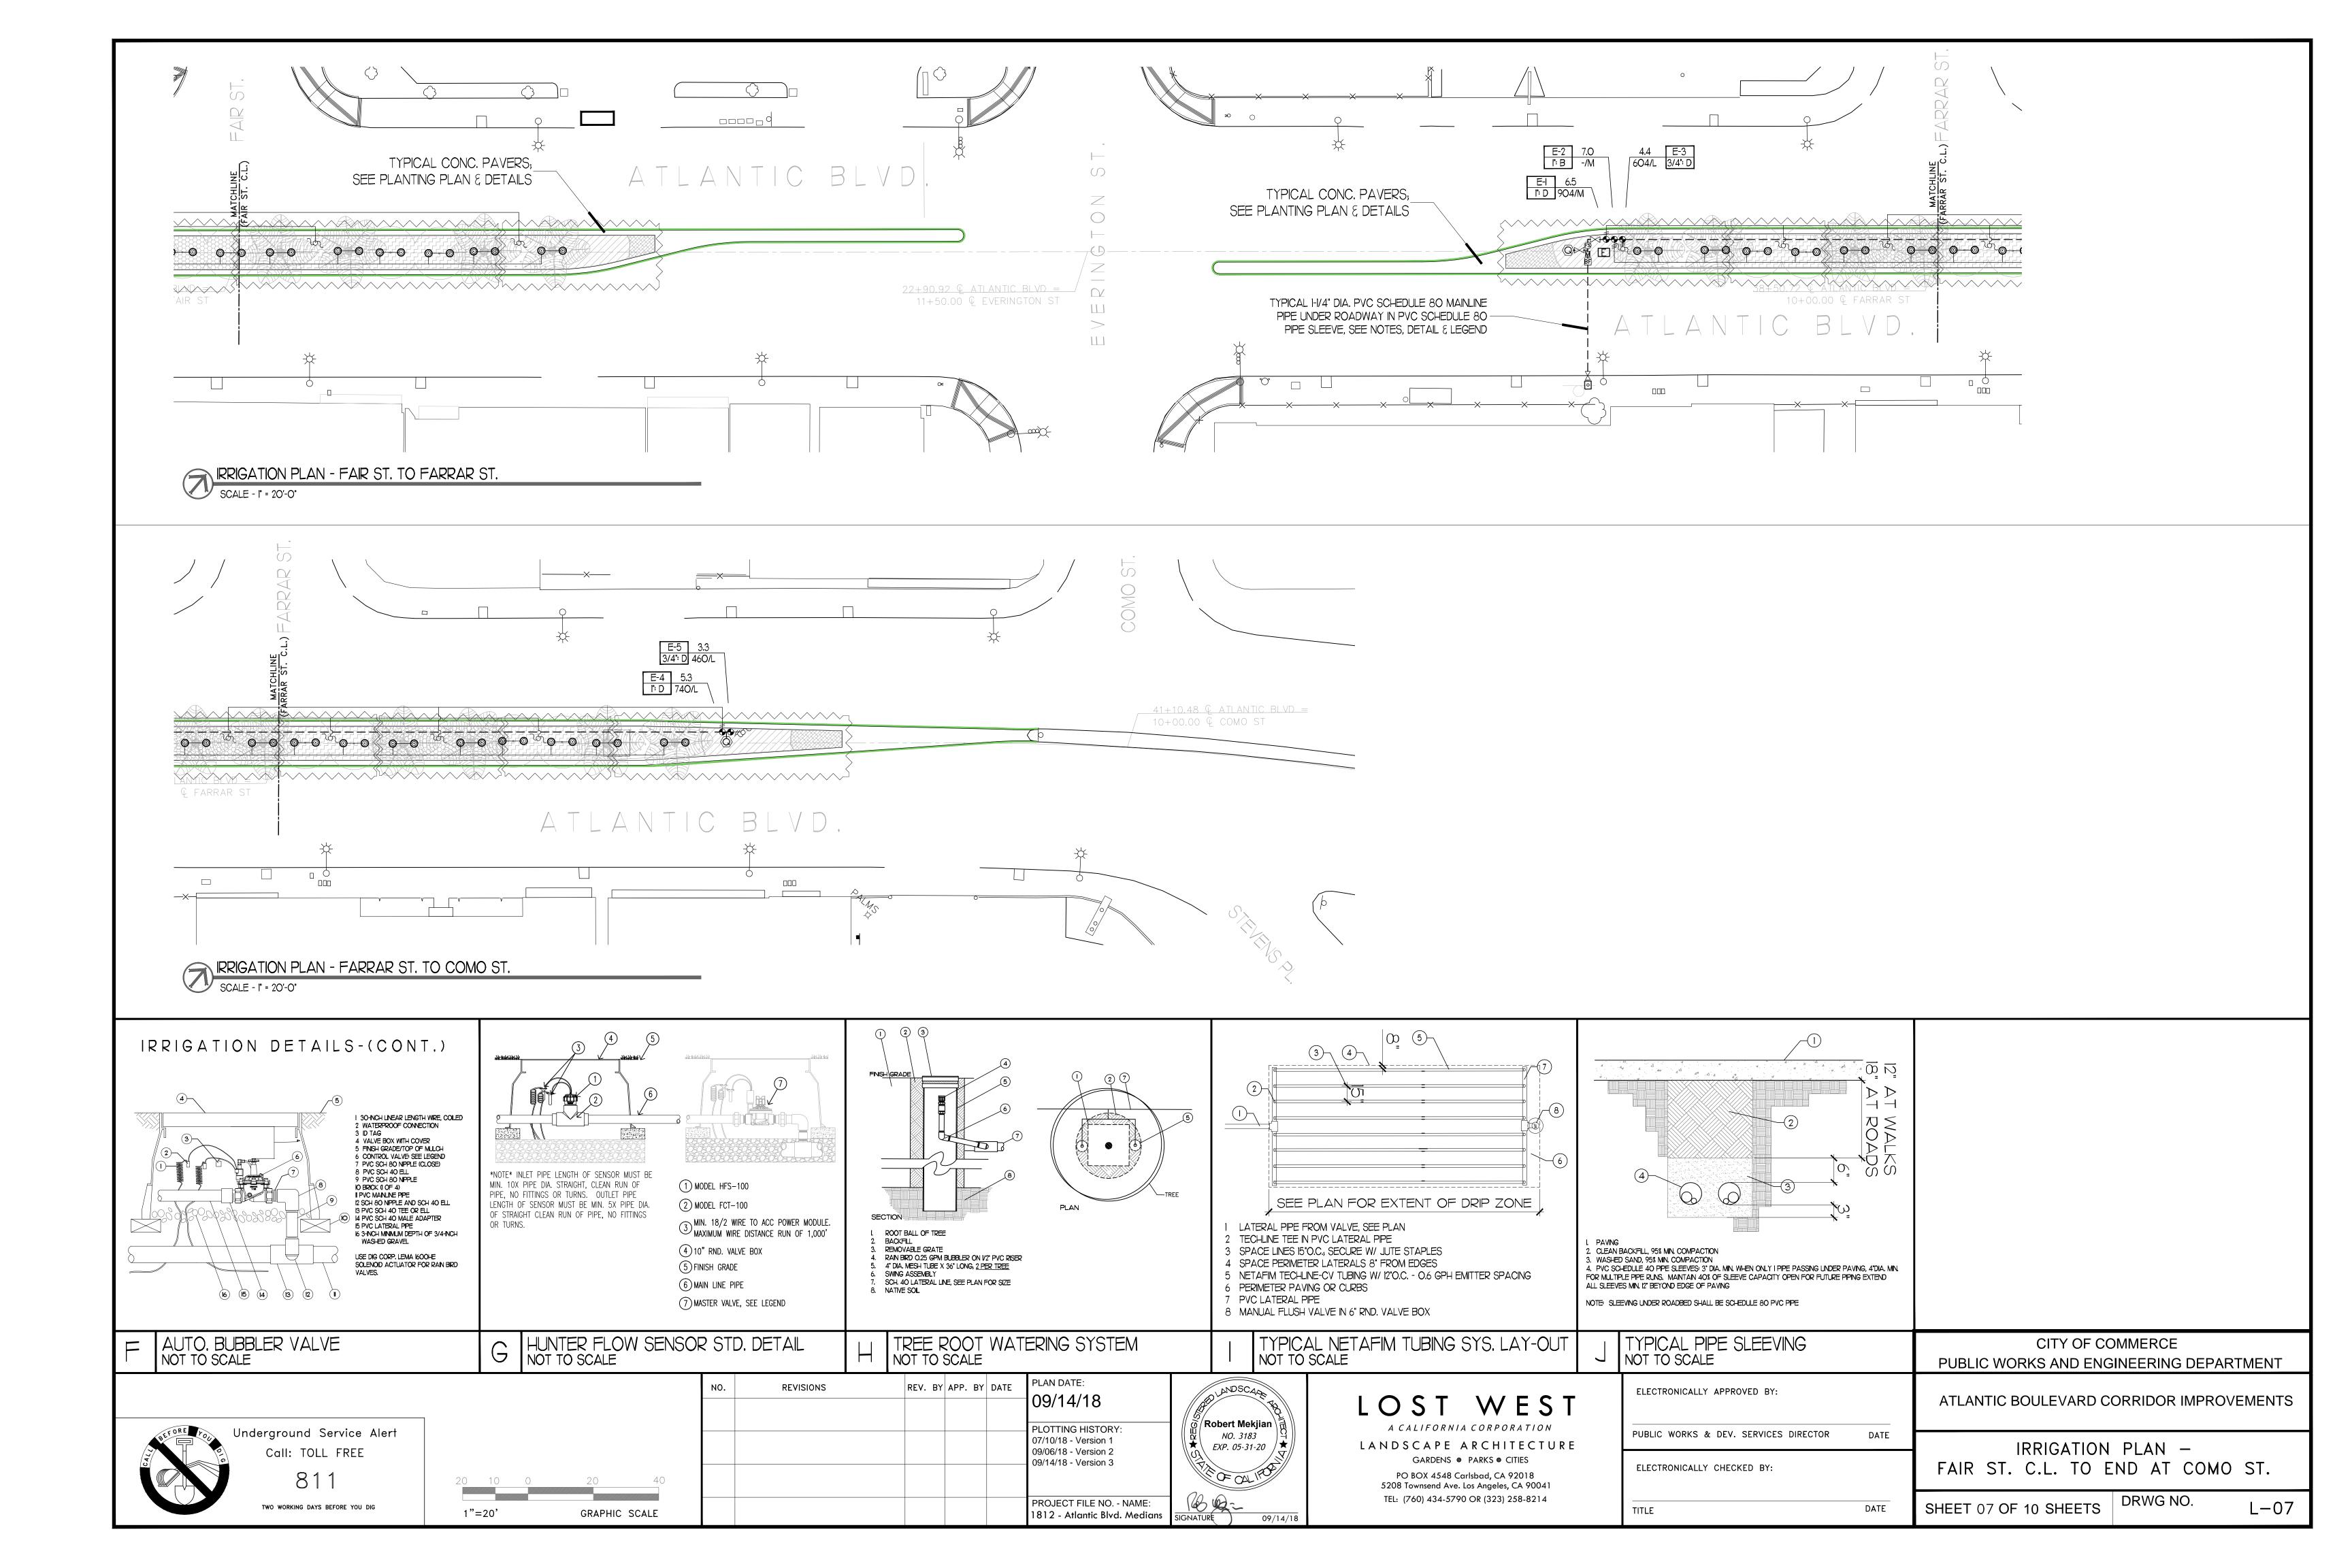

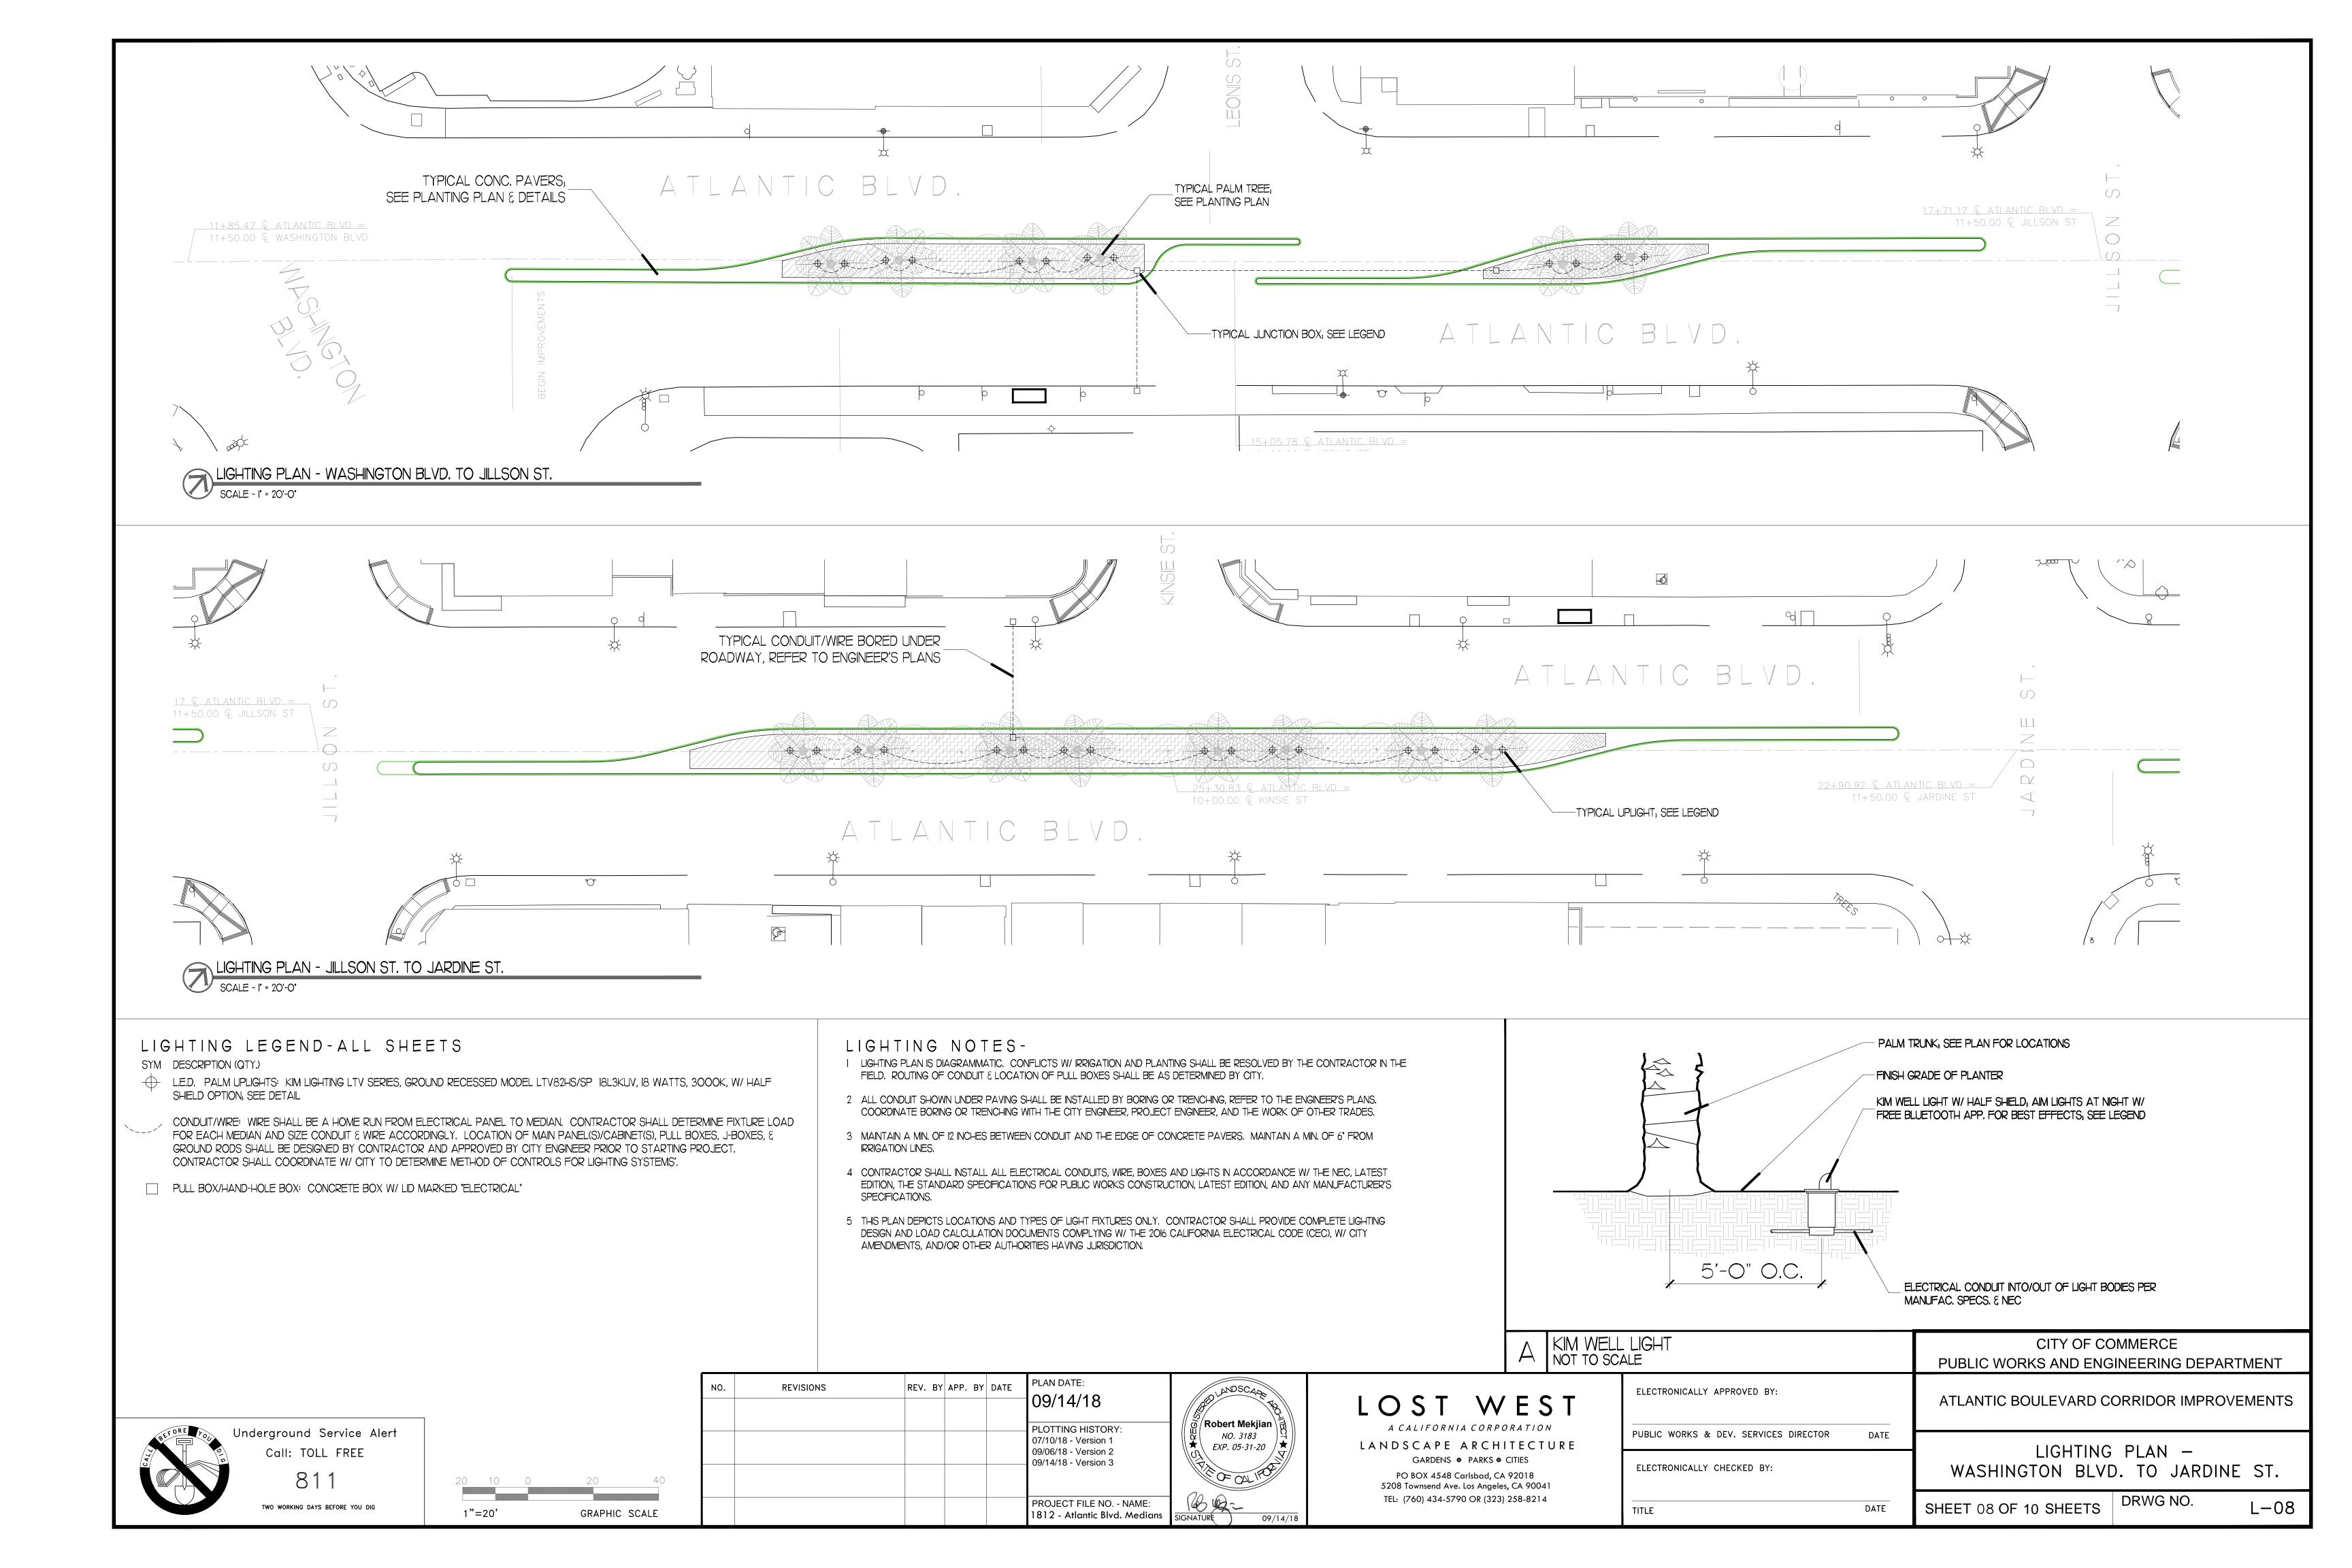

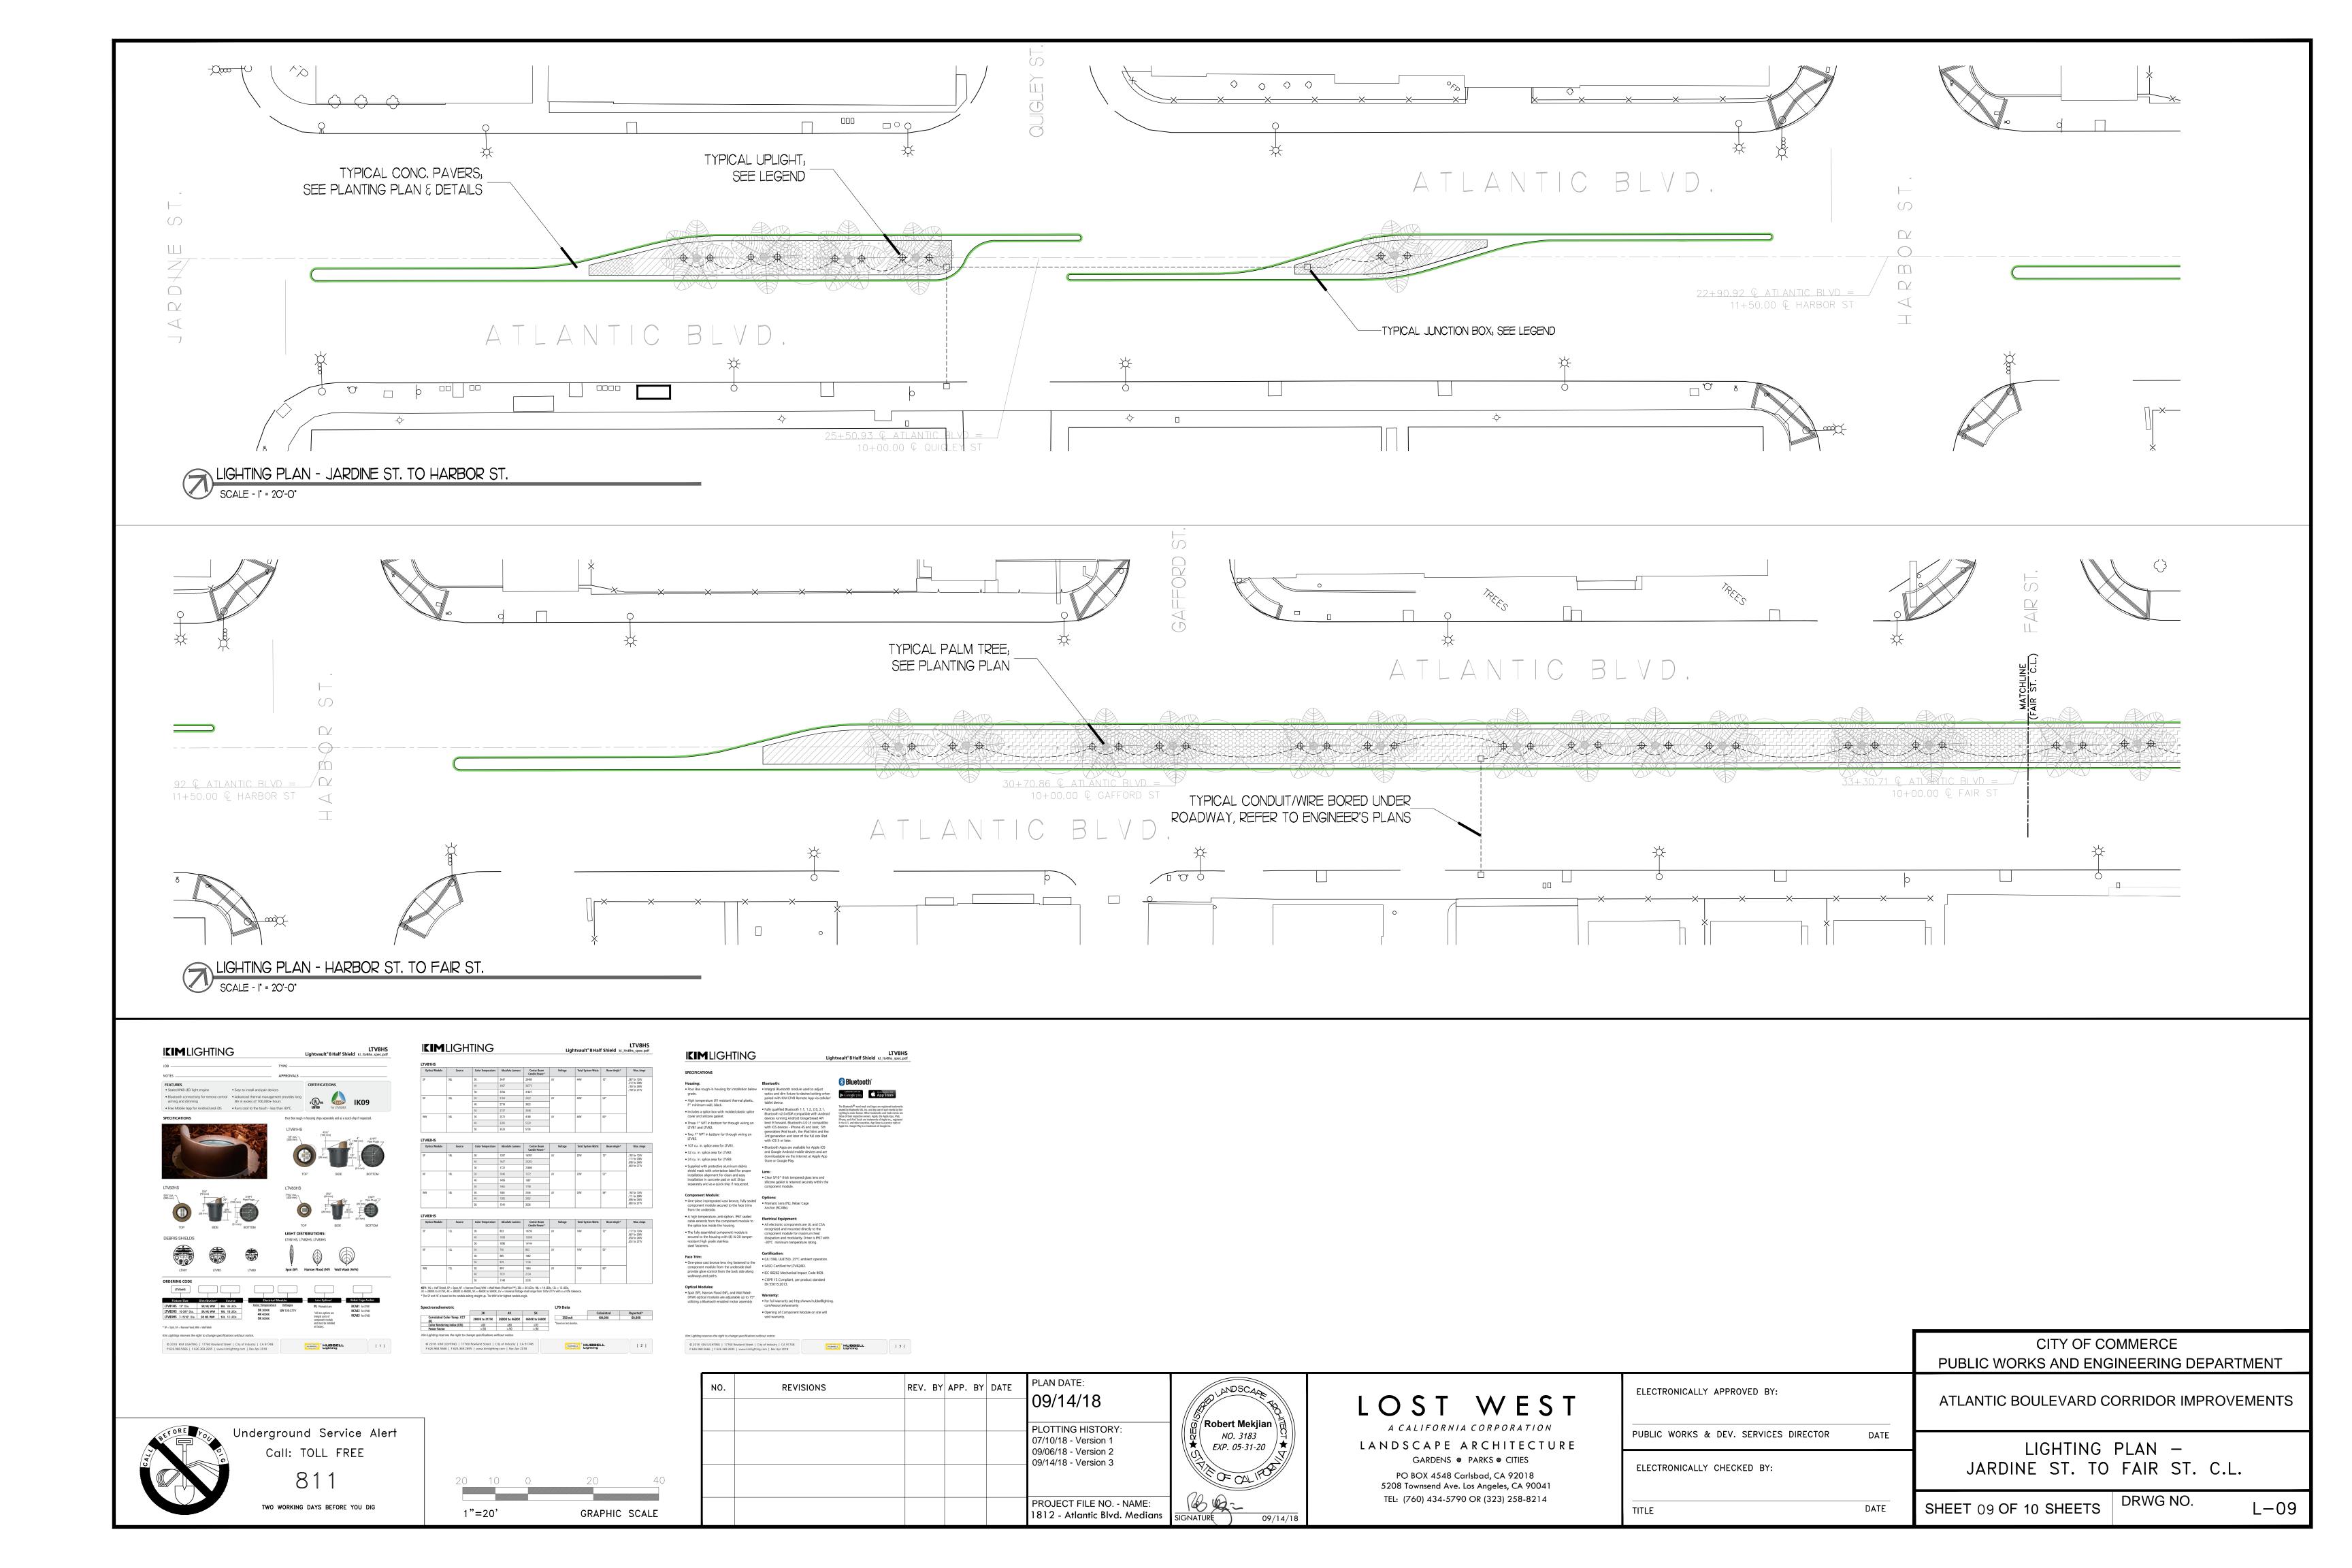

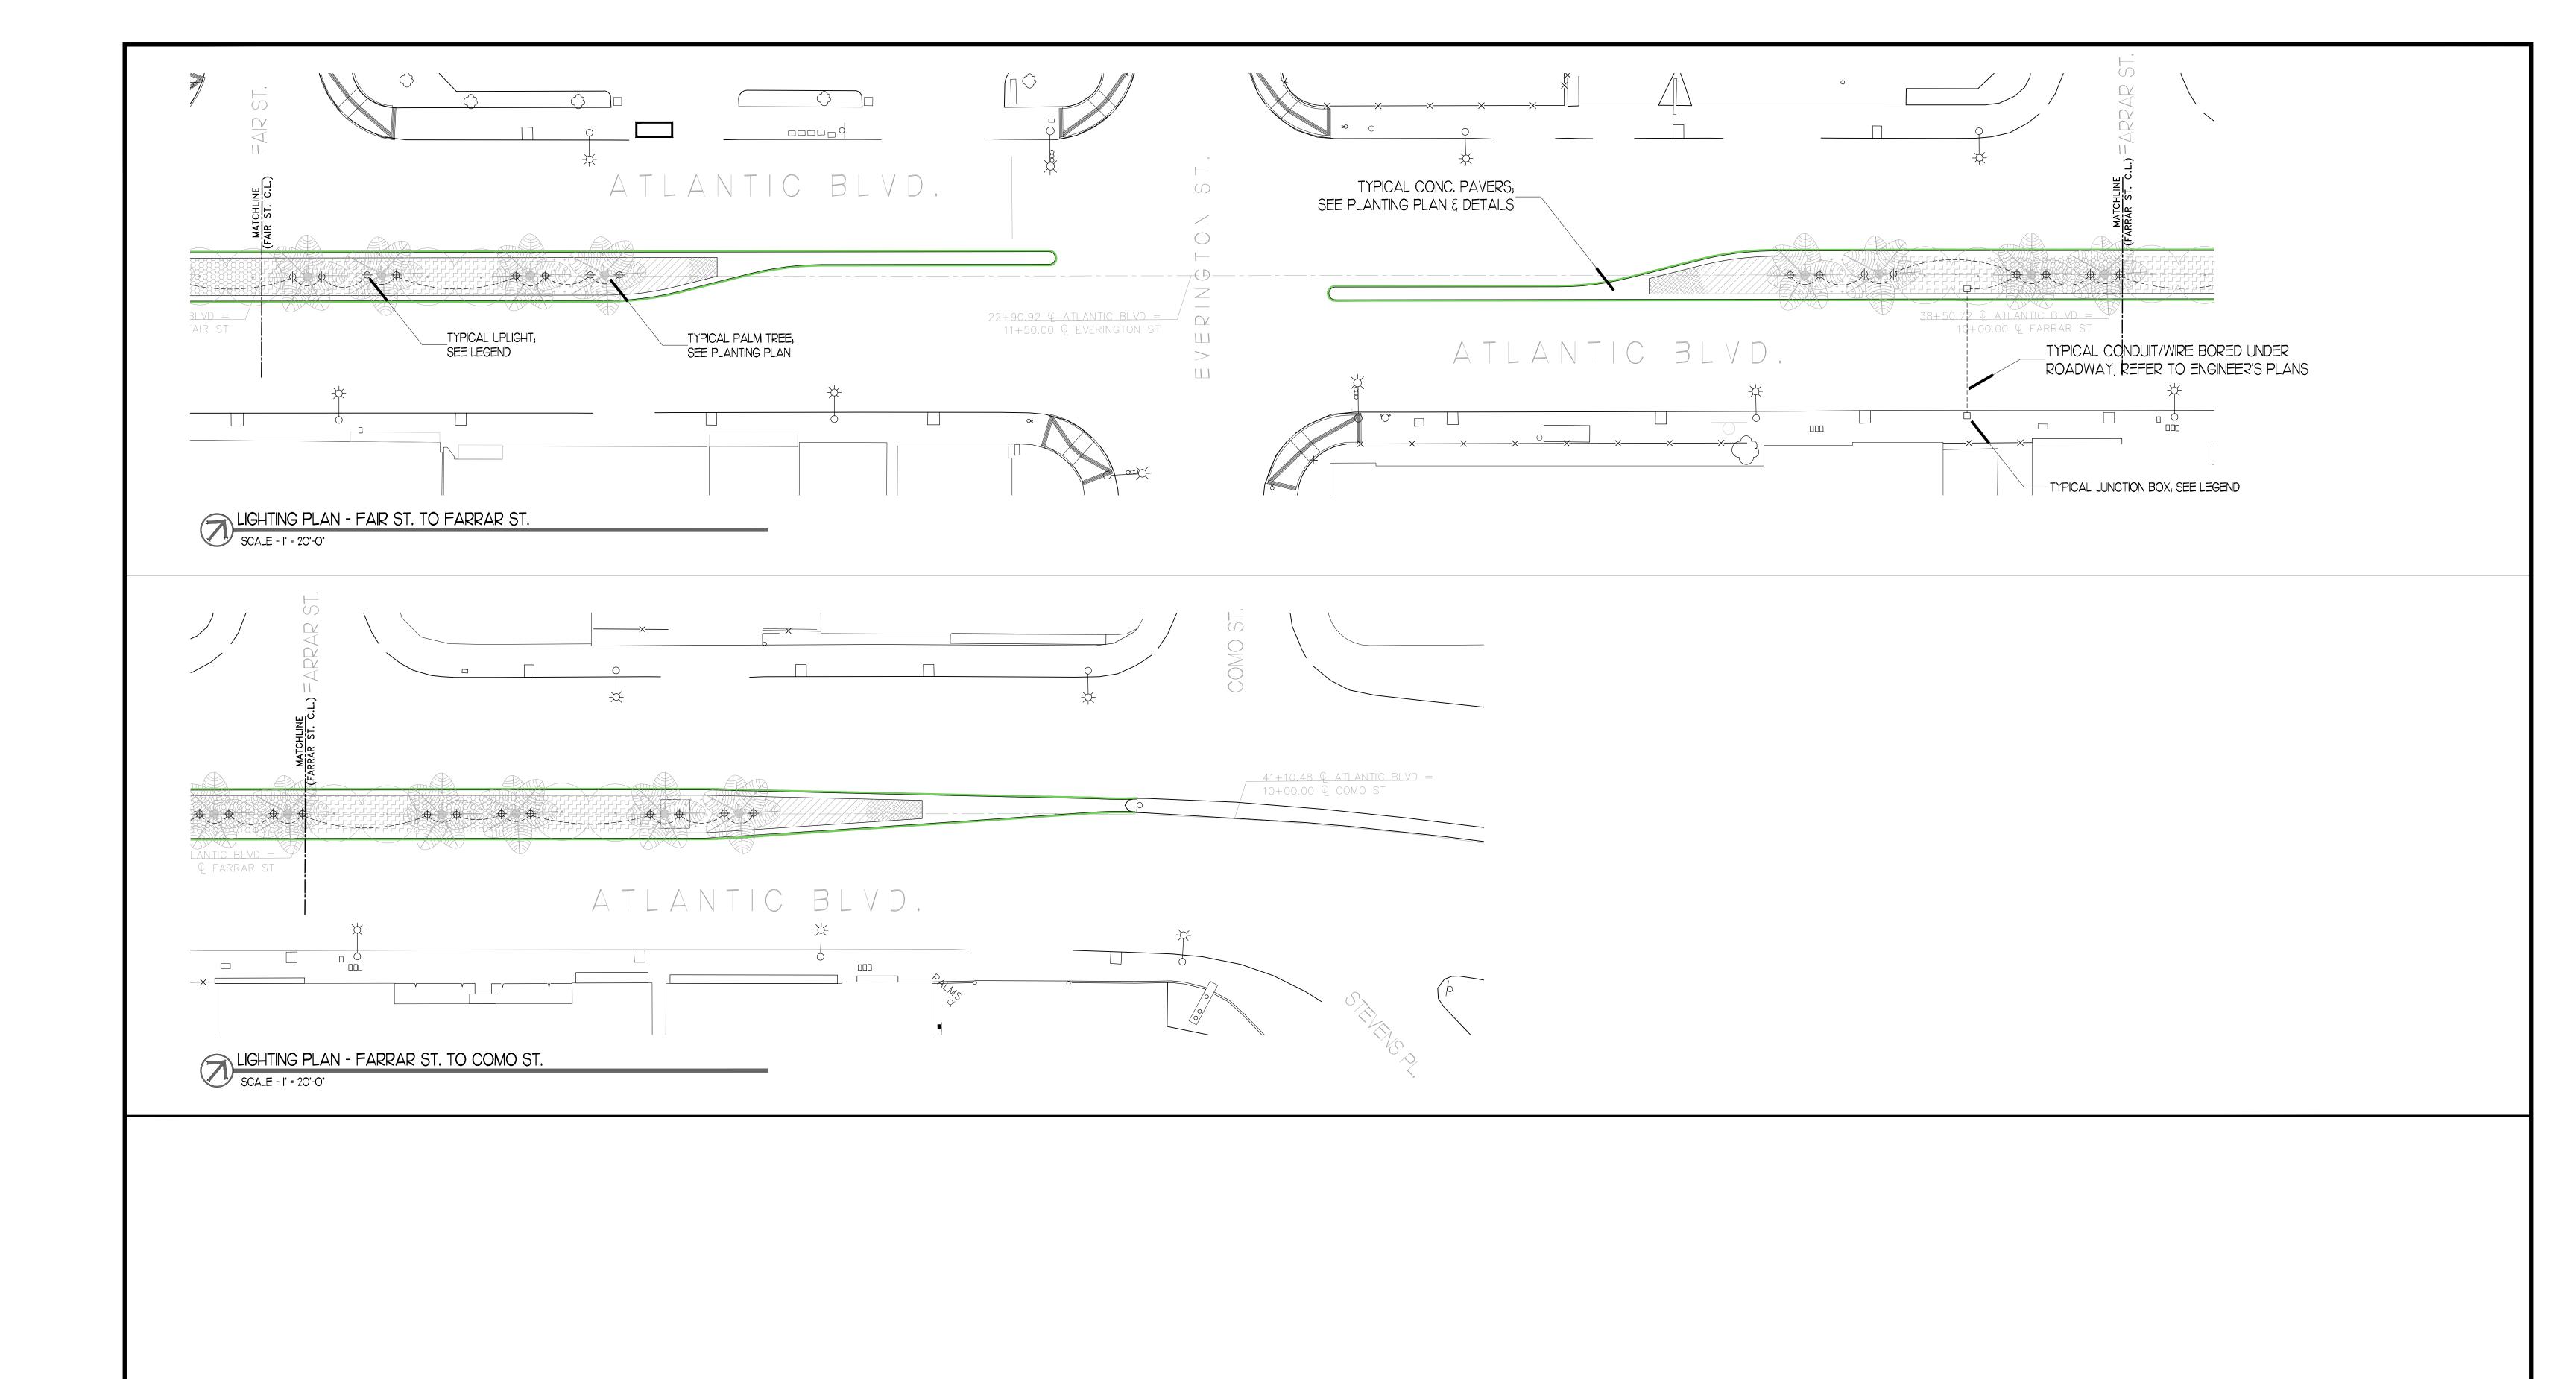

Underground Service Alert Call: TOLL FREE TWO WORKING DAYS BEFORE YOU DIG

GRAPHIC SCALE

NO.	REVISIONS	REV.	BY	APP.	BY	DATE	PLAN DATE: 09/14/18	
							PLOTTING HISTORY: 07/10/18 - Version 1 09/06/18 - Version 2 09/14/18 - Version 3	
							PROJECT FILE NO NAME: 1812 - Atlantic Blvd. Medians	SIG

 $\widetilde{\phi}/\mathsf{Robert}$ Mekjian $\setminus \widetilde{\mathfrak{f}}$ NO. 3183 ★ EXP. 05-31-20

09/14/18

LOST WEST A CALIFORNIA CORPORATION LANDSCAPE ARCHITECTURE

GARDENS ♥ PARKS ♥ CITIES PO BOX 4548 Carlsbad, CA 92018 5208 Townsend Ave. Los Angeles, CA 90041 TEL: (760) 434-5790 OR (323) 258-8214

ELECTRONICALLY APPROVED BY:		ATLA
PUBLIC WORKS & DEV. SERVICES DIRECTOR	DATE	
ELECTRONICALLY CHECKED BY:		FAIR
TITLE	DATE	SHEET

CITY OF COMMERCE PUBLIC WORKS AND ENGINEERING DEPARTMENT ANTIC BOULEVARD CORRIDOR IMPROVEMENTS LIGHTING PLAN -

R ST. C.L. TO END AT COMO ST. L-10

DRWG NO. SHEET 10 OF 10 SHEETS